

KCHA BRITTANY PARK - WINDOW REPLACEMENT



ABBREVIATIONS

& L @ # (E) C E	AND ANGLE AT DIAMETER POUND OR NUMBER EXISTING CENTERLINE PROPERTY LINE	GA GALV GB GC GL GLB GND GR GRT'D GWB	GAUGE GALVANIZED GRAB BAR GENERAL CONTRACTOR GLASS GLU-LAM BEAM GROUND GRADE GROUTED GYPSUM WALL BOARD	R or RAD RB RCP RD REF REFR REINF RELOC REQ'D RES RM RO RV RL	RADIUS RESILIENT BASE REFLECTED CEILING PLAN ROOF DRAIN REFERENCE REFRIGERATOR REINFORCED RELOCATE REQUIRED RESILIENT ROOM ROUGH OPENING ROOF VENT RAIN WATER LEADER
A.B. ABV AC ACP ACU ADJ AFF ALT ALUM APPROX ARCH	ANCHOR BOLT ABOVE AIR CONDITIONING ACOUSTIC CEILING PANEL AIR CONDITION UNIT ADJUSTABLE ABOVE FINISHED FLOOR ALTERNATE ALUMINUM APPROXIMATELY ARCHITECT, ARCHITECTURAL	HB HC HCMU HOWD HDWE HT HM HR HORIZ	HOSE BIBB HANDICAP HOLLOW CLAY MASONRY UNIT HARDWOOD HARDWARE HEIGHT HOLLOW METAL HOUR HORIZONTAL	S SA SC SCHED SECT SG SHT SIM SPEC SQ S.S. STA STD STL STN STOR STRUCT SOG SUSP SYM	SOUTH SMOKE ALARM SOLID CORE SCHEDULE SECTION SAFETY GLASS SHEET SIMILAR SPECIFICATION SQUARE STAINLESS STEEL STATION STANDARD STEEL STAIN STORAGE STRUCTURE SLAB ON GRADE SUSPENDED SYMMETRICAL
BLDG BLW BM B.O. BRS	BUILDING BELOW BEAM BOTTOM OF BACKER ROD & SEALANT	I.D. INSUL INT	INSIDE DIAMETER INSULATION INTERIOR	T, TMP T&G TEL TER THK T.O. TS TV TYP	TEMPERED TONGUE & GROOVE TELEPHONE TERRAZZO THICK TOP OF TUBE STEEL TELEVISION TYPICAL
CB CBB CEM CJ CL CLG CLR CO COL CONC COND CONT CPT CT CTR	CATCH BASIN CEMENT BACKER BOARD CEMENT CONTROL JOINT CENTERLINE CEILING CLEAR CLEAN OUT COLUMN CONCRETE CONDITION CONTINUOUS CARPET CERAMIC TILE CENTER	JAN JT KIT LAB LAM LAV LKR LOC LT LVL	JANITOR JOINT KITCHEN LABORATORY LAMINATE LAVATORY LOCKER LOCATE LIGHT LAMINATED VENEER LUMBER	UL UNO UTIL	UNDERWRITERS' LABORATORIES UNLESS NOTED OTHERWISE UTILITY
DBL DEMO DF DIA DIFF DIM DISP DN DR DS DTL DW	DOUBLE DEMOLISH DRINKING FOUNTAIN DIAMETER DIFFUSER DIMENSION DISPENSER DOWN DOOR DOWNSPOUT DETAIL DISHWASHER	M MATL MAX MC MECH MEMB MFR MIN MIR MISC MH MO MTD MTL MULL	MEN'S MATERIAL MAXIMUM MEDICINE CABINET MECHANICAL MEMBRANE MANUFACTURER MINIMUM MIRROR MISCELLANEOUS MANHOLE MASONRY OPENING MOUNTED METAL MULLION	VCT VERT VEST VIF VTR	VINYL COMPOSITION TILE VERTICAL VESTIBULE VERIFY IN FIELD VENT THRU ROOF
E EA ECS EF EL ELEC ELEV EMERG EQ EXP EXT	EAST EACH EXTERIOR COMPOSITE SIDING EXHAUST FAN EXPANSION JOINT ELEVATION ELECTRICAL ELEVATOR EMERGENCY EQUAL EXPANSION EXTERIOR	N NA NIC NOM NTS NRS	NORTH NOT APPLICABLE NOT IN CONTRACT NOMINAL NOT TO SCALE NOT RATED	W W/ WC WD WF WIN W/O WOM WM WP WR WRB WSCT WT	WEST WITH WATER CLOSET WOOD WIDE FLANGE WINDOW WITHOUT WALK OFF MAT WOMEN'S WATERPROOFING WATER RESISTANT WATER RESISTIVE BARRIER WAINSCOT WEIGHT
FBP FD FE FF FH FIN FLR F.O. FOIC FOIO FR FS FT	FIBER BOARD PANEL FLOOR DRAIN FIRE EXTINGUISHER FINISH FLOOR FIRE HYDRANT FINISH FLOOR FACE OF FURNISHED BY OWNER, INSTALL BY CONTRACTOR FURNISHED BY OWNER INSTALL BY OWNER FIRE RESISTANT FLOOR SINK FEET	OA OBS O.C. O.D. OFF OPNG OPP	OVERALL OBSOLETE ON CENTER OUTSIDE DIAMETER OFFICE OPENING OPPOSITE	PC PL PLAS PLY P.LAM PNT POC PR PSL PT PTN QT	PRECAST CONCRETE PLATE PLASTER PLYWOOD PLASTIC LAMINATE PAINT POINT OF CONNECTION PAIR PARALLEL STRAND LUMBER PRESSURE TREATED PARTITION QUARRY TILE

DRAFTING SYMBOLS

	WALL SECTION
	BLDG SECTION
	EXTERIOR ELEVATION
	INTERIOR ELEVATION
	DETAIL
	NORTH ARROW
	GRID HEAD
	ROOM TAG
	WINDOW & STOREFRONT TAG
	FLOOR, WALL, CEILING OR ROOF TAG
	CASEWORK TAG
	DOOR TAG
	KEY NOTE
	ELEVATION NOTE
	SPOT ELEVATION
	CENTERLINE
	PROPERTY LINE
	FLOOR TRANSITION
	REVISION
	BREAKLINE
	DIMENSION POINT
	ENLARGED DETAIL CALLOUT

MATERIAL SYMBOLS

	BATT INSULATION		CONCRETE		RIGID INSULATION
	EARTH		GRAVEL		WOOD
	MASONRY		PLYWOOD		STEEL



GENERAL NOTES

- MATERIALS, ASSEMBLIES AND NOTED ITEMS ARE NEW UNLESS OTHERWISE NOTED.
 - CONTRACTOR SHALL VERIFY CONDITIONS. NOTIFY THE ARCHITECT OF ANY CONDITIONS INCONSISTENT WITH THE INTENT OF THE DRAWINGS PRIOR TO STARTING OR CONTINUING WORK IN THE AREA CONCERNED.
- CODE:**
- ALL WORK SHALL CONFORM TO APPLICABLE CODES AND LOCAL BUILDING REQUIREMENTS, WHICH INCLUDE THE MOST CURRENT EDITIONS OF THE INTERNATIONAL BUILDING CODE WITH LOCAL AMENDMENTS, INTERNATIONAL MECHANICAL CODE (IMC), NATIONAL ELECTRICAL CODE (NEC), INTERNATIONAL FIRE CODE (IFC), AND WASHINGTON STATE ENERGY CODE (WEC).
 - REFER TO WINDOW SCHEDULE FOR WINDOW SIZES AND TYPES. ALL GLAZING WITHIN 18" OF INTERIOR FLOOR, EXTERIOR WALKING SURFACE OR WITHIN 24" OF A DOOR IN ANY POSITION TO BE TEMPERED GLASS UNLESS INDICATED OTHERWISE.
- DEMOLITION:**
- WHERE ITEMS ARE INDICATED ON PLANS TO BE DEMOLISHED, IT SHALL MEAN THE COMPLETE REMOVAL AND DISPOSAL OF THE ITEM INDICATED UNLESS OTHERWISE NOTED. CONTRACTOR IS RESPONSIBLE FOR REVIEW OF THE HAZARDOUS MATERIALS ABATEMENT, ARCHITECTURAL, STRUCTURAL, MECHANICAL AND ELECTRICAL DRAWINGS AND SPECIFICATIONS FOR CUTTING AND PATCHING WORK.
- DIMENSIONS:**
- DO NOT SCALE DRAWINGS.
 - VERIFY DIMENSIONS SHOWN ON DRAWINGS. USE ONLY DIMENSIONS INDICATED. PRIOR TO STARTING OR CONTINUING WORK, NOTIFY ARCHITECT OF DISCREPANCIES OR CONDITIONS INCONSISTENT WITH THE INTENT OF THE CONSTRUCTION DOCUMENTS.
 - DIMENSIONS ARE TO FACE OF CONCRETE, FACE OF MASONRY, OR FACE OF STUD, UNLESS OTHERWISE NOTED.
 - WINDOWS ARE DIMENSIONED TO CENTERLINE OF OPENING WITHIN FRAMED WALLS AND TO MASONRY OPENING WITHIN MASONRY WALLS, UNLESS OTHERWISE NOTED.
- COORDINATION:**
- COORDINATE ALL OPERATIONS WITH OWNER, SUCH AS AREAS USED FOR MATERIAL STORAGE, ACCESS TO AND FROM THE SITE, TIMING OF WORK AND REQUIREMENTS OF NOISE ORDINANCE. INSTALL DUST AND NOISE BARRIERS AS REQUIRED TO PROTECT EXISTING ADJACENT BUILDINGS AND OCCUPANTS AND TO MAINTAIN AN ENVIRONMENT SUITABLE TO PERMIT CONTINUED OCCUPANCY OF SUBJECT AND ADJACENT BUILDINGS.
 - REVIEW DEMOLITION DRAWINGS. PATCH AND REPAIR ALL EXISTING SURFACES AFFECTED BY DEMOLITION WORK.
 - VERIFY LOCATIONS OF EXISTING UTILITIES. CAP, MARK AND PROTECT AS NECESSARY TO COMPLETE THE WORK.
 - "REMOVE" MEANS TO COMPLETELY AND PERMANENTLY REMOVE FROM THE PROJECT.

PROJECT INFORMATION

PROJECT OWNER:
KING COUNTY HOUSING AUTHORITY (KCHA)

PROJECT MANAGER:
MICHAEL CUADRA

PROJECT ADDRESS:
18265 1ST AVE S
NORMANDY PARK, WA 98148

DESIGN TEAM

ARCHITECT:
SHKS ARCHITECTS
1050 NORTH 38TH ST
SEATTLE, WA 98103
TEL: 206.675.9151
CONTACT: LEVI JETTE
EMAIL: levij@shksarchitects.com

ZONING ANALYSIS

PARCEL NUMBER: 312304-9060

LEGAL DESCRIPTION: E 1/2 OF S 1/4 OF SE 1/4 OF SE 1/4 OF NE 1/4 LESS CO RD

LOT AREA: 46,292 SQFT (1.06 ACRES)

ZONE: RM-1800

CURRENT USE: APARTMENT

YEAR BUILT: 1970

(E) BLDG AREA: 22,249 SQFT

(E) LOT COVERAGE: 11,567 SQFT

(E) BLDG HEIGHT: 35' +/-

(E) STORIES: 3

12. REQUIRED SETBACKS: NO CHANGE

APPLICABLE CODES

- NORMANDY PARK MUNICIPAL CODE
- 2021 INTERNATIONAL BUILDING CODE W/ WASHINGTON STATE AMENDMENTS
- 2021 EXISTING BUILDING CODE
- 2021 WASHINGTON STATE ENERGY CODE
- ALL CODES ADOPTED AND AMENDED BY THE STATE BUILDING CODE COUNCIL


KCHA
BRITTANY PARK
WINDOW
REPLACEMENT

BID SET

18265 1ST AVE S
NORMANDY PARK, WA 98148

Drawn by:	_____	LJ
Checked:	_____	NM
Date:	_____	12/13/2024
Scale:	_____	As indicated
Revisions:		
No.	Date	Remarks

COVER SHEET
A0.0

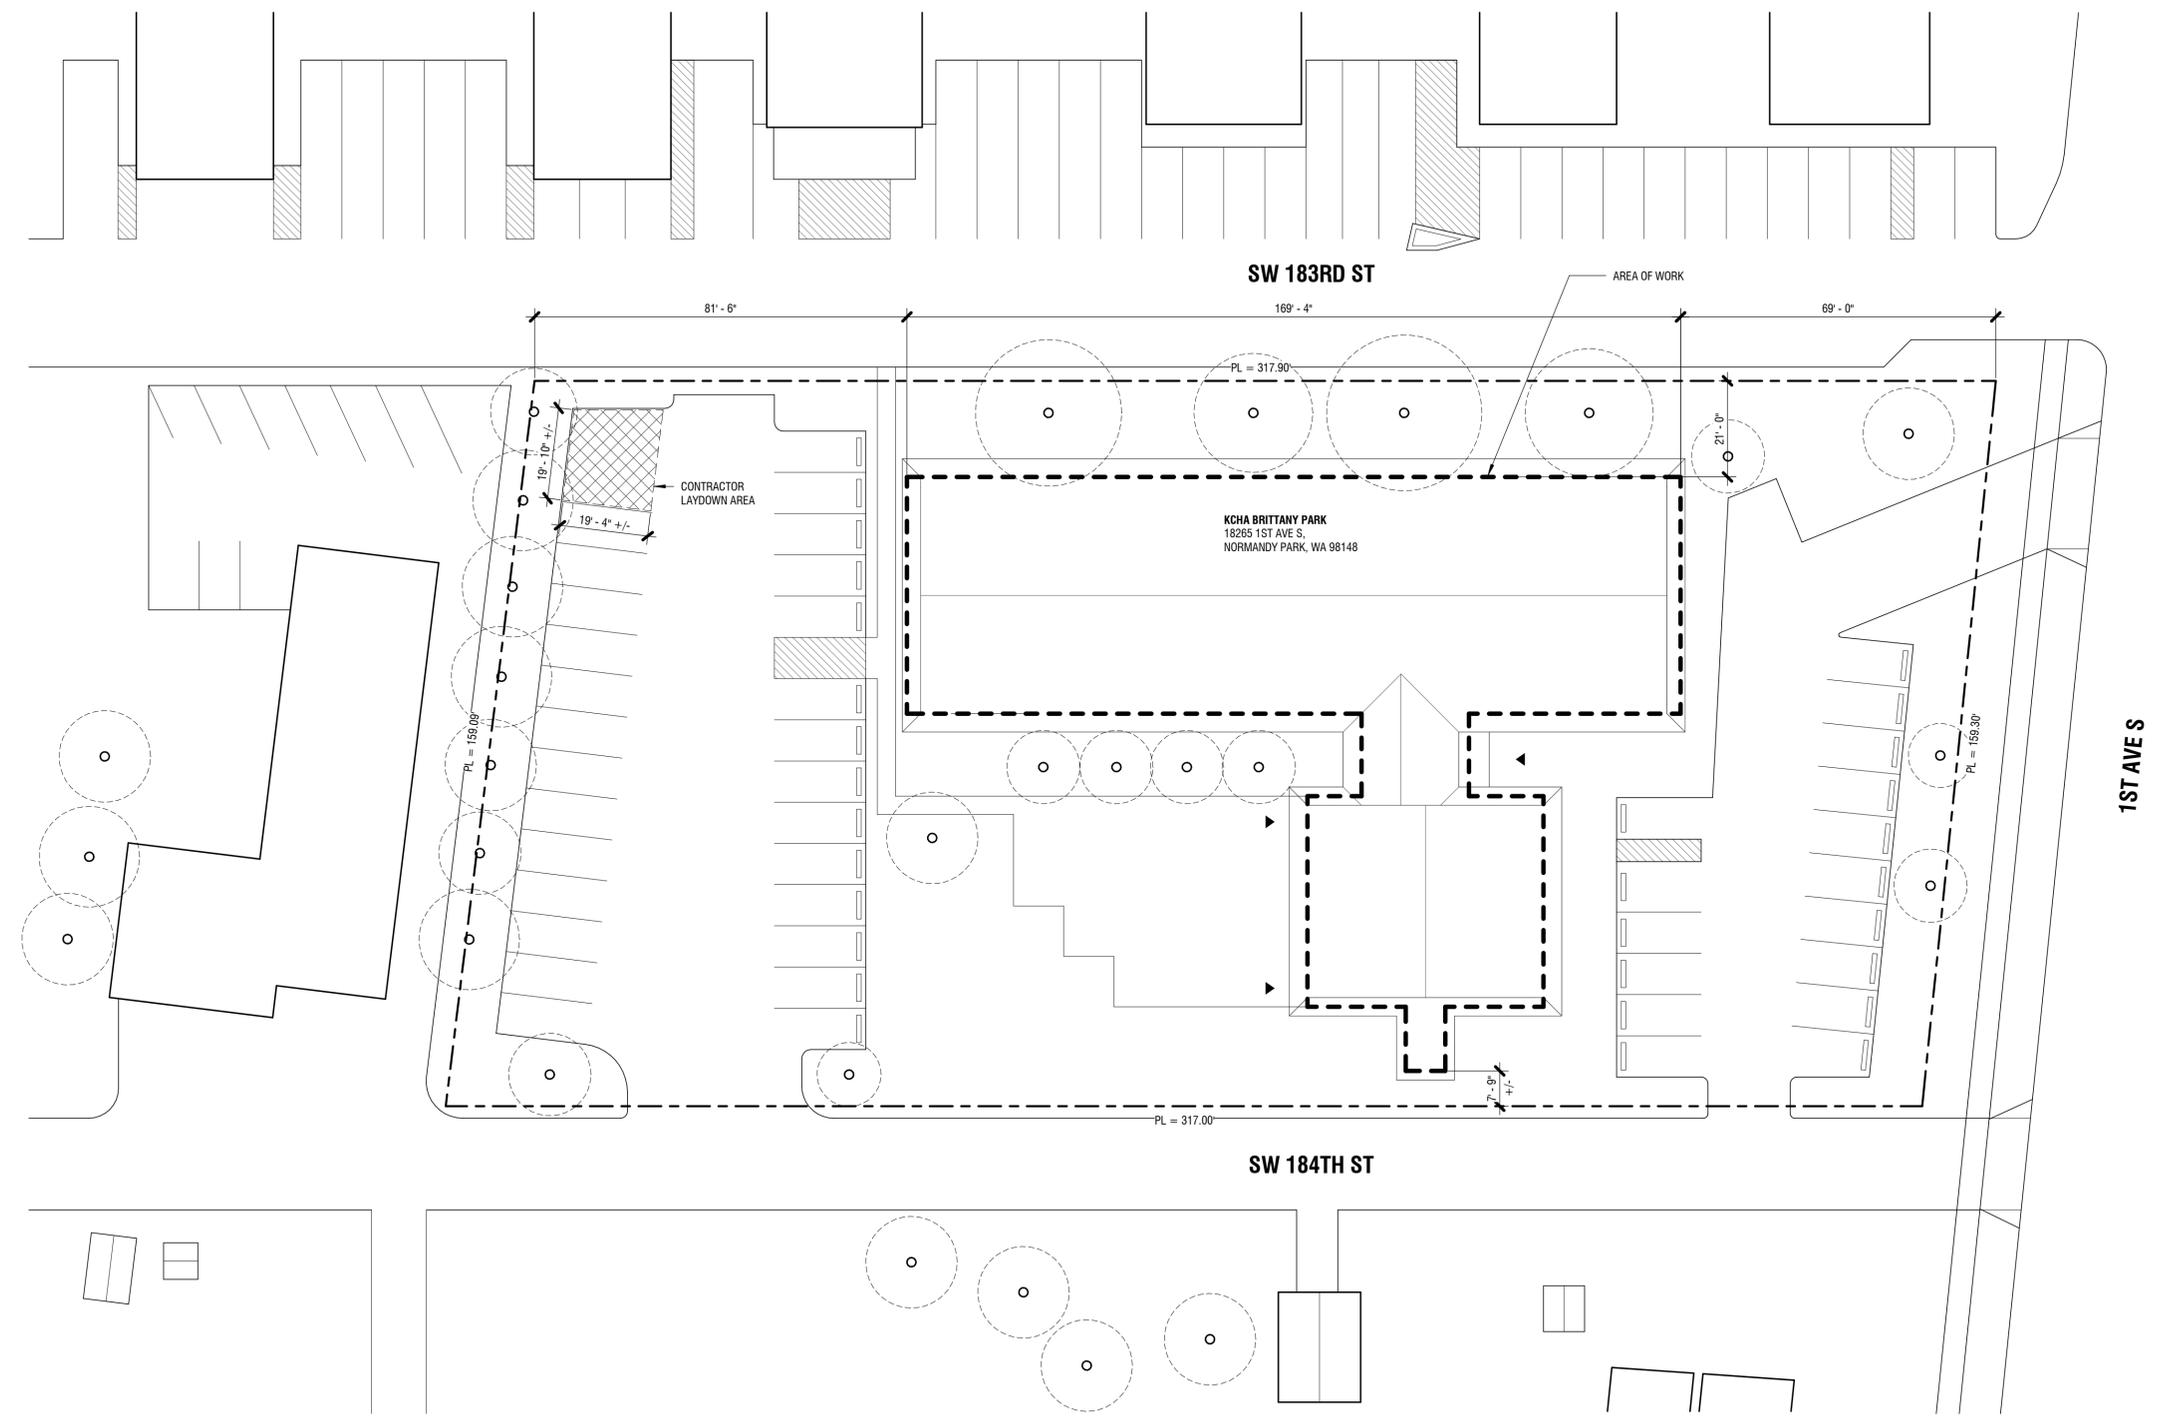

KCHA
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WINDOW
REPLACEMENT

BID SET
18265 1ST AVE S
NORMANDY PARK, WA 98148

Drawn by:	LJ	
Checked:	NM	
Date:	12/13/2024	
Scale:	1" = 20'-0"	
Revisions:		
No.	Date	Remarks

1 SITE PLAN
1" = 20'-0"

- GENERAL NOTES**
1. THE CONTRACTOR IS RESPONSIBLE FOR VERIFYING EXISTING CONDITIONS PRIOR TO BIDDING AND MUST PROTECT THOSE CONDITIONS DURING CONSTRUCTION.
 2. ALL EXISTING TREES AND VEGETATION TO BE RETAINED.
 3. ALL LANDSCAPE / UNIMPROVED AREAS DISTURBED SHALL BE RESTORED TO THEIR EXISTING CONDITIONS. HYDROSEED ALL GRASS AREAS DISTURBED.
 4. OWNER WILL PROVIDE TREE PRUNING AS NECESSARY.
 5. CONDUCT WORK AND TAKE PREVENTATIVE MEASURES SUCH THAT DUST OR OTHER PARTICULATE MATTER IN THE PROJECT AREA SHALL NOT BECOME OBJECTIONABLE TO THE OWNER AND THAT THE CONSTRUCTION SITE MEETS THE REQUIREMENTS OF REGULATIONS 1 AND 2 OF THE PUGET SOUND AIR POLLUTION CONTROL AUTHORITY.

KEYNOTE LEGEND	
MARK	KEYNOTE TEXT
7.1	COAT LIQUID-APPLIED FLASHING AT ROUGH OPENING, DO NOT APPLY LIQUID-APPLIED FLASHING WHERE IT WILL BE EXPOSED AFTER WINDOW INSTALL
8.1	REMOVE AND REPLACE WINDOW PER SCHEDULE, INSTALL EXTERIOR WATERPROOFING, MOISTURE RESISTANT DRYWALL, INTERIOR TRIM, AND FINISH PER DETAIL
12.1	REMOVE AND REPLACE VERTICAL LOUVER BLINDS AT WINDOW

PLAN LEGEND
— (E) WALL


- GENERAL NOTES:**
- BUILDING OCCUPIED DURING CONSTRUCTION
 - IF WATER DAMAGE IS OBSERVED IN THE COURSE OF THE PROJECT, NOTIFY OWNER IMMEDIATELY.
 - ALL DIMENSIONS ARE APPROXIMATE. VERIFY IN FIELD.
 - PATCH, REPAIR, AND PAINT INTERIOR FINISHES DAMAGED DURING CONSTRUCTION TO MATCH (E) CONDITION.



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1 FIRST FLOOR PLAN
1/8" = 1'-0"



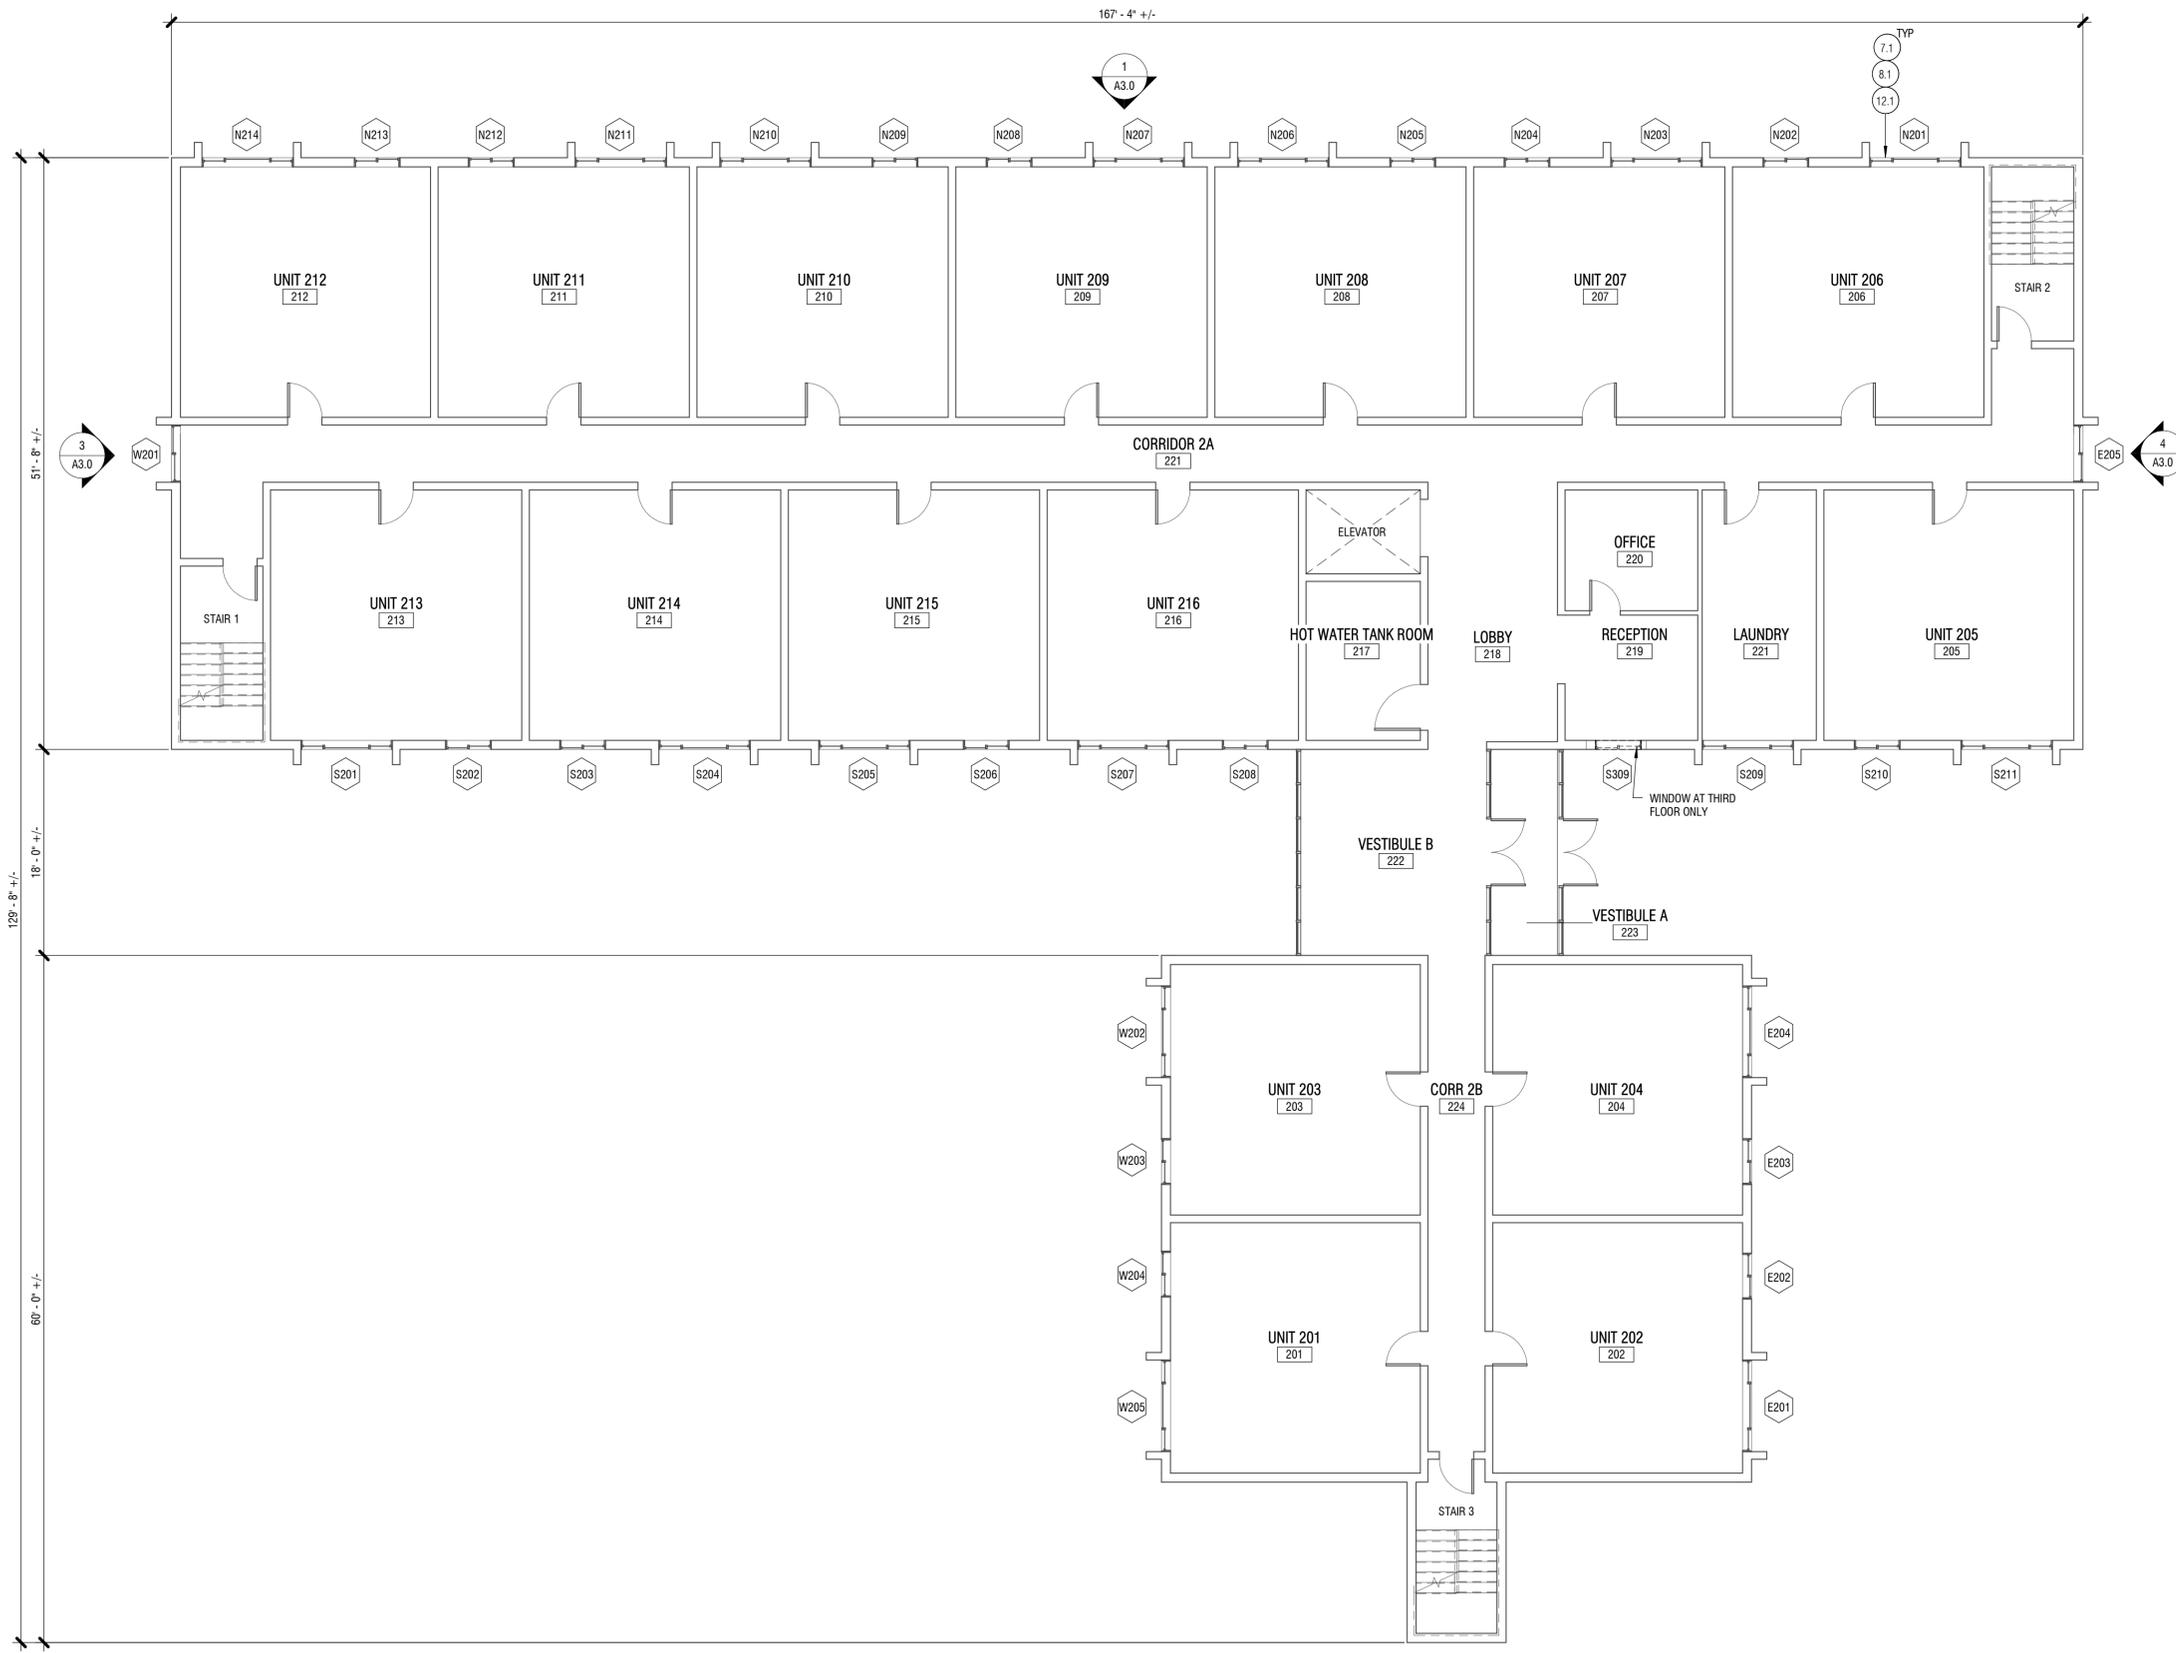

KEYNOTE LEGEND	
MARK	KEYNOTE TEXT
7.1	COAT LIQUID-APPLIED FLASHING AT ROUGH OPENING, DO NOT APPLY LIQUID-APPLIED FLASHING WHERE IT WILL BE EXPOSED AFTER WINDOW INSTALL
8.1	REMOVE AND REPLACE WINDOW PER SCHEDULE, INSTALL EXTERIOR WATERPROOFING, MOISTURE RESISTANT DRYWALL, INTERIOR TRIM, AND FINISH PER DETAIL
12.1	REMOVE AND REPLACE VERTICAL LOUVER BLINDS AT WINDOW

PLAN LEGEND
— (E) WALL

- GENERAL NOTES:**
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 - PATCH, REPAIR, AND PAINT INTERIOR FINISHES DAMAGED DURING CONSTRUCTION TO MATCH (E) CONDITION.

KCHA
BRITTANY PARK
WINDOW
REPLACEMENT


BID SET
18265 1ST AVE S
NORMANDY PARK, WA 98148

Drawn by:	LJ
Checked:	NM
Date:	12/13/2024
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Revisions:	
No. Date	Remarks


SECOND & THIRD
FLOOR PLAN
A2.2



1 NORTH ELEVATION
1/8" = 1'-0"

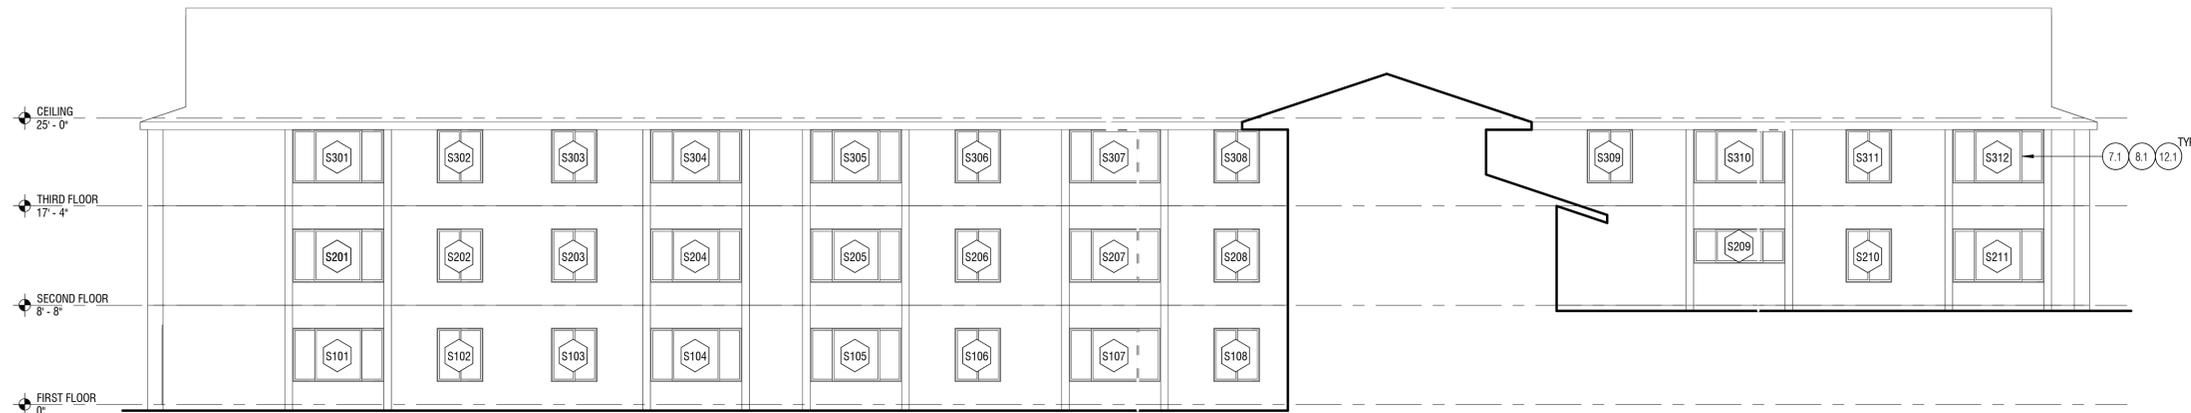

2 SOUTH ELEVATION
1/8" = 1'-0"

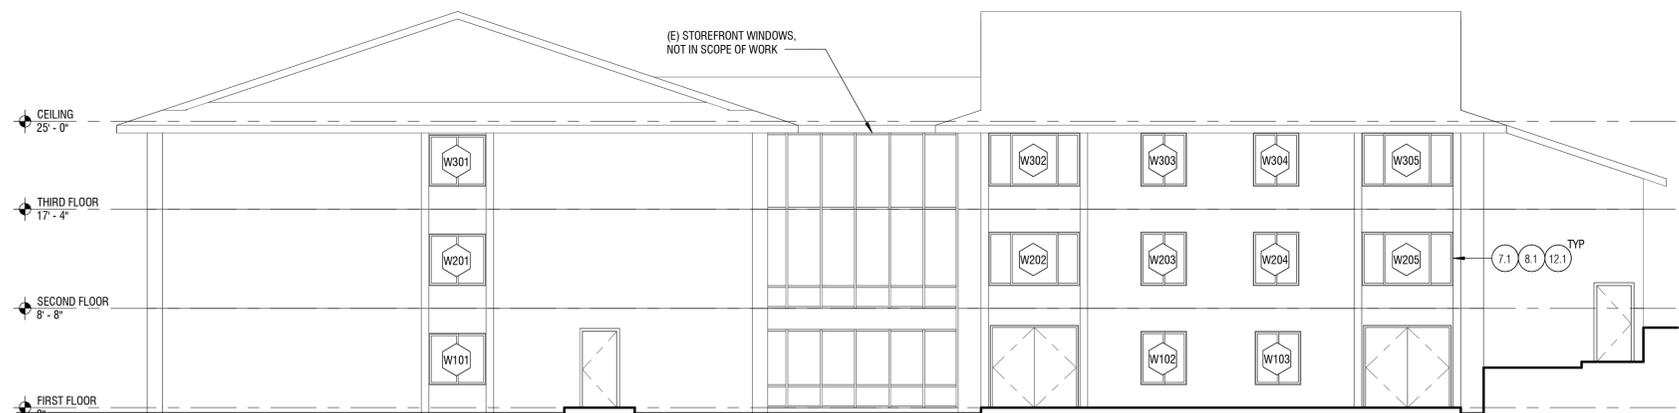

3 WEST ELEVATION
1/8" = 1'-0"





4 EAST ELEVATION
1/8" = 1'-0"

KEYNOTE LEGEND

MARK	KEYNOTE TEXT
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KCHA
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WINDOW
REPLACEMENT

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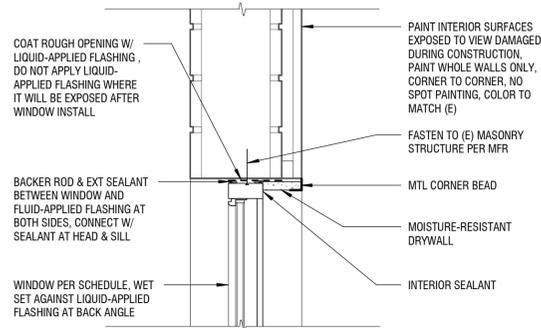
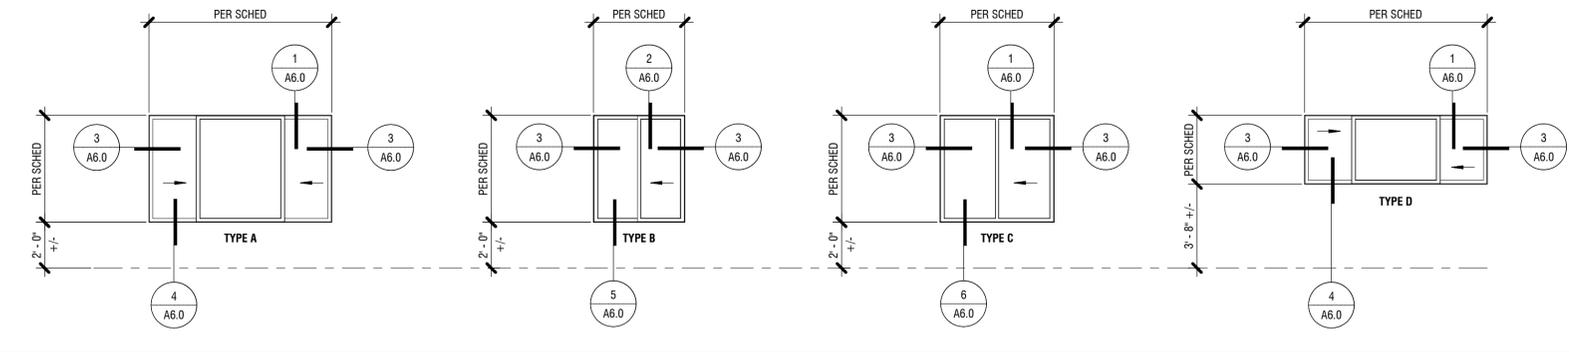
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Checked: _____ NM
Date: 12/13/2024
Scale: As indicated

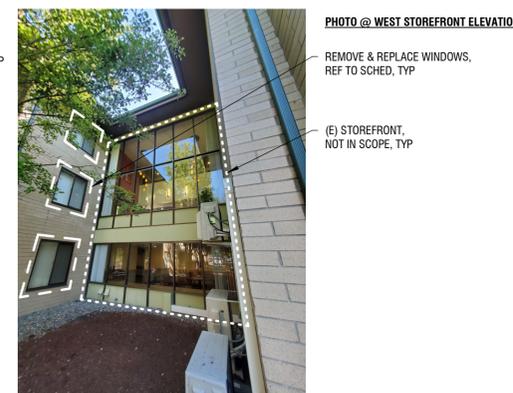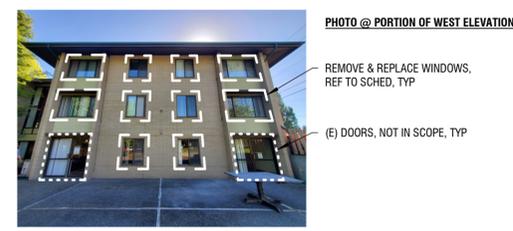Revisions:
No. Date Remarks


EXTERIOR
ELEVATIONS &
PHOTOS
A3.0

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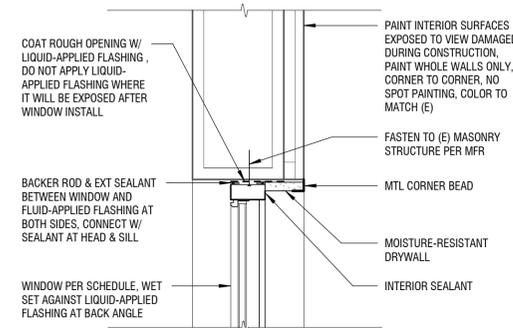
WINDOW LEGEND




1 TYPE A, C & D WINDOW HEAD
1 1/2" = 1'-0"

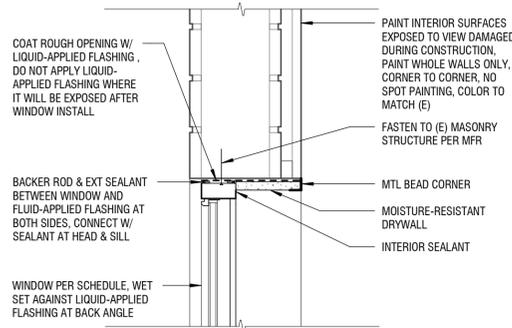


2 TYPE B WINDOW HEAD
1 1/2" = 1'-0"




3 WINDOW JAMB
1 1/2" = 1'-0"

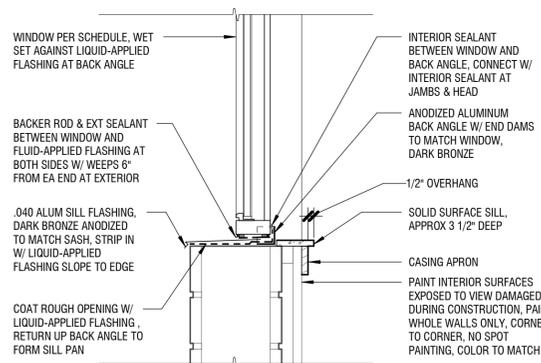


4 TYPE A & D SILL DETAIL
1 1/2" = 1'-0"

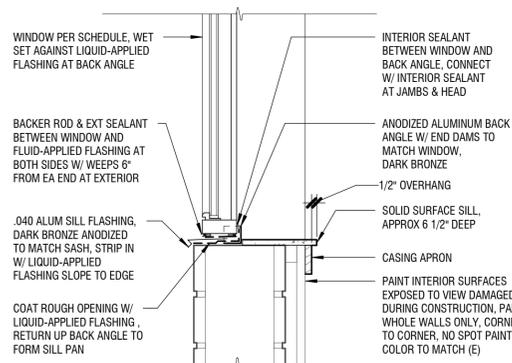

5 TYPE B SILL DETAIL
1 1/2" = 1'-0"

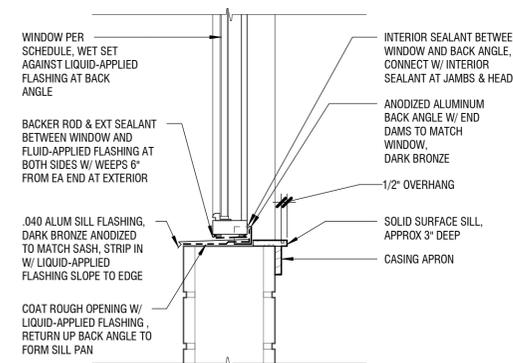

6 TYPE C SILL DETAIL
1 1/2" = 1'-0"

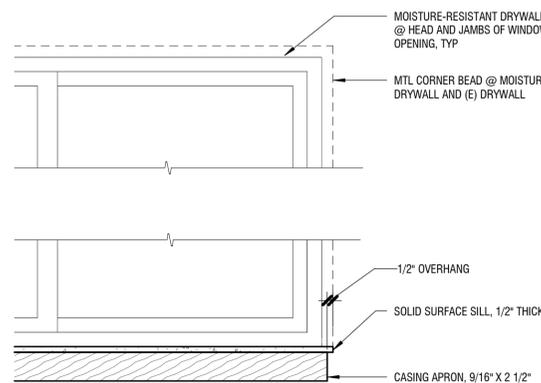

7 TYP CASING ELEVATION
1 1/2" = 1'-0"


WINDOW SCHEDULE

MARK	TYPE	WIDTH	HEIGHT	U-VALUE (MAX)	SHGC (MAX)	STC RATING (MIN)	COMMENTS
E201	A	8'-0"	4'-8"	0.28	0.38	32	
E202	B	4'-0"	4'-8"	0.28	0.38	32	
E203	B	4'-0"	4'-8"	0.28	0.38	32	
E204	A	8'-0"	4'-8"	0.28	0.38	32	
E205	C	5'-0"	4'-6"	0.28	0.38	32	INTERIOR TILE SILL, DETAIL SIM TO S/A
E301	A	8'-0"	4'-8"	0.28	0.38	32	
E302	B	4'-0"	4'-8"	0.28	0.38	32	
E303	B	4'-0"	4'-8"	0.28	0.38	32	
E304	A	8'-0"	4'-8"	0.28	0.38	32	
E305	C	5'-0"	4'-6"	0.28	0.38	32	
N101	A	8'-0"	4'-8"	0.28	0.38	32	
N102	B	4'-0"	4'-8"	0.28	0.38	32	
N103	A	8'-0"	4'-8"	0.28	0.38	32	
N104	B	4'-0"	4'-8"	0.28	0.38	32	
N105	B	4'-0"	4'-8"	0.28	0.38	32	
N106	A	8'-0"	4'-8"	0.28	0.38	32	
N107	B	4'-0"	4'-8"	0.28	0.38	32	
N108	B	4'-0"	4'-8"	0.28	0.38	32	
N109	A	8'-0"	4'-8"	0.28	0.38	32	
N110	A	8'-0"	4'-8"	0.28	0.38	32	
N111	B	4'-0"	4'-8"	0.28	0.38	32	
N112	B	4'-0"	4'-8"	0.28	0.38	32	
N113	A	8'-0"	4'-8"	0.28	0.38	32	
N201	A	8'-0"	4'-8"	0.28	0.38	32	
N202	B	4'-0"	4'-8"	0.28	0.38	32	
N203	A	8'-0"	4'-8"	0.28	0.38	32	
N204	B	4'-0"	4'-8"	0.28	0.38	32	
N205	B	4'-0"	4'-8"	0.28	0.38	32	
N206	A	8'-0"	4'-8"	0.28	0.38	32	
N207	A	8'-0"	4'-8"	0.28	0.38	32	
N208	B	4'-0"	4'-8"	0.28	0.38	32	
N209	B	4'-0"	4'-8"	0.28	0.38	32	
N210	A	8'-0"	4'-8"	0.28	0.38	32	
N211	A	8'-0"	4'-8"	0.28	0.38	32	
N212	B	4'-0"	4'-8"	0.28	0.38	32	
N213	B	4'-0"	4'-8"	0.28	0.38	32	
N214	A	8'-0"	4'-8"	0.28	0.38	32	
N301	A	8'-0"	4'-8"	0.28	0.38	32	
N302	B	4'-0"	4'-8"	0.28	0.38	32	
N303	A	8'-0"	4'-8"	0.28	0.38	32	
N304	B	4'-0"	4'-8"	0.28	0.38	32	
N305	B	4'-0"	4'-8"	0.28	0.38	32	
N306	A	8'-0"	4'-8"	0.28	0.38	32	
N307	A	8'-0"	4'-8"	0.28	0.38	32	
N308	B	4'-0"	4'-8"	0.28	0.38	32	
N309	B	4'-0"	4'-8"	0.28	0.38	32	
N310	A	8'-0"	4'-8"	0.28	0.38	32	
N311	A	8'-0"	4'-8"	0.28	0.38	32	
N312	B	4'-0"	4'-8"	0.28	0.38	32	
N313	B	4'-0"	4'-8"	0.28	0.38	32	
N314	A	8'-0"	4'-8"	0.28	0.38	32	

- WINDOW NOTES:**
- VERIFY EXISTING OPERABLE DIRECTIONS AND PROVIDE REPLACEMENT WINDOWS TO MATCH. DIMENSIONS SHOW ARE FOR REFERENCE ONLY. CONTRACTOR TO FIELD VERIFY ACTUAL EXISTING OPENING DIMENSIONS AFTER OPENING MODIFICATIONS.
 - GLAZING SHALL BE LABELED AND NFRC CERTIFIED PER MFR, AND HAVE A U-VALUE, SHGC, AND STC RATING PER THE SCHEDULE.
 - ALL GLAZING WITHIN 18" OF INTERIOR FLOOR, EXTERIOR WALKING SURFACE, OR WITHIN 24" OF A DOOR IN ANY POSITION TO BE SAFETY/TEMPERED GLASS PER CODE.
 - PROVIDE CONTINUOUS AIR SEAL AT ALL WINDOWS.
 - AT OPERABLE WINDOWS, OPERABLE SASH TO MATCH EXISTING WINDOW.
 - PROVIDE WINDOW OPENING CONTROL DEVICE WHERE WINDOW SILL IS LESS THAN 36" ABOVE THE FINISHED FLOOR AND MORE THAN 72" ABOVE FINISHED GRADE AT THE BUILDING EXTERIOR.
 - SCREENS TO BE PROVIDED WITH ALL OPERABLE WINDOWS.
 - VERTICAL LOUVER BLINDS TO BE PROVIDED AT ALL WINDOWS.

WINDOW SCHEDULE

MARK	TYPE	WIDTH	HEIGHT	U-VALUE (MAX)	SHGC (MAX)	STC RATING (MIN)	COMMENTS
S101	A	8'-0"	4'-8"	0.28	0.38	32	
S102	B	4'-0"	4'-8"	0.28	0.38	32	
S103	B	4'-0"	4'-8"	0.28	0.38	32	
S104	A	8'-0"	4'-8"	0.28	0.38	32	
S105	A	8'-0"	4'-8"	0.28	0.38	32	
S106	B	4'-0"	4'-8"	0.28	0.38	32	
S107	A	8'-0"	4'-8"	0.28	0.38	32	
S108	B	4'-0"	4'-8"	0.28	0.38	32	
S201	A	8'-0"	4'-8"	0.28	0.38	32	
S202	B	4'-0"	4'-8"	0.28	0.38	32	
S203	B	4'-0"	4'-8"	0.28	0.38	32	
S204	A	8'-0"	4'-8"	0.28	0.38	32	
S205	A	8'-0"	4'-8"	0.28	0.38	32	
S206	B	4'-0"	4'-8"	0.28	0.38	32	
S207	A	8'-0"	4'-8"	0.28	0.38	32	
S208	B	4'-0"	4'-8"	0.28	0.38	32	
S209	D	8'-0"	3'-0"	0.28	0.38	32	
S210	B	4'-0"	4'-8"	0.28	0.38	32	
S211	A	8'-0"	4'-8"	0.28	0.38	32	
S301	A	8'-0"	4'-8"	0.28	0.38	32	
S302	B	4'-0"	4'-8"	0.28	0.38	32	
S303	B	4'-0"	4'-8"	0.28	0.38	32	
S304	A	8'-0"	4'-8"	0.28	0.38	32	
S305	A	8'-0"	4'-8"	0.28	0.38	32	
S306	B	4'-0"	4'-8"	0.28	0.38	32	
S307	A	8'-0"	4'-8"	0.28	0.38	32	
S308	B	4'-0"	4'-8"	0.28	0.38	32	
S309	B	4'-0"	4'-8"	0.28	0.38	32	
S310	A	8'-0"	4'-8"	0.28	0.38	32	
S311	B	4'-0"	4'-8"	0.28	0.38	32	
S312	A	8'-0"	4'-8"	0.28	0.38	32	
W101	C	5'-0"	4'-6"	0.28	0.38	32	
W102	B	4'-0"	4'-8"	0.28	0.38	32	
W103	B	4'-0"	4'-8"	0.28	0.38	32	
W201	C	5'-0"	4'-6"	0.28	0.38	32	
W202	A	8'-0"	4'-8"	0.28	0.38	32	
W203	B	4'-0"	4'-8"	0.28	0.38	32	
W204	B	4'-0"	4'-8"	0.28	0.38	32	
W205	A	8'-0"	4'-8"	0.28	0.38	32	
W301	C	5'-0"	4'-6"	0.28	0.38	32	
W302	A	8'-0"	4'-8"	0.28	0.38	32	
W303	B	4'-0"	4'-8"	0.28	0.38	32	
W304	B	4'-0"	4'-8"	0.28	0.38	32	
W305	A	8'-0"	4'-8"	0.28	0.38	32	

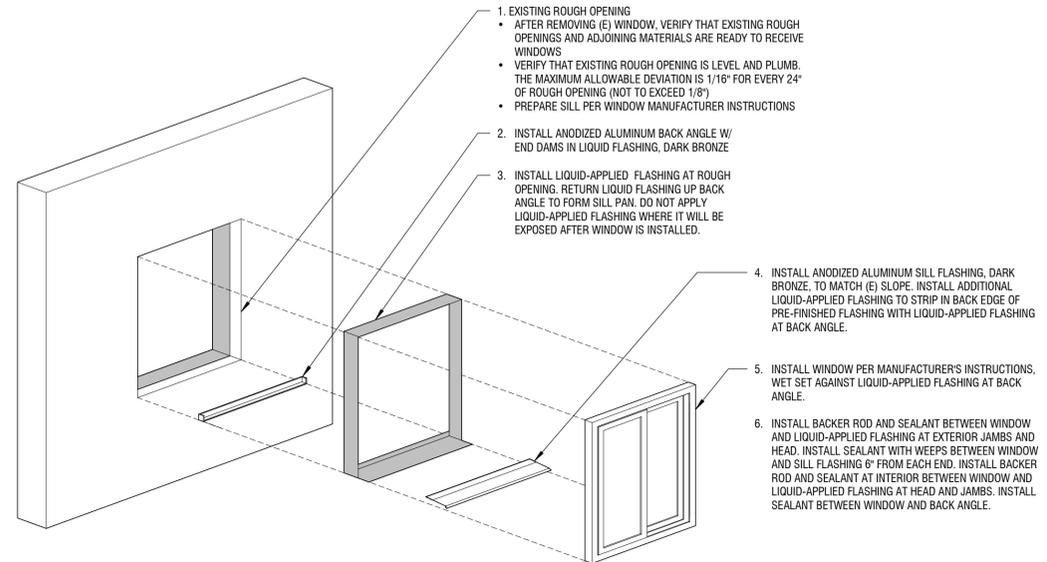

8 WINDOW ASSEMBLY
1/2" = 1'-0"

KCHA
BRITTANY PARK
WINDOW
REPLACEMENT

BID SET

18265 1ST AVE S
NORMANDY PARK, WA 98148

Drawn by: L/J/NA
Checked: NM
Date: 12/13/2024
Scale: As indicated
Revisions:
No. Date Remarks

SCHEDULE &
DETAILS
A6.0

Thermally Improved Aluminum | A250


Horizontal Sliding Window

Block Frame


CAD File Scale	View	File Name	Units
NTS	Horizontal & Vertical	Aluminum_TIE_1120_HV_Block	Inch

More Technical Documents can be found at milgard.com/professionals
Due to continual research and development, details may be changed at any time. ©2013 Milgard Mfg.

HORIZONTAL SLIDER SERIES 1120

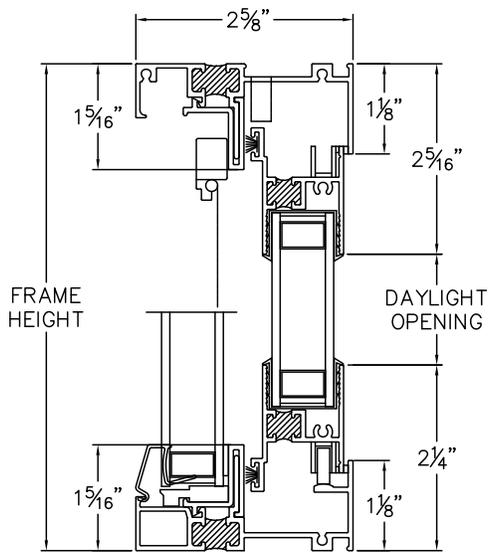

HEAD & SILL

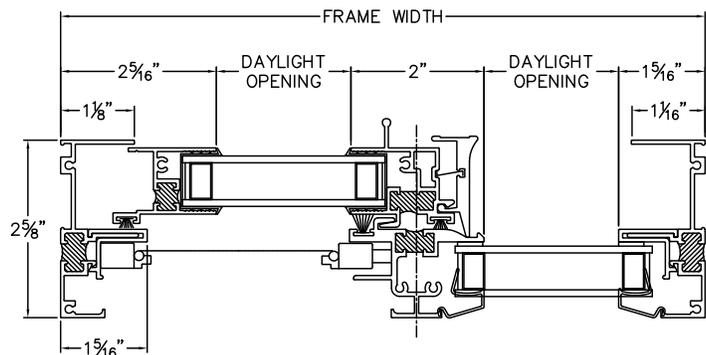



JAMBS

Revit, SketchUp, .PDF and .DWG files can be accessed at milgard.com/professionals/technical-resources


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V300/V250 Horizontal Sliders

MILGARD

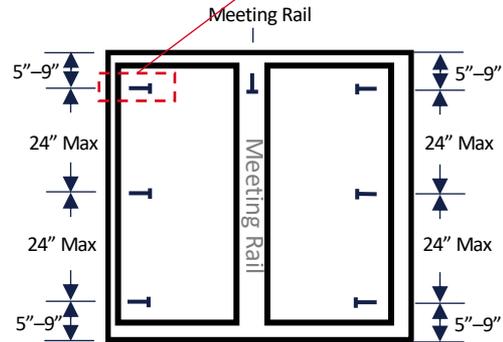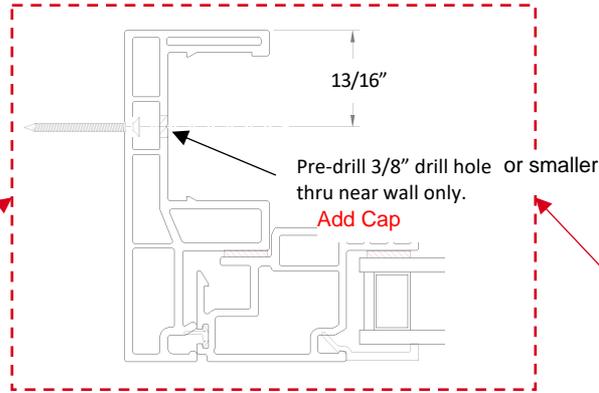

Drive minimum QTY 7X #8-15 x 2" zinc coated flat head wood screws at designated locations flush with inner wall. Add additional fasteners as necessary to meet the spacing criteria. Use a Tapcon type screw when fastening to brick

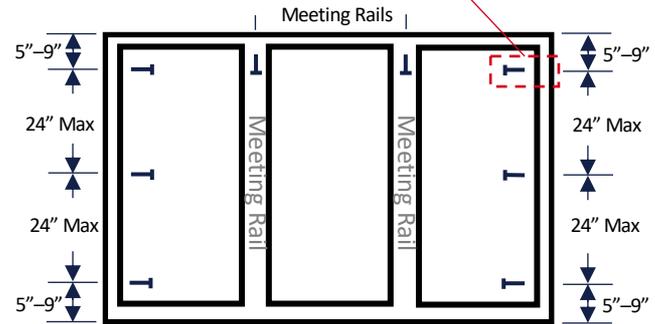

Drive minimum QTY 8X #8-15 x 2" zinc coated flat head wood screws at designated locations flush with inner wall. Add additional fasteners as necessary to meet the spacing criteria. use a Tapcon type screw when fastening to brick