

CAPITAL CONSTRUCTION DEPARTMENT 700 ANDOVER PARK WEST - SUITE C * SEATTLE, WA 98188

ADDENDUM:		2	TODAY'S DATE	03.30.23					
PROJECT NAME:	NORTHWOOD	NORTHWOOD SQUARE SITE AND STORAGE							
CONTACT / TITLE: PHONE / EMAIL:	Amy Kurtz 206-574-1283	PROJECT I	MANAGER CHA.org						
This Addendum is us	nis Addendum is used to Identify Items in the Original Documents with Action as Follows:								
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END OF ADDENDA # 2


KCHA NORTHWOOD SQUARE - SITE & STORAGE


ADDDEVIATIONS

	AND	GA	GAUGE	QT	QUARRY TILE
	ANGLE	GALV	GALVANIZED		
	AT DIAMETER	GB GL	GRAB BAR GLASS	R or RAD	RADIUS
	POUND OR NUMBER	GLB	GLU-LAM BEAM	RB	RESILIENT BASE
	EXISTING	GND	GROUND	RCP RD	REFLECTED CEILING PLAN ROOF DRAIN
	CENTERLINE	GR	GRADE	REF	REFERENCE
		GRT'D	GROUTED	REFR	REFRIGERATOR
3.	ANCHOR BOLT	GWB	GYPSUM WALL BOARD	REINF	REINFORCED
V	ABOVE			RELOC	RELOCATE
	AIR CONDITIONING	HB	HOSE BIBB	REQ'D	REQUIRED
T	ACOUSTIC CEILING TILE	HC	HANDICAP	RES	RESILIENT
U	AIR CONDITION UNIT	HCMU HDWD	HOLLOW CLAY MASONRY UNIT HARDWOOD	RM	ROOM
J -	ADJUSTABLE	HDWE	HARDWARE	RO RV	ROUGH OPENING ROOF VENT
F T	ABOVE FINISHED FLOOR ALTERNATE	HT	HEIGHT	RL	RAIN WATER LEADER
u UM	ALUMINUM	НМ	HOLLOW METAL	1112	TO THE TOTAL THE TENDER TO THE
PROX	APPROXIMATELY	HR	HOUR	c	SOUTH
I IIOX	74 THOMINITEET	HORIZ	HORIZONTAL	S Sa	SMOKE ALARM
DG	DI III DINC			SC	SOLID CORE
N N	BUILDING BELOW	I.D.	INSIDE DIAMETER	SCHED	SCHEDULE
	BOTTOM OF	INSUL	INSULATION	SECT	SECTION
•	BOTTOWI OI	INT	INTERIOR	SG	SAFETY GLASS
			IANUTOR	SHT	SHEET
	CATCH BASIN	JAN	JANITOR	SIM	SIMILAR
3	CEMENT BACKER BOARD	JT	JOINT	SPEC	SPECIFICATION
M	CEMENT	KIT	KITCHEN	SQ	SQUARE
	CONTROL JOINT CENTERLINE			S.S.	STAINLESS STEEL
G	CEILING	LAB	LABORATORY	STA STD	STATION STANDARD
R	CLEAR	LAM	LAMINATE	STL	STEEL
•	CLEAN OUT	LAV	LAVATORY	STN	STAIN
L	COLUMN	LKR LOC	LOCKER LOCATE	STOR	STORAGE
NC	CONCRETE	LT	LIGHT	STRUCT	STRUCTURE
ND	CONDITION	LVL	LAMINATED VENEER LUMBER	SOG	SLAB ON GRADE
NT	CONTINUOUS		L/ WINVITED VENTER LOWISER	SUSP	SUSPENDED
T	CARPET	M	MEN'S	SYM	SYMMETRICAL
	CERAMIC TILE	MATL	MATERIAL		
	DOLINI E	MAX	MAXIMUM	T, TMP	TEMPERED
L MO	DOUBLE	MC	MEDICINE CABINET	T&G	TONGUE & GROOVE
IVIU	DEMOLISH DRINKING FOUNTAIN	MECH	MECHANICAL	TEL	TELEPHONE
A	DIAMETER	MEMB	MEMBRANE	TER	TERRAZZO
r FF	DIFFUSER	MFR	MANUFACTURER	THK	THICK
M	DIMENSION	MIN Mir	MINIMUM MIRROR	T.O.	TOP OF
SP	DISPENSER	MISC	MISCELLANEOUS	TS	TUBE STEEL
l	DOWN	MH	MANHOLE	TV	TELEVISION
	DOOR	MO	MASONRY OPENING	TYP	TYPICAL
	DOWNSPOUT	MTD	MOUNTED		
L	DETAIL	MTL	METAL	UL	UNDERWRITERS' LABORATORIES
I	DISHWASHER	MULL	MULLION	UNO	UNLESS NOTED OTHERWISE
	EAST	N	NORTH	VCT	VINYL COMPOSITION TILE
_	EACH SYSTEM OF A SAMPLE OF THE	NA	NOT APPLICABLE	VERT	VERTICAL
S	EXTERIOR COMPOSITE SIDING	NIC	NOT IN CONTRACT	VEST	VESTIBULE
	EXHAUST FAN EXPANSION JOINT	NOM	NOMINAL	VIF VTR	VERIFY IN FIELD VENT THRU ROOF
	ELEVATION	NTS	NOT TO SCALE	****	VEIVE THROTION
C	ELECTRICAL	NR	NOT RATED	147	WEST
V	ELEVATOR			W W/	WEST WITH
ERG	EMERGENCY	OA .	OVERALL	W/ WC	WITH WATER CLOSET
	EQUAL	OBS	OBSCURE	WC WD	WATER OLUSET
P	EXPANSION	0.C.	ON CENTER	WD WF	WIDE FLANGE
		0.D.	OUTSIDE DIAMETER	W/O	WITHOUT
P	FIBER BOARD PANEL	OFF OPNG	OFFICE OPENING	WOM	WALK OFF MAT
ı	FLOOR DRAIN	OPP	OPPOSITE	WM	WOMEN'S
	FIRE EXTINGUISHER	VI I	OI I OUIL	WP	WATERPROOFING
	FINISH FLOOR	PC	PRECAST CONCRETE	WR	WATER RESISTANT
	FIRE HYDRANT	PL PL	PLATE	WSCT	WAINSCOT
	FINISH	PLAS	PLASTER	WT	WEIGHT
}	FLOOR	PLY	PLYW00D		
).	FACE OF	P.LAM	PLASTIC LAMINATE		
IC	FURNISHED BY OWNER,	PNT	PAINT		
10	INSTALL BY CONTRACTOR	POC	POINT OF CONNECTION		
10	FURNISHED BY OWNER	PR	PAIR		
	INSTALL BY OWNER FIRE RESISTANT	PSL	PARALLEL STRAND LUMBER		
	FLOOR SINK	PT	PRESSURE TREATED		
	I LOUIT OHNIX	PTN	PARTITION		

RIGID INSULATION

DRAFTING SYMBOLS

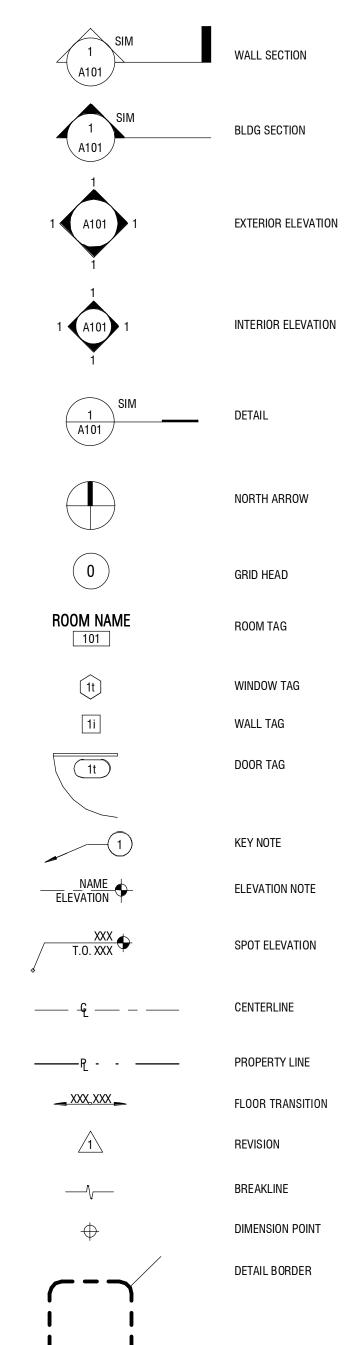

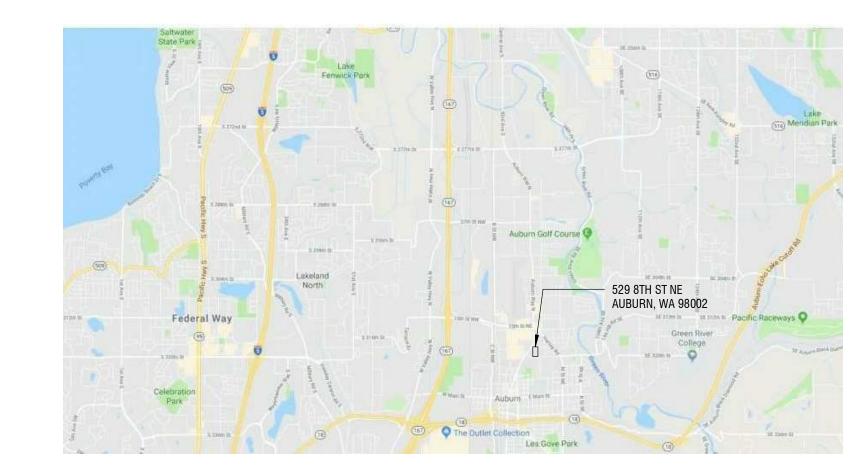

GENERAL NOTES

- 1. WHERE CONFLICTS OCCUR, THE SCOPE OF WORK TAKES PRECEDENCE OVER SPECIFICATIONS, AND SPECIFICATIONS TAKE PRECEDENCE OVER THE
- 2. MATERIALS, ASSEMBLIES AND NOTED ITEMS ARE NEW UNLESS OTHERWISE NOTED.
- 3. CONTRACTOR SHALL VERIFY CONDITIONS. NOTIFY THE ARCHITECT OF ANY CONDITIONS INCONSISTENT WITH THE INTENT OF THE DRAWINGS
- PRIOR TO STARTING OR CONTINUING WORK IN THE AREA CONCERNED. 4. DO NOT DISCONNECT POWER, DATA OR CABLE DURING CONSTRUCTION. COORDINATE REQUIRED SHUTDOWNS WITH OWNER.

- 1. ALL WORK SHALL CONFORM TO APPLICABLE CODES AND LOCAL BUILDING REQUIREMENTS, WHICH INCLUDE THE MOST CURRENT EDITIONS OF THE INTERNATIONAL BUILDING CODE WITH LOCAL AMENDMENTS, INTERNATIONAL FIRE CODE (IFC), AND WASHINGTON STATE ENERGY CODE
- 2. PER IEBC 503.1, ALL WORK IS CLASSIFIED AS AN ALTERATION LEVEL 1 REMOVAL OR REPLACEMENT OF EXISTING MATERIALS, ELEMENTS, EQUIPMENT, OR FIXTURES USING NEW MATERIALS, ELEMENTS, EQUIPMENT, OR FIXTURES THAT SERVE THE SAME PURPOSE, PER IEBC 701.2, AN 3. PER WSEC 503.1.1 EXCEPTION 3, THE BUILDING ENVELOPE ALTERATION IS NOT REQUIRED TO MEET NEW CONSTRUCTION BECAUSE THE WALL AND
- ROOF CAVITIES ARE NOT BEING EXPOSED DURING CONSTRUCTION AND THE ENERGY USE OF THE BUILDING IS NOT INCREASING. PER WSEC 503.1.1.1, REPLACEMENT FENESTRATION WILL MEET U-FACTORS AND SHGC PER TABLE R402.1.2. 4. EXISTING FIRE EXTINGUISHERS AND CABINETS ARE NOT SHOWN ON PLANS. PROTECT EXISTING FIRE EXTINGUISHERS AND CABINETS (RECESSED OR SURFACE MOUNTED) FROM DAMAGE.

1. THE CONTRACTOR WILL SUSPEND WORK IMMEDIATELY AND NOTIFY THE OWNER IF MATERIALS SUSPECTED OF BEING HAZARDOUS, AND NOT PREVIOUSLY IDENTIFIED. ARE ENCOUNTERED IN THE COURSE OF THE CONTRACTOR'S WORK.

1. WHERE ITEMS ARE INDICATED ON PLANS TO BE DEMOLISHED, IT SHALL MEAN THE COMPLETE REMOVAL AND DISPOSAL OF THE ITEM INDICATED

UNLESS OTHERWISE NOTED. "REMOVE" MEANS TO COMPLETELY AND PERMANENTLY REMOVE FROM THE PROJECT.

2. CONTRACTOR IS RESPONSIBLE FOR REVIEW OF THE DRAWINGS AND SPECIFICATIONS FOR CUTTING AND PATCHING WORK.

1. DO NOT SCALE DRAWINGS.

- 2. VERIFY DIMENSIONS SHOWN ON DRAWINGS. USE ONLY DIMENSIONS INDICATED. PRIOR TO STARTING OR CONTINUING WORK, NOTIFY ARCHITECT OF DISCREPANCIES OR CONDITIONS INCONSISTENT WITH THE INTENT OF THE CONSTRUCTION DOCUMENTS. 3. DIMENSIONS ARE TO FACE OF CONCRETE. FACE OF MASONRY, OR FACE OF STUD, UNLESS OTHERWISE NOTED.
- 4. FINISHED SURFACE OF INFILL OR EXTENSIONS OF EXISTING PARTITIONS SHALL ALIGN WITH ADJACENT EXISTING SURFACES UNLESS OTHERWISE
- 5. VERTICAL DIMENSIONS ARE MEASURED FROM STRUCTURAL SLAB, TOP OF STEEL OR TOP OF SHEATHING, UNLESS NOTED OTHERWISE

- 1. COORDINATE ALL OPERATIONS WITH OWNER, SUCH AS AREAS USED FOR MATERIAL STORAGE, ACCESS TO AND FROM THE SITE, TIMING OF WORK AND REQUIREMENTS OF NOISE ORDINANCE. INSTALL DUST AND NOISE BARRIERS AS REQUIRED TO PROTECT EXISTING ADJACENT BUILDINGS AND OCCUPANTS AND TO MAINTAIN AN ENVIRONMENT SUITABLE TO PERMIT CONTINUED OCCUPANCY OF SUBJECT AND ADJACENT BUILDINGS.
- 2. REVIEW DEMOLITION DRAWINGS. PATCH AND REPAIR ALL EXISTING SURFACES AFFECTED BY DEMOLITION WORK. 3. VERIFY LOCATIONS OF EXISTING UTILITIES. CAP, MARK AND PROTECT AS NECESSARY TO COMPLETE THE WORK
- 4. PIPING, CONDUITS, DUCTS, ETC. SHALL BE CONCEALED IN WALLS, CHASES, ABOVE SUSPENDED CEILINGS, BELOW FLOORS OR BE FURRED-IN IN ROOMS WITH EXISTING CEILINGS, UNLESS OTHERWISE NOTED. DO NOT CONCEAL PIPING, CONDUITS, DUCTS, ETC. IN ELECTRICAL, MECHANICAL,
- 5. COORDINATE AND PROVIDE REQUIRED PENETRATIONS AND PATCHING WITH INDIVIDUAL SUBCONTRACTORS TO SUIT NEW WORK.
- 6. CONTRACTOR TO COORDINATE ATTIC ACTIVITIES (TO BE PERFORMED BY OTHERS) WITH OWNER.

Please note per 2018 IBC applicable accessible code is A117.1-2009.



PROJECT INFORMATION

PROJECT OWNER: KING COUNTY HOUSING AUTHORITY

AMY KURTZ 700 ANDOVER PARK W

PROJECT ADDRESS: 529 8TH ST NE

AUBURN, WA 98002

TUKWILA, WA 98188

EMAIL: amyk@kcha.org

TEL: 206.574.1283

SCOPE DESCRIPTION: MODIFY STORAGE SHED ROOFS TO PROVIDE CLEARANCE FOR HINGED DOORS AND INSTALL ACCESSIBLE RAMP AT OFFICE.

ZONING ANALYSIS

PARCEL NUMBER: 333990-0530

LEGAL DESCRIPTION: HILLMANS C D AUBURNDALE DIV # 2 PLAT BLOCK: 14

LOT AREA: 1.31 ACRES

PLAT LOT: 53 THRU 56

CURRENT USE: APARTMENTS

YEAR BUILT: 1978

(E) BLDG AREA: 23,175 SQ FT

(E) LOT COVERAGE: NO CHANGE

HT LIMIT: NO CHANGE

PARKING QUANTITY: NO CHANGE

REQUIRED SETBACKS: N/A

APPLICABLE CODES

2018 INTERNATIONAL BUILDING CODE WITH LOCAL AMENDMENTS > 2010 ADA STANDARDS FOR ACCESSIBLE DESIGN

Please provide details for accessible requirements per A117.1-2009 for affected eatures for this project to include, ramps, edge protection, handrails, locations o accessible dwelling units that may be affected, clearances for openings affected by proposed work, etc.



DESIGN TEAM

ARCHITECT: SHKS ARCHITECTS 1050 NORTH 38TH ST SEATTLE, WA 98103

CONTACT: LEVI JETTE, AIA TEL: 206.224.3317 EMAIL: levij@shksarchitects.com CIVIL ENGINEER/SURVEYOR: DAVID EVANS AND ASSOCIATES, INC.

20300 WOODINVILLE SNOHOMISH RD NE, SUITE A WOODINVILLE, WA 98072 CONTACT: TYSON WENTZ, PE TEL: 425.415.2000 EMAIL: Tyson.Wentz@deainc.com

STRUCTURAL ENGINEER: PCS STRUCTURAL SOLUTIONS 1011 WESTERN AVENUE, SUITE 810 SEATTLE, WA 98104 CONTACT: SHADOW WOODFORK TEL: 253.383.2797 EMAIL: swoodfork@pcs-structural.com

SHEET INDEX

A0.0 COVER SHEET

C1.0 SITE PLAN AND NOTES EXISTING CONDITIONS C3.0 T.E.S AND DEMO PLAN

C4.0 SITE PLAN GRADING AND DRAINAGE PLAN C5.0 GRADING AND DRAINAGE PLAN

C7.0 DETAILS

A1.0 KEY PLAN

AD2.1 DEMO FLOOR PLANS AD3.1 DEMO ELEVATIONS

FIRST FLOOR PLANS

SECOND FLOOR PLANS A3.1 ELEVATIONS

A4.1 ENLARGED PLANS & ELEVATIONS A4.2 RAMP PLAN & ELEVATION

SHED ASSEMBLY DIAGRAMS

SHED DETAILS

SHED DETAILS

TYPE 2 SHED DETAILS

TYPE 3 SHED DETAILS

EXTERIOR DETAILS

A6.2 EXTERIOR DETAILS

1050 N. 38th St. Seattle, WA 98103

рн: 206.675.9151

__ www.shksarchitects.com

529 8TH ST NE AUBURN, WA 98002

Drawn by: Checked: Date: 02/10/2023 Scale: As indicated

MATERIAL SYMBOLS

EXCEPT THAT PORTION THEREOF CONDEMNED BY THE CITY OF AUBURN FOR ROADWAY PURPOSES IN KING COUNTY SUPERIOR COURT CAUSE NUMBER

CONTAINING 56,159 SQUARE FEET OR 1.29 ACRES MORE OR LESS.

BASIS OF BEARING

THE CENTER LINE OF 10TH STREET NE BETWEEN THE MONUMENT AT THE INTERSECTION OF 10TH STREET NE AND "I" STREET NE AND MONUMENT ON THE CENTERLINE OF 10TH STREET NE 419.32 FEET WEST FROM THE SAID INTERSECTION HAVING A BEARING OF N88°57'39"W.

REFERENCES

PLAT OF "C. D. HILLMAN'S AUBURNDALE ADDITION DIV. NO. 2 RECORDING NO.

RECORD OF SURVEY NO. 199510309009 RECORD OF SURVEY NO. 20050509900002 RECORD OF SURVEY NO. 20060622900030 RECORD OF SURVEY NO. 20100816900007

EQUIPMENT AND PROCEDURES

CONVENTIONAL METHODS AND PROCEDURES USING A TOPCON ROBOTIC 1 SECOND TOTAL STATION THEODOLITE. A MAXIMUM CLOSURE OF 1' IN 10,000' WAS ACCOMPLISHED IN COMPLIANCE WITH W.A.C. 332-130-090

EASEMENTS


RECORDING NO. 7810031015 GRANTEE: CITY OF AUBURN


PURPOSE: WATER LINE AREA AFFECTED: 5' EACH SIDE OF THE AS BUILT POSITION WATER LINE AND WATER APPURTENANCES, AS SHOWN.

RECORDING NO. 7903060849

GRANTEE: PUGET SOUND POWER & LIGHT COMPANY, A WASHINGTON CORPORATION PURPOSE: ELECTRIC TRANSMISSION AND/OR DISTRIBUTION SYSTEM TOGETHER WITH ALL NECESSARY OR CONVENIENT APPURTENANCES

AREA AFFECTED: PORTION OF SAID PREMISES LYING WITHIN A STRIP OF LAND 10 FEET IN WIDTH HAVING 5 FEET OF SUCH WIDTH ON EACH SIDE OF A CENTERLINE AS NOW CONSTRUCTED OR AS MAY BE CONSTRUCTED, EXTENDED OR RELOCATED.

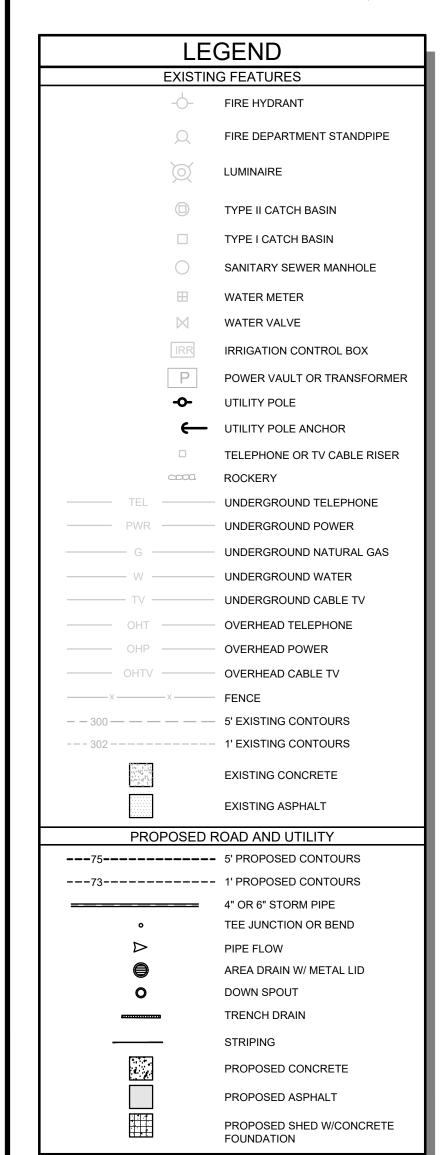

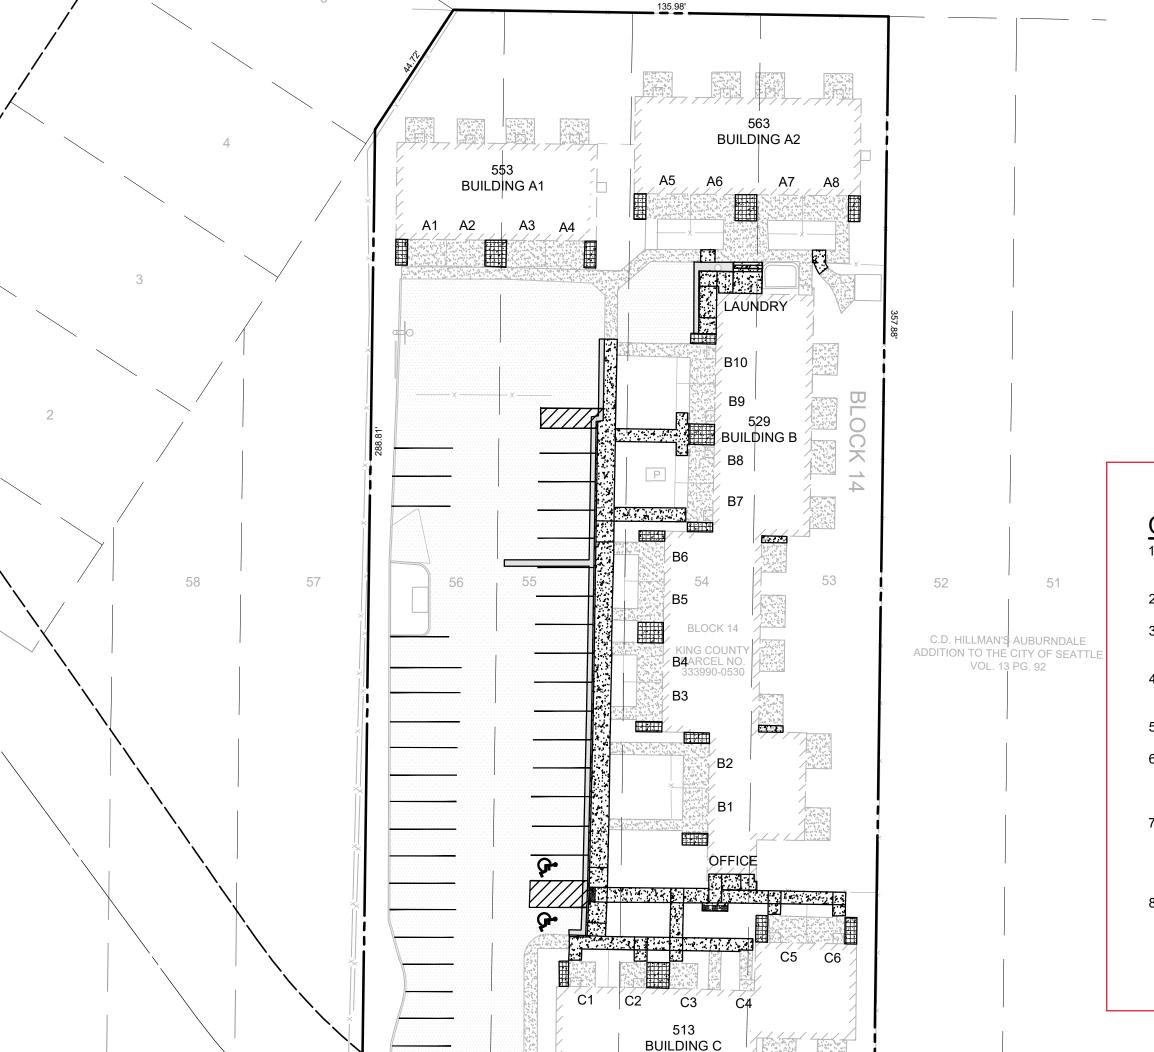

R=190.07'

PROJECT INFORMATION

ADDRESSES: 513, 529, 553, 563 8TH STREET NE **AUBURN, WA 98002**

333990-0530 PARCEL #:

LOT AREA: 57,165 SQ. FT. (1.31 ACRES)

ZONING:

PROJECT QUANTITIES

REPLACED ASPHALT: 405 SQ. FT.

SEAL COAT: 14,617 SQ. FT. REPLACED CONCRETE: 2,322 SQ. FT.

REPLACED SHED FOUNDATIONS: 628 SQ. FT.

AREA DRAINS: DOWNSPOUTS:

*ALL QUANTILES SHOWN ARE ASSUMED AND FOR REFERENCE ONLY. CONTRACTOR TO FIELD VERIFY ALL AREAS AND QUANTITIES

EARTHWORK QUANTITIES

5 CU. YDS.

FILL: 5 CU. YDS.

TOTAL EARTHWORK: 10 CU. YDS

*ALL QUANTILES SHOWN ARE ASSUMED AND FOR REFERENCE ONLY. CONTRACTOR TO FIELD VERIFY ALL

0 CU. YDS.

AREAS AND QUANTITIES

NET IMPORT/EXPORT:

PIPE TEE OR BENDS:

STORMWATER PERMIT QUANTITIES

TOTAL DISTURBED AREA

TOTAL NEW & REPLACED HARD SURFACE 3,355 SQ. FT.

TOTAL NEW HARD SURFACE 0 SQ. FT.

*ALL QUANTILES SHOWN ARE ASSUMED AND FOR REFERENCE ONLY. CONTRACTOR TO FIELD VERIFY ALL AREAS AND QUANTITIES

CONSTRUCTION SEQUENCE:

CONTACT THE CITY OF AUBURN AND SCHEDULE A PRE-CONSTRUCTION MEETING.

2. FLAG OR FENCE CLEARING LIMITS.

(FEET) 1 INCH = 30 FT.

- 3. INSTALL CATCH BASIN PROTECTION IF REQUIRED, PER COA STANDARD DETAIL E-03 OR E-04.
- GRADE AND INSTALL CONSTRUCTION ENTRANCE PER COA STANDARD DETAIL E-01, IF APPLICABLE.
- 5. INSTALL SILT FENCE PER COA STANDARD DETAIL E-02.
- MAINTAIN EROSION CONTROL MEASURES IN ACCORDANCE WITH THE CITY OF AUBURN STANDARDS AND MANUFACTURER'S RECOMMENDATIONS.
- MAINTAIN AND MODIFY EROSION CONTROL MEASURES AS SITE CONDITIONS CHANGE TO ENSURE SITE IS ALWAYS IN COMPLIANCE WITH THE CITY TESC MINIMUM REQUIREMENTS.
- UPON COMPLETION OF THE PROJECT, ALL DISTURBED AREAS MUST BE STABILIZED AND TEMPORARY EROSION AND SEDIMENT CONTROL BMPS REMOVED.

GENERAL NOTES:

CONSTRUCTION SHALL CONFORM TO THE CITY OF AUBURN'S ENGINEERING DESIGN AND CONSTRUCTION STANDARDS, EXCEPT AS OTHERWISE APPROVED BY DEVIATION, AND BE IN ACCORDANCE WITH THE APPROVED PLANS. ANY CHANGES FROM THE APPROVED PLAN WILL REQUIRE APPROVAL FROM THE OWNER, ENGINEER OF RECORD.

5,074 SQ. FT.

- ALL WORKMANSHIP AND MATERIALS SHALL CONFORM TO THE "WASHINGTON STATE DEPARTMENT OF TRANSPORTATION (WSDOT) STANDARD SPECIFICATIONS FOR ROAD, BRIDGE, AND MUNICIPAL CONSTRUCTION (CURRENT EDITION)," EXCEPT WHERE SUPPLEMENTED OR MODIFIED BY THE CITY'S CONSTRUCTION STANDARDS MANUAL. THE ABOVE DOCUMENTS SHALL BE AVAILABLE AT THE JOB SITE DURING CONSTRUCTION.
- A PRE-CONSTRUCTION MEETING SHALL BE REQUIRED PRIOR TO THE START OF ALL CONSTRUCTION.
- UNLESS STATED OTHERWISE, LOCATIONS SHOWN FOR EXISTING UTILITIES ARE APPROXIMATE. THE CONTRACTOR IS CAUTIONED THAT OVERHEAD UTILITY LINES MAY NOT BE SHOWN ON THE DRAWINGS. IT SHALL BE THE CONTRACTOR'S RESPONSIBILITY TO DETERMINE THE TRUE ELEVATIONS AND LOCATIONS OF ALL UNDERGROUND UTILITIES AND THE EXTENT OF ANY HAZARD CREATED BY OVERHEAD UTILITY LINES. IDENTIFICATION, LOCATION, MARKING, AND RESPONSIBILITY FOR UNDERGROUND FACILITIES OR UTILITIES, IS GOVERNED BY THE PROVISIONS OF CHAPTER 19.122 REVISED CODE OF WASHINGTON (RCW). PRIOR TO STARTING CONSTRUCTION, THE CONTRACTOR SHALL CALL ONE-CALL (811) FOR UTILITY LOCATIONS (WATER, SANITARY SEWER, STORM SEWER, GAS, POWER, TELEPHONE, AND CABLE).
- IF A PROPOSED ROUTE IS NOT INCLUDED ON THESE PLANS, A PROPOSED ROUTE AND SCHEDULE FOR HAULING MATERIAL TO THE SITE SHALL BE SUBMITTED TO THE CITY FOR APPROVAL PRIOR TO THE START OF CONSTRUCTION. IF THE CITY BELIEVES THAT THE PROPOSED HAUL ROUTE WILL ADVERSELY IMPACT THE STREET NETWORK, A SEPA AMENDMENT MAY BE REQUIRED TO EVALUATE THE IMPACTS AND DETERMINE MITIGATION REQUIREMENTS BEFORE BEGINNING WORK. HAULING MAY BE LIMITED TO APPROPRIATE OFF-PEAK HOURS OR ALTERNATIVE ROUTES, AS DETERMINED BY THE CITY.
- 6. THE CONTRACTOR SHALL BE RESPONSIBLE FOR PUBLIC SAFETY ON AND AROUND THE PROJECT. PRIOR TO THE START OF WORK, ALL METHODS AND EQUIPMENT USED FOR TRAFFIC CONTROL AND STREET MAINTENANCE SHALL BE SUBMITTED TO THE CITY FOR APPROVAL. CONTRACTORS AND THEIR SURETY SHALL BE LIABLE FOR INJURIES AND DAMAGES TO PERSONS AND PROPERTY SUFFERED BECAUSE OF CONTRACTORS OPERATIONS OR NEGLIGENCE CONNECTED WITH THEM.
- 7. ALL CONSTRUCTION SURVEYING FOR EXTENSIONS OF PUBLIC FACILITIES SHALL BE DONE UNDER THE DIRECTION OF A WASHINGTON LICENSED LAND SURVEYOR OR A WASHINGTON LICENSED ROFESSIONAL CIVIL ENGINEER.
- 8. CERTIFIED DRAWINGS ARE REQUIRED PRIOR TO PROJECT ACCEPTANCE. REFER TO THE CITY'S "DEVELOPMENT RECORD CONSTRUCTION DOCUMENT" HANDOUT.
- 9. WHERE CONFLICT OCCURS, THE SCOPE OF WORK PRECEDES SPECIFICATIONS, AND SPECIFICATIONS TAKE PRECEDENCE OVER DRAWINGS.

LOCATION OF EXISTING UTILITIES SHOWN IS APPROXIMATE AND MAY NOT BE ACCURATE OR ALL INCLUSIVE. IT IS THE CONTRACTOR'S RESPONSIBILITY TO FIELD VERIFY LOCATION OF UTILITIES PRIOR TO PROCEEDING WITH CONSTRUCTION. YOU MUST CALL 1-800-424-5555 NOT LESS THAN TWO FULL BUSINESS DAYS BEFORE BEGINNING EXCAVATION WHERE ANY UNDERGROUND UTILITIES MAY BE LOCATED. EXISTING UTILITIES TO BE LOCATED, PROTECTED, AND REPAIRED IN ACCORDANCE WITH RCW 19.122.


DAVID EVANS AND ASSOCIATES INC 0300 Woodinville Snohomish Rd Ni Woodinville Washington 98072

Phone: 425.415.2000

NORTHWOOD SQUARE 529, 553, 563 8TH STREET

3

BID SET

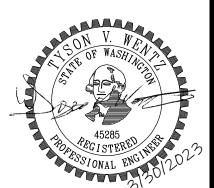

CHECKED BY: TVW DESIGNED BY: TVW

DRAWN BY: SJR

FIRST SUBMITTAL DATE:

PROJECT NO. KCHA00006048

SHEET NO.

C1.0 of 7

PORTION OF SW 1/4, SW 1/4, SEC 7, TWN 21, RGE 5, W.M. 2" HMA CL $\frac{1}{2}$ " OVER 4" HMA CL 1" - SAWCUT IN STRAIGHT PARALLEL MONOLITHIC CONCRETE CURB AND LINES. ASPHALT TACK APPLIED SIDEWALK WITH BROOM FINISH PER TO ALL EXISTING PAVEMENT BMP T5.13: POST CONSTRUCTION SOIL QUALITY AND DEPTH WSDOT STANDARD PLAN F-30.10-04 SURFACES PER COA STANDARDS EXCERPT FROM THE DEPARMENT OF ECOLOGY'S STORMWATER MANAGEMENT MANUAL FOR WESTERN WASHINGTON ALL AREAS SUBJECT TO CLEARING AND GRADING THAT HAVE NOT BEEN COVERED BY IMPERVIOUS SURFACE, DAVID EVANS INCORPORATED INTO A DRAINAGE FACILITY OR ENGINEERED AS STRUCTURAL FILL OR SLOPE SHALL, AT PROJECT AND ASSOCIATES INC COMPLETION, DEMONSTRATE THE FOLLOWING: - 1-1/2" O.D. GALV CONT STEEL PIPE, POWDER COATED 20300 Woodinville Snohomish Rd NE A TOPSOIL LAYER WITH A MINIMUM ORGANIC MATTER CONTENT OF 10% DRY WEIGHT IN PLANTING BEDS, AND 5% (E) FACE OF BUILDING Woodinville Washington 98072 - 1-1/2" O.D. GALV CONT STEEL PIPE, POWDER COATED ORGANIC MATTER CONTENT IN TURF AREAS, AND A PH FROM 6.0 TO 8.0 OR MATCHING THE PH OF THE Phone: 425.415.2000 UNDISTURBED SOIL. THE TOPSOIL LAYER SHALL HAVE A MINIMUM DEPTH OF EIGHT INCHES EXCEPT WHERE — 1" O.D. GALV STEEL PIPE, PAINTED TREE ROOTS LIMIT THE DEPTH OF INCORPORATION OF AMENDMENTS NEEDED TO MEET THE CRITERIA. 4" CONC SIDEWALK SUBSOILS BELOW THE TOPSOIL LAYER SHOULD BE SCARIFIED AT LEAST 4 INCHES WITH SOME INCORPORATION - MTL ESCUTCHEON PLATE, PAINTED OF THE UPPER MATERIAL TO AVOID STRATIFIED LAYERS, WHERE FEASIBLE. 6.5" PL 1/2" x 3" x 6", CENTER ON POST MULCH PLANTING BEDS WITH 2 INCHES OF ORGANIC MATERIAL REINFORCING, LAP 2'-0" EMBED PL 1/2"x3"x0'-6" W/ (2) 5/8" REDUCED MONOLITHIC SIDEWALK/CURB POUR USE COMPOST AND OTHER MATERIALS THAT MEET THE FOLLOWING ORGANIC CONTENT REQUIREMENTS: BASE THREADED STUDS @ 4" O.C., & (2) 5/8" DEFORMED BAR ANCHORS @ 4" O.C. W/ STD ໌ 3/16 ີ NOT TO SCALE HOOK. CENTER EMBED PL ON POST. A. THE ORGANIC CONTENT FOR "PRE-APPROVED" AMENDMENT RATES CAN BE MET ONLY USING COMPOST MEETING THE COMPOST SPECIFICATION FOR BMP T7.30: BIORETENTION, WITH THE EXCEPTION THAT THE #4x32" @ 32" O.C., FORMSAVER COMPOST MAY HAVE UP TO 35% BIOSOLIDS OR MANURE. THE COMPOST MUST ALSO HAVE AN ORGANIC MATTER OR EPOXY EMBED 4" CONTENT OF 40% TO 65%, AND A CARBON TO NITROGEN RATIO BELOW 25:1. THE CARBON TO NITROGEN RATIO MAY BE AS HIGH AS 35:1 FOR PLANTINGS COMPOSED ENTIRELY OF PLANTS NATIVE TO THE PUGET SOUND #4 @ 12" O.C. LOWLANDS REGION. EACH WAY -NORTHWOOD SQUARE, 529, 553, 563 8TH STREET NAME COUNTY HOUSING AUTHORITY CALCULATED AMENDMENT RATES MAY BE MET THROUGH USE OF COMPOSTED MATERIAL MEETING (A.) ABOVE; OR OTHER ORGANIC MATERIALS AMENDED TO MEET THE CARBON TO NITROGEN RATIO REQUIREMENTS, AND NOT EXCEEDING THE CONTAMINANT LIMITS IDENTIFIED IN TABLE 220-B, TESTING PARAMETERS, IN WAC 173-350-220. (E) GRADE THE RESULTING SOIL SHOULD BE CONDUCIVE TO THE TYPE OF VEGETATION TO BE ESTABLISHED. **IMPLEMENTATION OPTIONS** THE SOIL QUALITY DESIGN GUIDELINES LISTED ABOVE CAN BE MET BY USING ONE OF THE METHODS LISTED BELOW: LEAVE UNDISTURBED NATIVE VEGETATION AND SOIL, AND PROTECT FROM COMPACTION DURING CONSTRUCTION. COMPACTED GRANULAR FILL AMEND EXISTING SITE TOPSOIL OR SUBSOIL EITHER AT DEFAULT "PRE-APPROVED" RATES, OR AT CUSTOM CONCRETE RAMP & HANDRAIL DETAIL CALCULATED RATES BASED ON TESTS OF THE SOIL AND AMENDMENT. STOCKPILE EXISTING TOPSOIL DURING GRADING, AND REPLACE IT PRIOR TO PLANTING. STOCKPILED TOPSOIL MUST ALSO BE AMENDED IF NEEDED TO MEET THE ORGANIC MATTER OR DEPTH REQUIREMENTS, EITHER AT A DEFAULT "PRE-APPROVED" RATE OR AT A CUSTOM CALCULATED RATE. က် 4. IMPORT TOPSOIL MIX OF SUFFICIENT ORGANIC CONTENT AND DEPTH TO MEET THE REQUIREMENTS. CONTINUOUS TOP RAIL W/ GUARDRAIL 6' MAX / EQ SPACING AT TOP OF STAIRS PER PLAN, TYP MORE THAN ONE METHOD MAY BE USED ON DIFFERENT PORTIONS OF THE SAME SITE. SOIL THAT ALREADY MEETS THE DEPTH AND ORGANIC MATTER QUALITY STANDARDS, AND IS NOT COMPACTED, DOES NOT NEED TO BE AMENDED. 1-1/2" O.D. GALV CONT STEEL PIPE RAIL, POWDER-COAT FINISH, ATTACH TO CONC PER 1/A5.5 REMOVE AND REINSTALL EXISTING **SQUARE DOWNSPOUT** SQUARE DOWNSPOUT TO 4"Ø PIPE CONNECTOR METER BOX W/LID PER SPECS CONC STAIR RISERS AT 6" RISER AND 12" TREAD, EA STEP SHALL HAVE 1/2" RADIUS NOSING AND (1) #4 REBAR IN STAIR NOTES, 2" **~**—4"Ø – 45° BEND 12" DOWEL BETWEEN STAIRS AND - 45° BEND CONC WALK, TYP TOP AND BOTTOM LOCATOR WIRE #4 REBAR @ 12" 0.C. THICKENED EDGE W/ EXPANSION JOINT 4-6"Ø 4-6"Ø EA WAY CONT, 2" CLR 4-6"Ø 4-6"Ø BASE COURSE, TYP COMPACT SUBGRADE, TYP CLEANOUT DETAIL NOT TO SCALE ROOF DRAIN DOWNSPOUT CONNECTION DETAIL NOT TO SCALE STAIRS & HANDRAIL DETAIL NOT TO SCALE **BID SET** CONTROL JOINT STAINLESS STEEL GRATE 1/8" SAWCUT x1/4 OF SLAB DEPTH, SAW WITHIN 4 TO 12 WALKWAY HOURS OF POURING SLAB, FILL W/ MASTIC EXTERIOR FACE - ADD'L VERT REINF 1/2" MIN. GROUT THICKNESS CHECKED BY: TVW **DESIGNED BY: TVW** DRAWN BY: SJR HDPE CHANNEL SECTION LOCATION OF EXISTING UTILITIES SHOWN IS FIRST SUBMITTAL DATE: APPROXIMATE AND MAY NOT BE ACCURATE OR ALL TRENCH DRAIN DETAIL INCLUSIVE. IT IS THE CONTRACTOR'S RESPONSIBILITY SLAB ON GRADE CONTROL JOINT DETAIL PROJECT NO. TO FIELD VERIFY LOCATION OF UTILITIES PRIOR TO NOT TO SCALE KCHA000006048 PROCEEDING WITH CONSTRUCTION. YOU MUST CALL NOT TO SCALE 1-800-424-5555 NOT LESS THAN TWO FULL BUSINESS DAYS BEFORE BEGINNING EXCAVATION WHERE ANY SHEET NO. UNDERGROUND UTILITIES MAY BE LOCATED. WALL CONTROL JOINT DETAIL EXISTING UTILITIES TO BE LOCATED, PROTECTED, AND REPAIRED IN ACCORDANCE WITH RCW 19.122. **C7.0** of **7** NOT TO SCALE