
1050 N. 38th St.

Seattle, WA 98103 рн: 206.675.9151

KCHA EASTRIDGE HOUSE ELEVATOR MODERNIZATION

DRAFTING SYMBOLS ABBREVIATIONS RESILIENT BASE GALVANIZED REFLECTED CEILING PLAN WALL SECTION GRAB BAR GENERAL CONTRACTOR **ROOF DRAIN** DIAMETER REFERENCE GLASS POUND OR NUMBER GLU-LAM BEAM REFRIGERATOR EXISTING REINFORCED GROUND CENTERLINE GRADE RELOCATE **BLDG SECTION** PROPERTY LINE REQUIRED GROUTED REQ'D GYPSUM WALL BOARD RESILIENT ROUGH OPENING AIR CONDITIONING **HANDICAP** ROOF VENT ACOUSTIC CEILING PANEL RAIN WATER LEADER HOLLOW CLAY MASONRY UNIT AIR CONDITION UNIT EXTERIOR ELEVATION HARDW00D ADJUSTABLE HARDWARE ABOVE FINISHED FLOOR SMOKE ALARM HEIGHT SOLID CORE **HOLLOW META** ALUMINUM SCHEDULE **HOUR** SECTION HORIZONTAL HORIZ ARCHITECT, ARCHITECTURAL SAFETY GLASS INTERIOR ELEVATION INSIDE DIAMETER SIMILAR INSULATION BLW BELOW SPECIFICATION INTERIOR SQUARE BOTTOM OF STAINLESS STEEL **BACKER ROD & SEALANT JANITOR** STATION JOINT STANDARD CATCH BASIN STEEL CEMENT BACKER BOARD STAIN **KITCHEN** STORAGE STOR CONTROL JOINT STRUCTURE I ABORATOR SLAB ON GRADE LAMINATE CEILING SUSPENDED **LAVATORY** NORTH ARROW SYM SYMMETRICAL LOCKER CLEAN OUT LOCATE CONCRETE LAMINATED VENEER LUMBER CONDITION **TONGUE & GROOVE** TELEPHONE GRID HEAD TERRAZZO MATERIAL CERAMIC TILE THICK MAXIMUM **ROOM NAME** CTR CENTER TOP OF ROOM TAG MEDICINE CABINE TUBE STEEL 101 MECHANICAL TELEVISION MFMBRANE TYPICAL WINDOW & DEMOLISH MANUFACTURER STOREFRONT TAG DRINKING FOUNTAIN MINIMIIM UNDERWRITERS' LABORATORIES DIFFUSER MISCELLANEOUS FLOOR, WALL, CEILING UTIL DIMENSION UTILITY MANHOI F OR ROOF TAG DISPENSER MASONRY OPENING MOUNTED VINYL COMPOSITION TILE CASEWORK TAG DOOR VERTICAL DOWNSPOUT MULLION VESTIBULE DETAIL VERIFY IN FIELD DISHWASHER VENT THRU ROOF (101) DOOR TAG NOT APPLICABLE NOT IN CONTRACT EXTERIOR COMPOSITE SIDING NTS NOT TO SCALE WATER CLOSET EXHAUST FAN NOT RATED KEY NOTE EXPANSION JOINT WIDE FLANGE FI EVATION WINDOW ELECTRICAL WITHOUT **ELEVATION NOTE** OBSCURE ELEV FI FVATOR WALK OFF MAT ON CENTER **EMERGENCY** WOMEN'S **OUTSIDE DIAMETER** WATERPROOFING EXPANSION WATER RESISTANT SPOT ELEVATION OPENING EXTERIOR WATER-RESISTIVE BARRIER OPPOSITE WAINSCOT FIBER BOARD PANEL WEIGHT PRECAST CONCRETE FLOOR DRAIN CENTERLINE PI ATF G------FIRE EXTINGUISHER PLASTER FINISH FLOOR PLYW00D FIRE HYDRANT PLASTIC LAMINATE FINISH PROPERTY LINE FL00R POINT OF CONNECTION FACE OF XXX XXX FURNISHED BY OWNER, FLOOR TRANSITION PARALLEL STRAND LUMBER INSTALL BY CONTRACTOR PRESSURE TREATED FURNISHED BY OWNER PTN PARTITION INSTALL BY OWNER REVISION FIRE RESISTANT DESCRIPTION FLOOR SINK QUARRY TILE FEET BREAKLINE DIMENSION POINT MATERIAL SYMBOLS ENLARGED DETAIL CALLOUT BATT INSULATION RIGID INSULATION

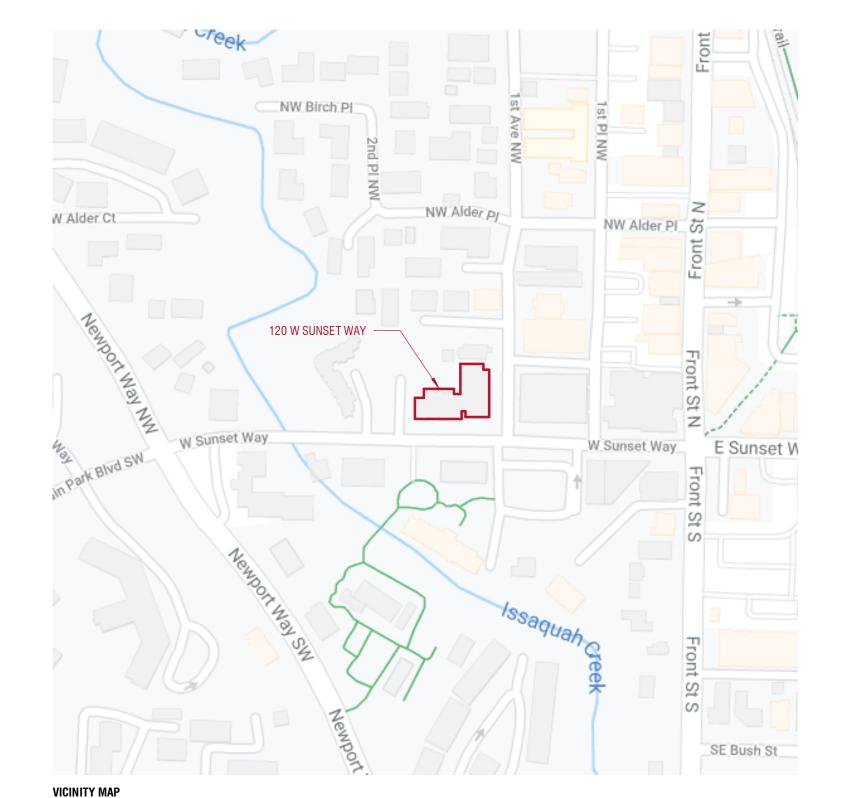

GENERAL NOTES

- 1. WHERE CONFLICTS OCCUR, THE SCOPE OF WORK TAKES PRECEDENCE OVER SPECIFICATIONS, AND SPECIFICATIONS TAKE PRECEDENCE OVER THE
- 2. MATERIALS, ASSEMBLIES AND NOTED ITEMS ARE NEW UNLESS OTHERWISE NOTED. 3. CONTRACTOR SHALL VERIFY CONDITIONS. NOTIFY THE OWNER OF ANY CONDITIONS INCONSISTENT WITH THE INTENT OF THE DRAWINGS PRIOR TO STARTING OR CONTINUING WORK IN THE AREA CONCERNED.
- 4. PROTECT ALL EXISTING LANDSCAPING. 5. BUILDINGS OCCUPIED DURING CONSTRUCTION.
- DO NOT DISCONNECT POWER, DATA OR CABLE DURING CONSTRUCTION. COORDINATE REQUIRED SHUTDOWNS WITH OWNER.

1. ALL WORK SHALL CONFORM TO APPLICABLE CODES AND LOCAL BUILDING REQUIREMENTS, WHICH INCLUDE THE MOST CURRENT EDITIONS OF

- THE INTERNATIONAL BUILDING CODE WITH LOCAL AMENDMENTS. INTERNATIONAL MECHANICAL CODE (IMC), NATIONAL ELECTRICAL CODE (NEC). INTERNATIONAL FIRE CODE (IFC), AND WASHINGTON STATE ENERGY CODE (WEC). 2. MECHANICAL ELECTRICAL AND ELEVATOR PERMITS TO BE APPLIED FOR UNDER SEPARATE APPLICATION BY CONTRACTOR.
- 3. PER IEBC 503.1, ALL WORK IS CLASSIFIED AS AN ALTERATION LEVEL 1 REMOVAL OR REPLACEMENT OF EXISTING MATERIALS, ELEMENTS, EQUIPMENT, OR FIXTURES USING NEW MATERIALS, ELEMENTS, EQUIPMENT, OR FIXTURES THAT SERVE THE SAME PURPOSE. PER IEBC 701.2, AN EXISTING BUILDING SHALL NOT BE ALTERED SUCH THAT THE BUILDING BECOMES LESS SAFE THAN ITS EXISTING CONDITION.

1. PROVIDE ENVIRONMENTAL SITE ASSESSMENT REPORT THAT IS A "LIMITED ASBESTOS AND OTHER REGULATED MATERIALS" SURVEY OF THE

PREVIOUSLY IDENTIFIED. ARE ENCOUNTERED IN THE COURSE OF THE CONTRACTOR'S WORK.

2. THE CONTRACTOR WILL SUSPEND WORK IMMEDIATELY AND NOTIFY THE OWNER IF MATERIALS SUSPECTED OF BEING HAZARDOUS, AND NOT

1. WHERE ITEMS ARE INDICATED ON PLANS TO BE DEMOLISHED, IT SHALL MEAN THE COMPLETE REMOVAL AND DISPOSAL OF THE ITEM INDICATED UNLESS OTHERWISE NOTED. "REMOVE" MEANS TO COMPLETELY AND PERMANENTLY REMOVE FROM THE PROJECT.

2. PATCH AND REPAIR TO "LIKE-NEW" CONDITION ALL EXISTING SURFACES AFFECTED BY DEMOLITION WORK. 3. CONTRACTOR IS RESPONSIBLE FOR REVIEW AND COORDINATION OF THE HAZARDOUS MATERIALS ABATEMENT, ARCHITECTURAL, ELEVATOR,

MECHANICAL AND ELECTRICAL DRAWINGS AND SPECIFICATIONS FOR CUTTING AND PATCHING WORK.

- DO NOT SCALE DRAWINGS. 2. VERIFY DIMENSIONS SHOWN ON DRAWINGS. USE ONLY DIMENSIONS INDICATED. PRIOR TO STARTING OR CONTINUING WORK, NOTIFY ARCHITECT
- OF DISCREPANCIES OR CONDITIONS INCONSISTENT WITH THE INTENT OF THE CONSTRUCTION DOCUMENTS. DIMENSIONS ARE TO FACE OF CONCRETE, FACE OF MASONRY, OR FACE OF STUD, UNLESS OTHERWISE NOTED
- 4. FINISHED SURFACE OF INFILL OR EXTENSIONS OF EXISTING PARTITIONS SHALL ALIGN WITH ADJACENT EXISTING SURFACES UNLESS OTHERWISE
- 5. VERTICAL DIMENSIONS ARE MEASURED FROM STRUCTURAL SLAB, TOP OF STEEL OR TOP OF SHEATHING, UNLESS NOTED OTHERWISE.

- 1. COORDINATE ALL OPERATIONS WITH OWNER, SUCH AS AREAS USED FOR MATERIAL STORAGE, ACCESS TO AND FROM THE SITE, TIMING OF WORK AND REQUIREMENTS OF NOISE ORDINANCE. INSTALL DUST AND NOISE BARRIERS AS REQUIRED TO PROTECT EXISTING ADJACENT BUILDINGS AND OCCUPANTS AND TO MAINTAIN AN ENVIRONMENT SUITABLE TO PERMIT CONTINUED OCCUPANCY OF SUBJECT AND ADJACENT BUILDINGS.
- VERIFY LOCATIONS OF EXISTING UTILITIES. CAP, MARK AND PROTECT AS NECESSARY TO COMPLETE THE WORK.
- 3. PIPING, CONDUITS, DUCTS, ETC. SHALL BE CONCEALED IN WALLS, CHASES, ABOVE SUSPENDED CEILINGS, BELOW FLOORS OR BE FURRED-IN IN
- ROOMS WITH EXISTING CEILINGS, UNLESS OTHERWISE NOTED.
- 5. COORDINATE ANY FIRE ALARM AND SECURITY ALARM DISCONNECTS AT COMMON AREA DOORS WITH OWNER.
- 4. COORDINATE AND PROVIDE REQUIRED PENETRATIONS AND PATCHING WITH INDIVIDUAL SUBCONTRACTORS TO SUIT NEW WORK.

PROJECT INFORMATION

KING COUNTY HOUSING AUTHORITY (KCHA)

PROJECT MANAGER: DONALD HATFIELD TEL: (206) 574-1213

EMAIL: DonaldH@kcha.ord

PROJECT ADDRESS: 120 W SUNSET WAY

ISSAQUAH, WA 98027

SCOPE DESCRIPTION MODERNIZE (1) HYDRAULIC ELEVATOR, REARRANGE EQUIPMENT IN UPGRADES WITH THIS ELEVATOR MODERNIZATION SUCH AS INCREASING

DESIGN TEAM

ELECTRICAL ENGINEER:

6021 12TH STREET E, SUITE 200

EMAIL: brian.maloney@bceengineers.com

CONTACT: BRIAN MALONEY

BCE ENGINEERS, INC

FIFE. WA 98424

TEL: 253.922.0446

ARCHITECT: SHKS ARCHITECTS 1050 NORTH 38TH ST SEATTLE, WA 98103 TEL: 206.675.9151

GREENBUSCH GROUP 1900 W NICKERSON ST SEATTLE, WA 98119 TEL: 206.378.0569 x112

CONTACT: LEVI JETTE EMAIL: levii@shksarchitects.com

VERTICAL / MECHANICAL ENGINEER CONTACT: DYLAN TURNER

EMAIL: dylant@greenbusch.com

PARCEL NUMBER	
282406-9105	

ZONING ANALYSIS

LEGAL DESCRIPTION POR OF SE 1/4 OF SE 1/4 STR 28-24-06 DAF - BEG

396.00 FT W OF SE COR OF SD SEC TH N 165.00 FT TH W 264.00 FT TH S 165.00 FT TH E 264.00 FT TO BEG LESS POR FOR STREET

35,640 SF (.82 ACRES)

MF-M

CURRENT USE

YEAR BUILT 1972

(E) BLDG AREA 29,037 SF (GROSS)

(E) LOT COVERAGE

NO CHANGE

NO CHANGE

PARKING QUANTITY NO CHANGE

REQUIRED SETBACKS NO CHANGE

APPLICABLE CODES

- WASHINGTON STATE AMENDMENTS
- 2009 ICC A117.1 ACCESSIBILITY REQUIREMENTS 2018 INTERNATIONAL MECHANICAL CODE WITH
- WASHINGTON STATE AMENDMENTS
- COMMERCIAL WITH WASHINGTON STATE AMENDMENTS
- STATE AMENDMENTS
- ALL CODES ADOPTED AND AMENDED BY THE STATE BUILDING CODE COUNCIL IN CHAPTER 51 WA
- L&I HEALTH AND SAFETY, RCW 39.75

A0.0	COVER SHEET
A1.0	SITE PLAN & FLOOR PLA

- A3.0 DETAILS & INTERIOR ELEVATIONS
- HP LOAD CALCULATION, SCHEDULES, AND

- EV2.1 ELEVATOR LANDING AND MACHINE ROOM ELEVATOR
- ELECTRICAL SITE PLAN
- ELECTRICAL ONE-LINE DIAGRAM
- E6.2 PANEL SCHEDULES

- ISSAQUAH MUNICIPAL CODE
- 2018 INTERNATIONAL BUILDING CODE WITH WASHINGTON
- STATE AMENDMENTS 2018 INTERNATIONAL EXISTING BUILDING CODE WITH
- 2018 INTERNATIONAL ENERGY CONSERVATION CODE,
- 2018 UNIFORM PLUMBING CODE WITH WASHINGTON
- STATE AMENDMENTS 2018 INTERNATIONAL FIRE CODE WITH WASHINGTON
- WASHINGTON ADMINISTRATIVE CODE, CHAPTER 296-96

SHEET INDEX


- A2.0 ENLARGED FLOOR PLANS
- MO.1 ABBREVS, LEGEND, DRAWING INDEX, GENERAL NOTES.
- MECHANICAL DETAILS MD2.1 MECHANICAL DEMOLITION FLOOR PLANS
- MECHANICAL FLOOR PLANS
- EVD2.1 ELEVATOR LANDING AND MACHINE ROOM ELEVATOR DEMOLITION FLOOR PLANS
- FLOOR PLANS
- EV2.2 ELEVATOR DIAGRAMS
- ELECTRICAL LEGEND
- E2.0 ENLARGED ELECTRICAL PLANS
- E6.1 PANEL SCHEDULES

Checked: Date: 5/21/2021 Scale:

120 W SUNSET WAY

ISSAQUAH, WA 98027

Drawn by:

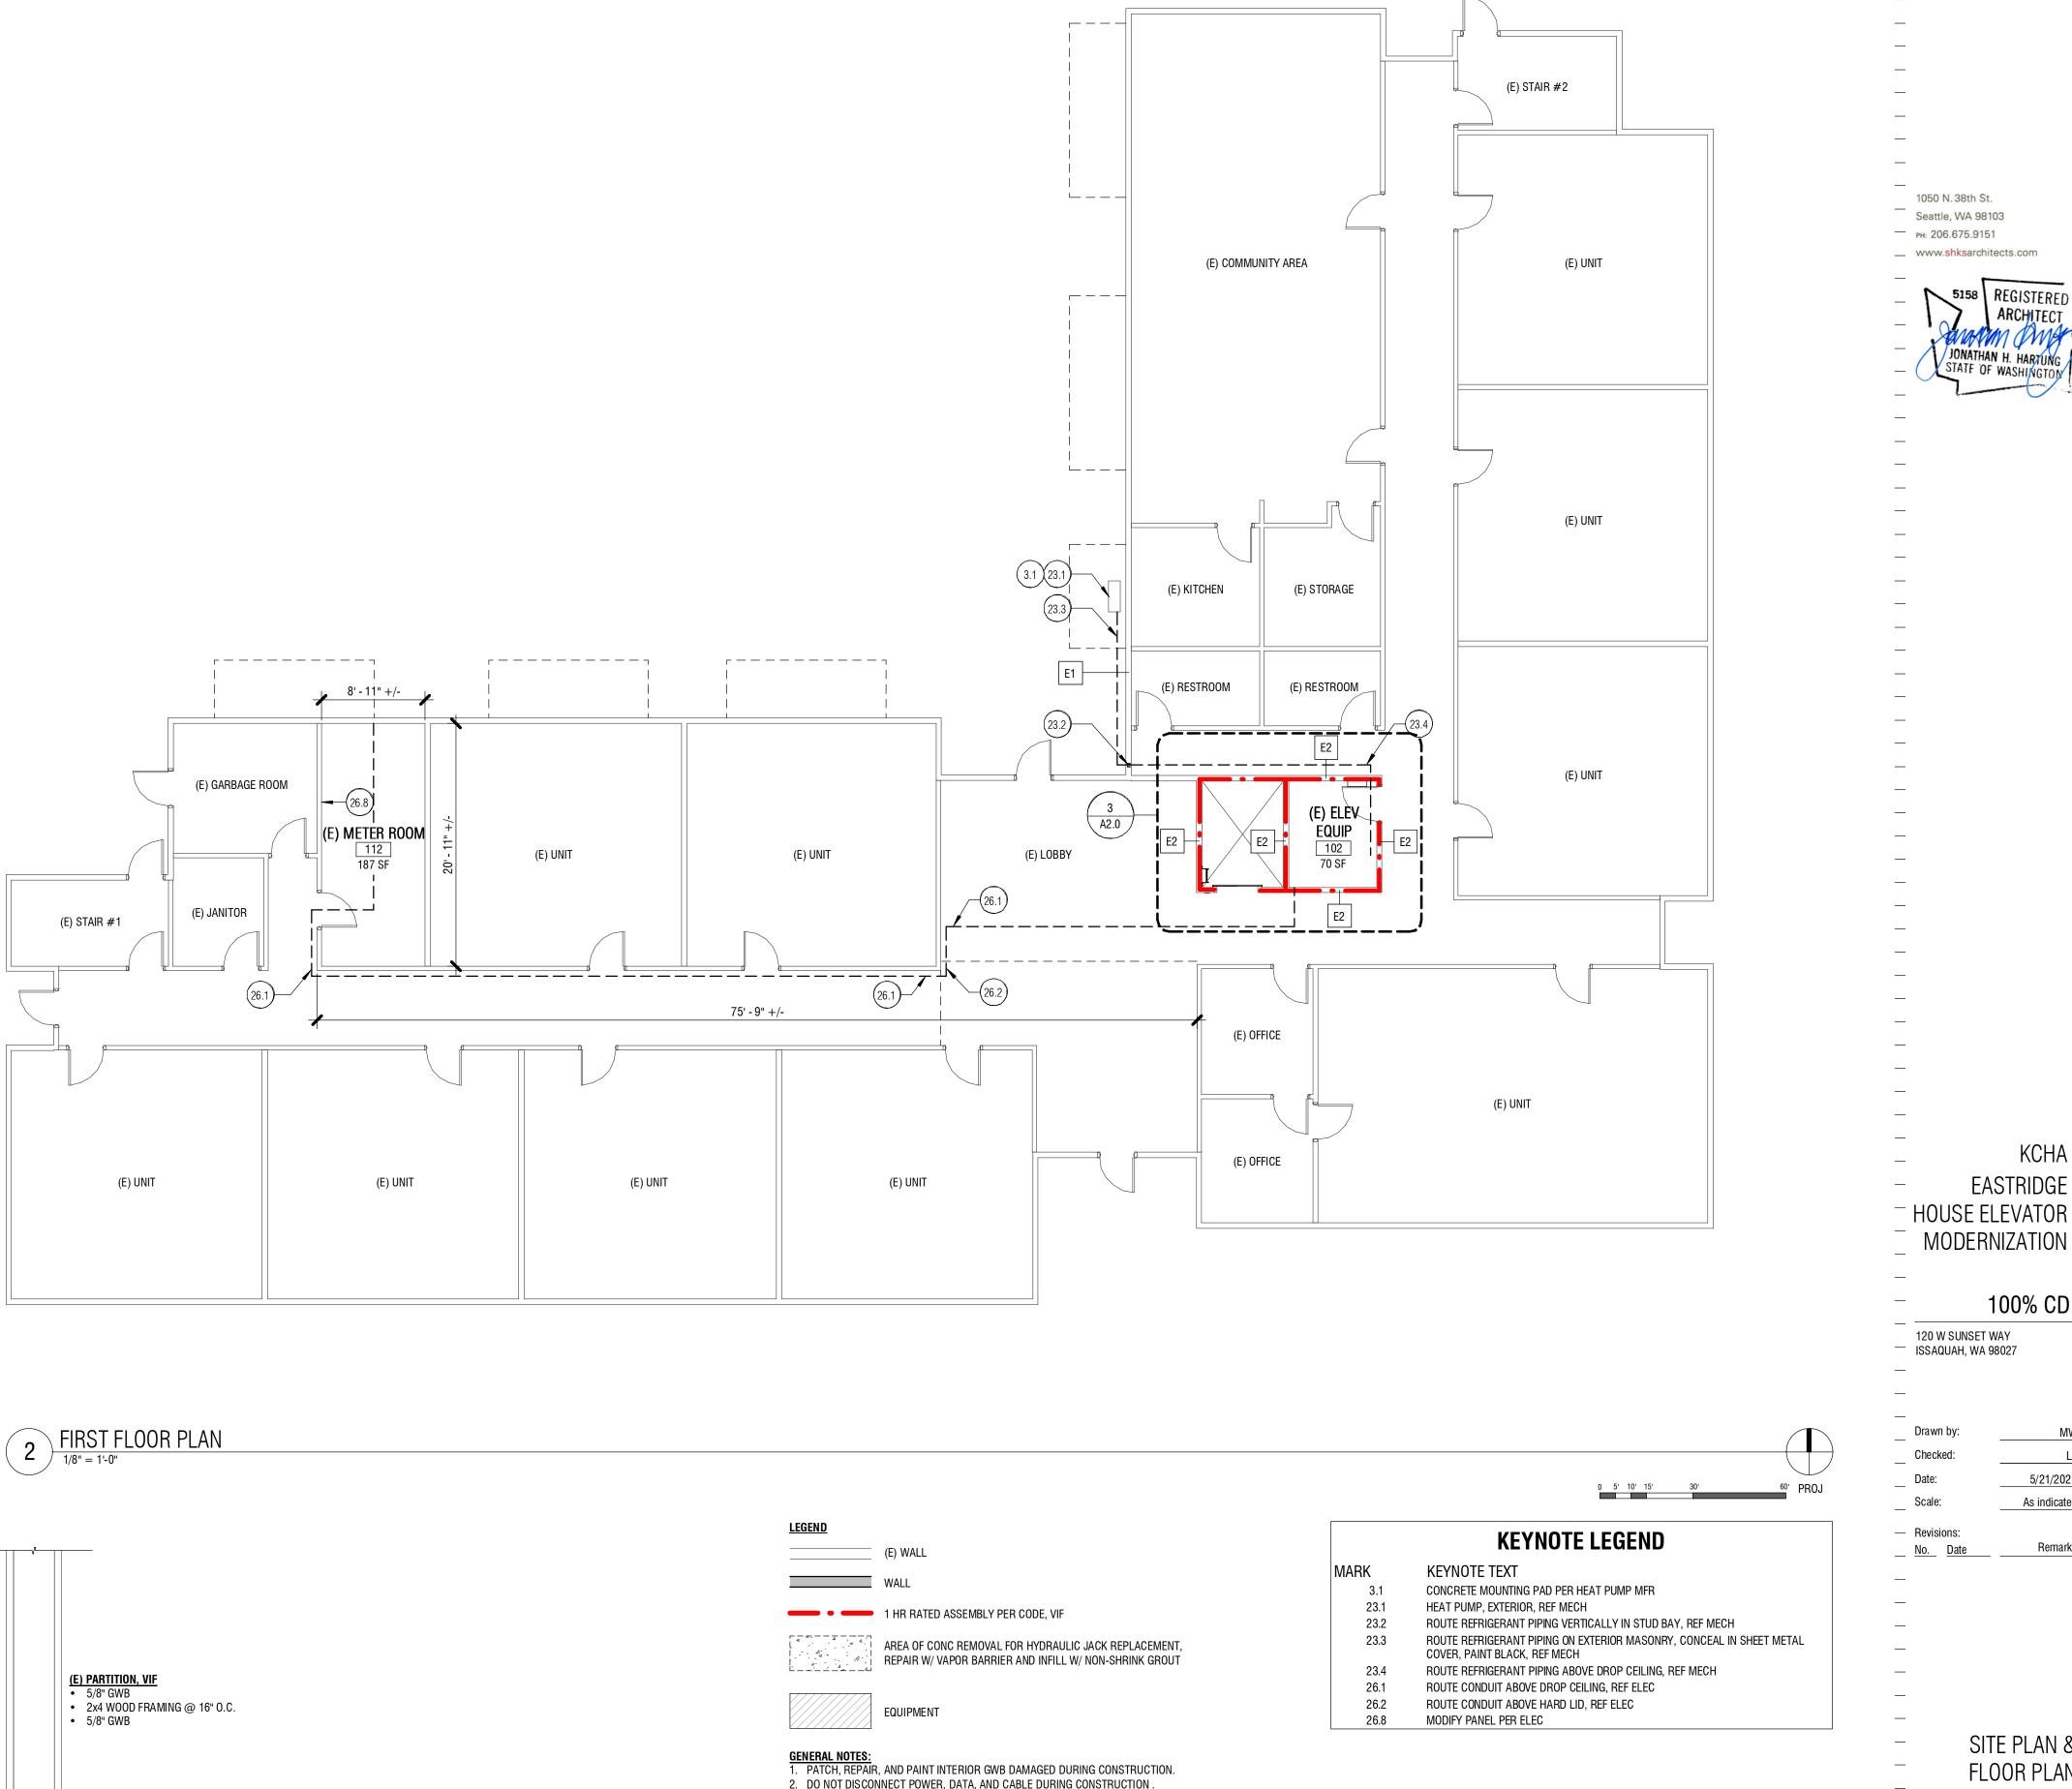

(E) BLDG (E) BLDG 264.0' PL (E) CONC _ WALKWAY -(E) TRANSFORMER (E) BUILDING 120 W SUNSET WAY ISSAQUAH, WA 98027 264.0' PL NW SUNSET WAY —··—··—··—··—··—··— (E) BLDG

SITE PLAN

1" = 40'-0"

WALL TYPES

(E) EXTERIOR FRAMED WALL, VIF
• (E) BRICK VENEER (E) 1-HOUR SEPARATION WALL, VIF • (E) 1" AIR SPACE • (E) 2x6 WD FRAMING @ 16" O.C. (E) 1/2" GYP SHEATHING
(E) 2x6 WD FRAMING @ 16" O.C. • (E) 5/8" GWB • (E) 5/8" GWB

(E) PARTITION, VIF • 2x4 WOOD FRAMING @ 16" O.C.

(E) STAIR #1

(E) UNIT

2. DO NOT DISCONNECT POWER, DATA, AND CABLE DURING CONSTRUCTION . 3. COORDINATE REQUIRED SHUTDOWNS WITH OWNER.

Scale:

SITE PLAN & FLOOR PLAN


KCHA

EASTRIDGE

100% CD

5/21/2021

As indicated

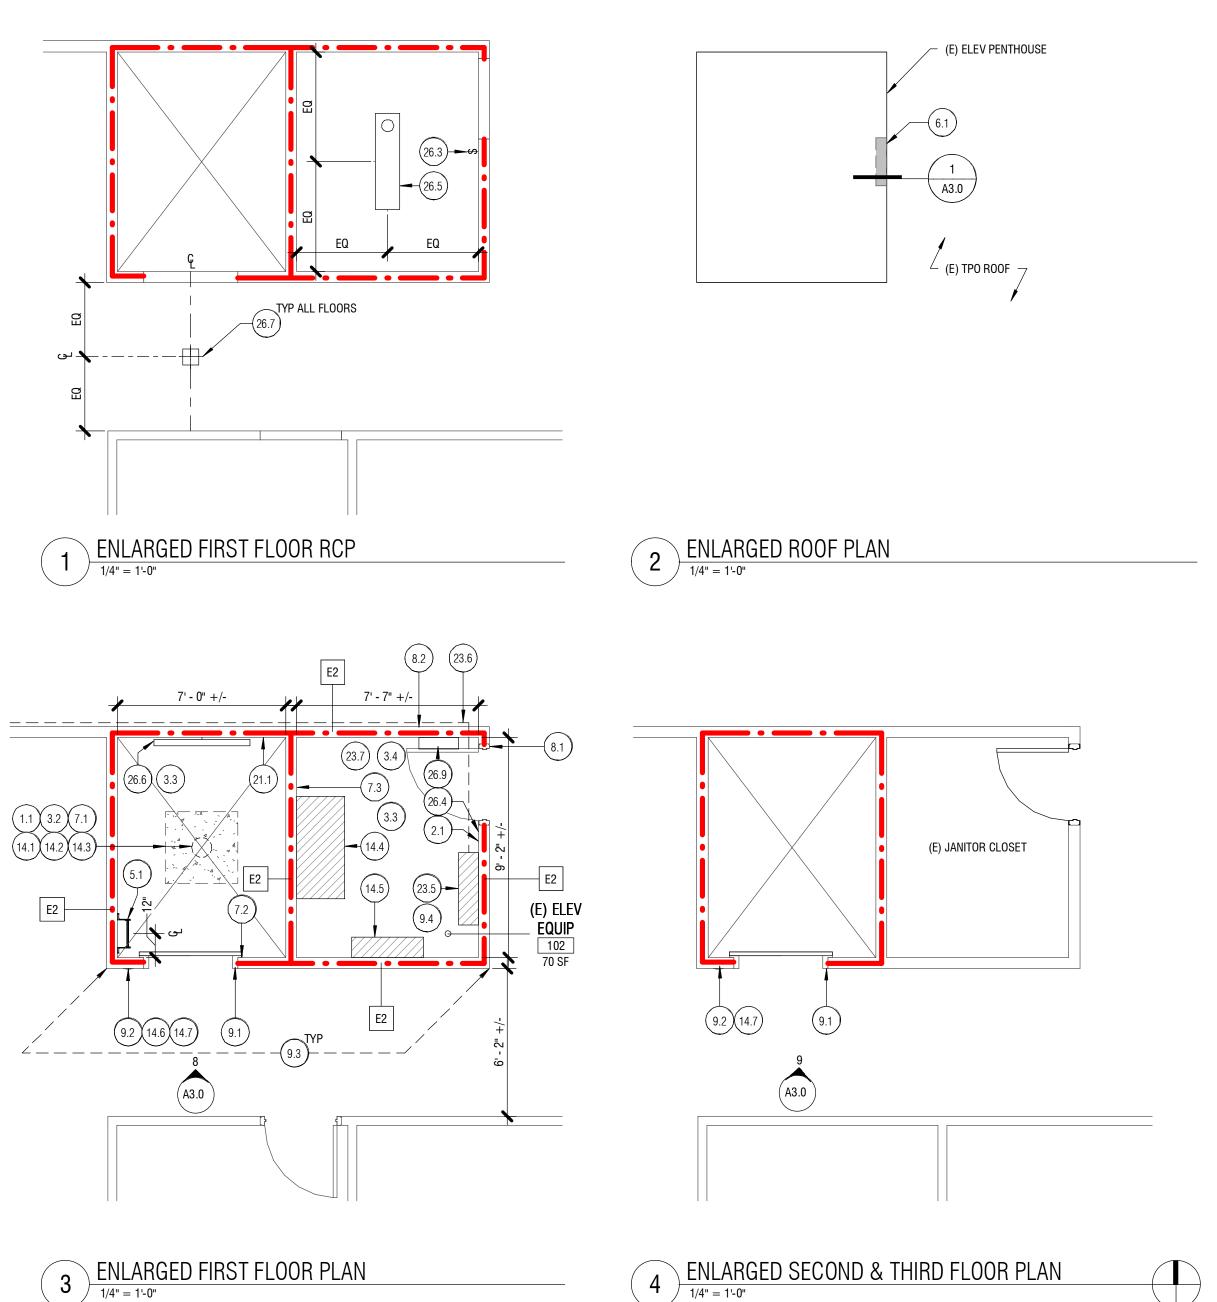

REPAIR W/ VAPOR BARRIER AND INFILL W/ NON-SHRINK GROUT **EQUIPMENT** GENERAL NOTES:

1. PATCH, REPAIR, AND PAINT INTERIOR GWB DAMAGED DURING CONSTRUCTION. 2. DO NOT DISCONNECT POWER, DATA, AND CABLE DURING CONSTRUCTION. 3. COORDINATE REQUIRED SHUTDOWNS WITH OWNER. **KEYNOTE LEGEND** KEYNOTE TEXT ADD ALT 1: REMOVE AND REPLACE SECONDARY CYLINDER CASING, INCLUDE 1.1 REQUIRED HOURS IN BID, REF MECH SALVAGE & REINSTALL (E) FIRE EXTINGUISHER INFILL (E) SLAB WITH 3000 PSI NON-SHRINK GROUT, INSTALL HYDROPHILIC WATERSTOP TO SEAL NEW CONCRETE AGAINST (E) CAP (E) DRAIN AND SKIM COAT OVER CAP (E) CLEANOUT AND SKIM COAT OVER METAL PIT LADDER, REMOVE AND REPLACE, CONTRACTOR RESPONSIBLE FOR PROVISION OF CODE COMPLIANT LADDER DEMO AND INFILL (E) HOISTWAY WALL VENT, 18" H x 24" W REPAIR BELOW-GRADE VAPOR BARRIER DAMAGED BY HYDRAULIC JACK REMOVAL PACK HOISTWAY DOOR FRAME WITH FIRESAFE INSULATION AND SEAL WITH FIRESTOP SEALANT ON HOISTWAY SIDE SEAL THROUGH PENETRATION WITH PENETRATION FIRESTOP SYSTEM REMOVE DOOR & FRAME, REPLACE W/ FIRE RATED HM DOOR & FRAME, 36" x 80" x 1-1/2", 45 MIN RATING, SELF CLOSING AND LOCKING REMOVE (E) VALVE ACCESS PANEL IN ELEVATOR MACHINE ROOM, REPLACE W/ ACCESS PANEL IN HALLWAY, APPROX 8" x 8", CONTRACTOR TO COORDINATE FINAL PATCH & SAND SMOOTH, CLEAN, PREP, AND ELECTROSTATIC PAINT AT (E) HOISTWAY DOORS AND FRAMES, COLOR TO MATCH (E) PATCH & REPAIR GWB 6" AROUND EACH HALL FIXTURE 9.3 PAINT FULL LENGTH OF WALL, FLOOR TO CEILING, COLOR TO MATCH EXISTING APPLY EPOXY-BASED SEAMLESS FLOORING SYSTEM W/ INTEGRAL COVE BASE THROUGHOUT ELEVATOR MACHINE ROOM REMOVE & REPLACE ELEVATOR JACK, DO NOT DAMAGE (E) CONCRETE REINFORCING IN REMOVAL OF JACK, REF ELEVATOR AFTER REMOVAL OF (E) ELEVATOR JACK, REVIEW CONDITION OF (E) MTL CASING W/ REMOVE & REPLACE CAB INTERIOR, REF ELEVATOR & A3.0 REMOVE & REPLACE HYDRAULIC POWER UNIT, REF ELEVATOR REMOVE & REPLACE CONTROLLER, REF ELEVATOR REMOVE & REPLACE ELEVATOR CALL BUTTONS, FIRE SIGNAGE, INTERCOM, PHASE 1 KS, COMM FAILURE, KEY BOX, AND HALL LANTERN W/ POSITION INDICATOR & DIRECTION OF TRAVEL, REF ELEVATOR ELEVATOR CALL BUTTONS TO BE ACCESSIBLE IN ACCORDANCE WITH IBC 1101.2 AND ICC A117.1, REF ELEVATOR ACCESSIBILITY REQUIREMENTS A3.0 EXTEND (E) FIRE SPRINKLER HEAD, REF MECH WALL MOUNT HEAT PUMP, INTERIOR, REF MECH REFRIGERANT PIPING, CUT AND PATCH AT ALL PENETRATIONS, REF MECH 23.7 THERMOSTAT, REF MECH 26.3 REMOVE & REPLACE LIGHT SWITCH, REF ELEC

26.4

26.5

26.6 26.7

26.9

REMOVE & REPLACE DISCONNECT, REF ELEC

REMOVE & REPLACE LIGHT FIXTURE, REF ELEC

LIGHT FIXTURE AT ELEVATOR DOOR, REF ELEC

PANEL, REF ELEC

REMOVE & REPLACE PIT LIGHT & LIGHT SWITCH, REF ELEC

(E) WALL

1 HR RATED ASSEMBLY PER CODE, VIF

AREA OF CONC REMOVAL FOR HYDRAULIC JACK REPLACEMENT,

— 1050 N. 38th St.
— Seattle, WA 98103
— PH: 206.675.9151
— www.shksarchitects.com

5158 REGISTERED ARCHITECT

JONATHAN H. HARTUNG STATE OF WASHINGTON

KCHAEASTRIDGEHOUSE ELEVATORMODERNIZATION

100% CD

120 W SUNSET WAY
— ISSAQUAH, WA 98027


Drawn by: MW
Checked: LJ
Date: 5/21/2021
Scale: 1/4" = 1'-0"

Revisions:
No. Date ____

ENLARGED FLOOR PLANS

Remarks

A2.0

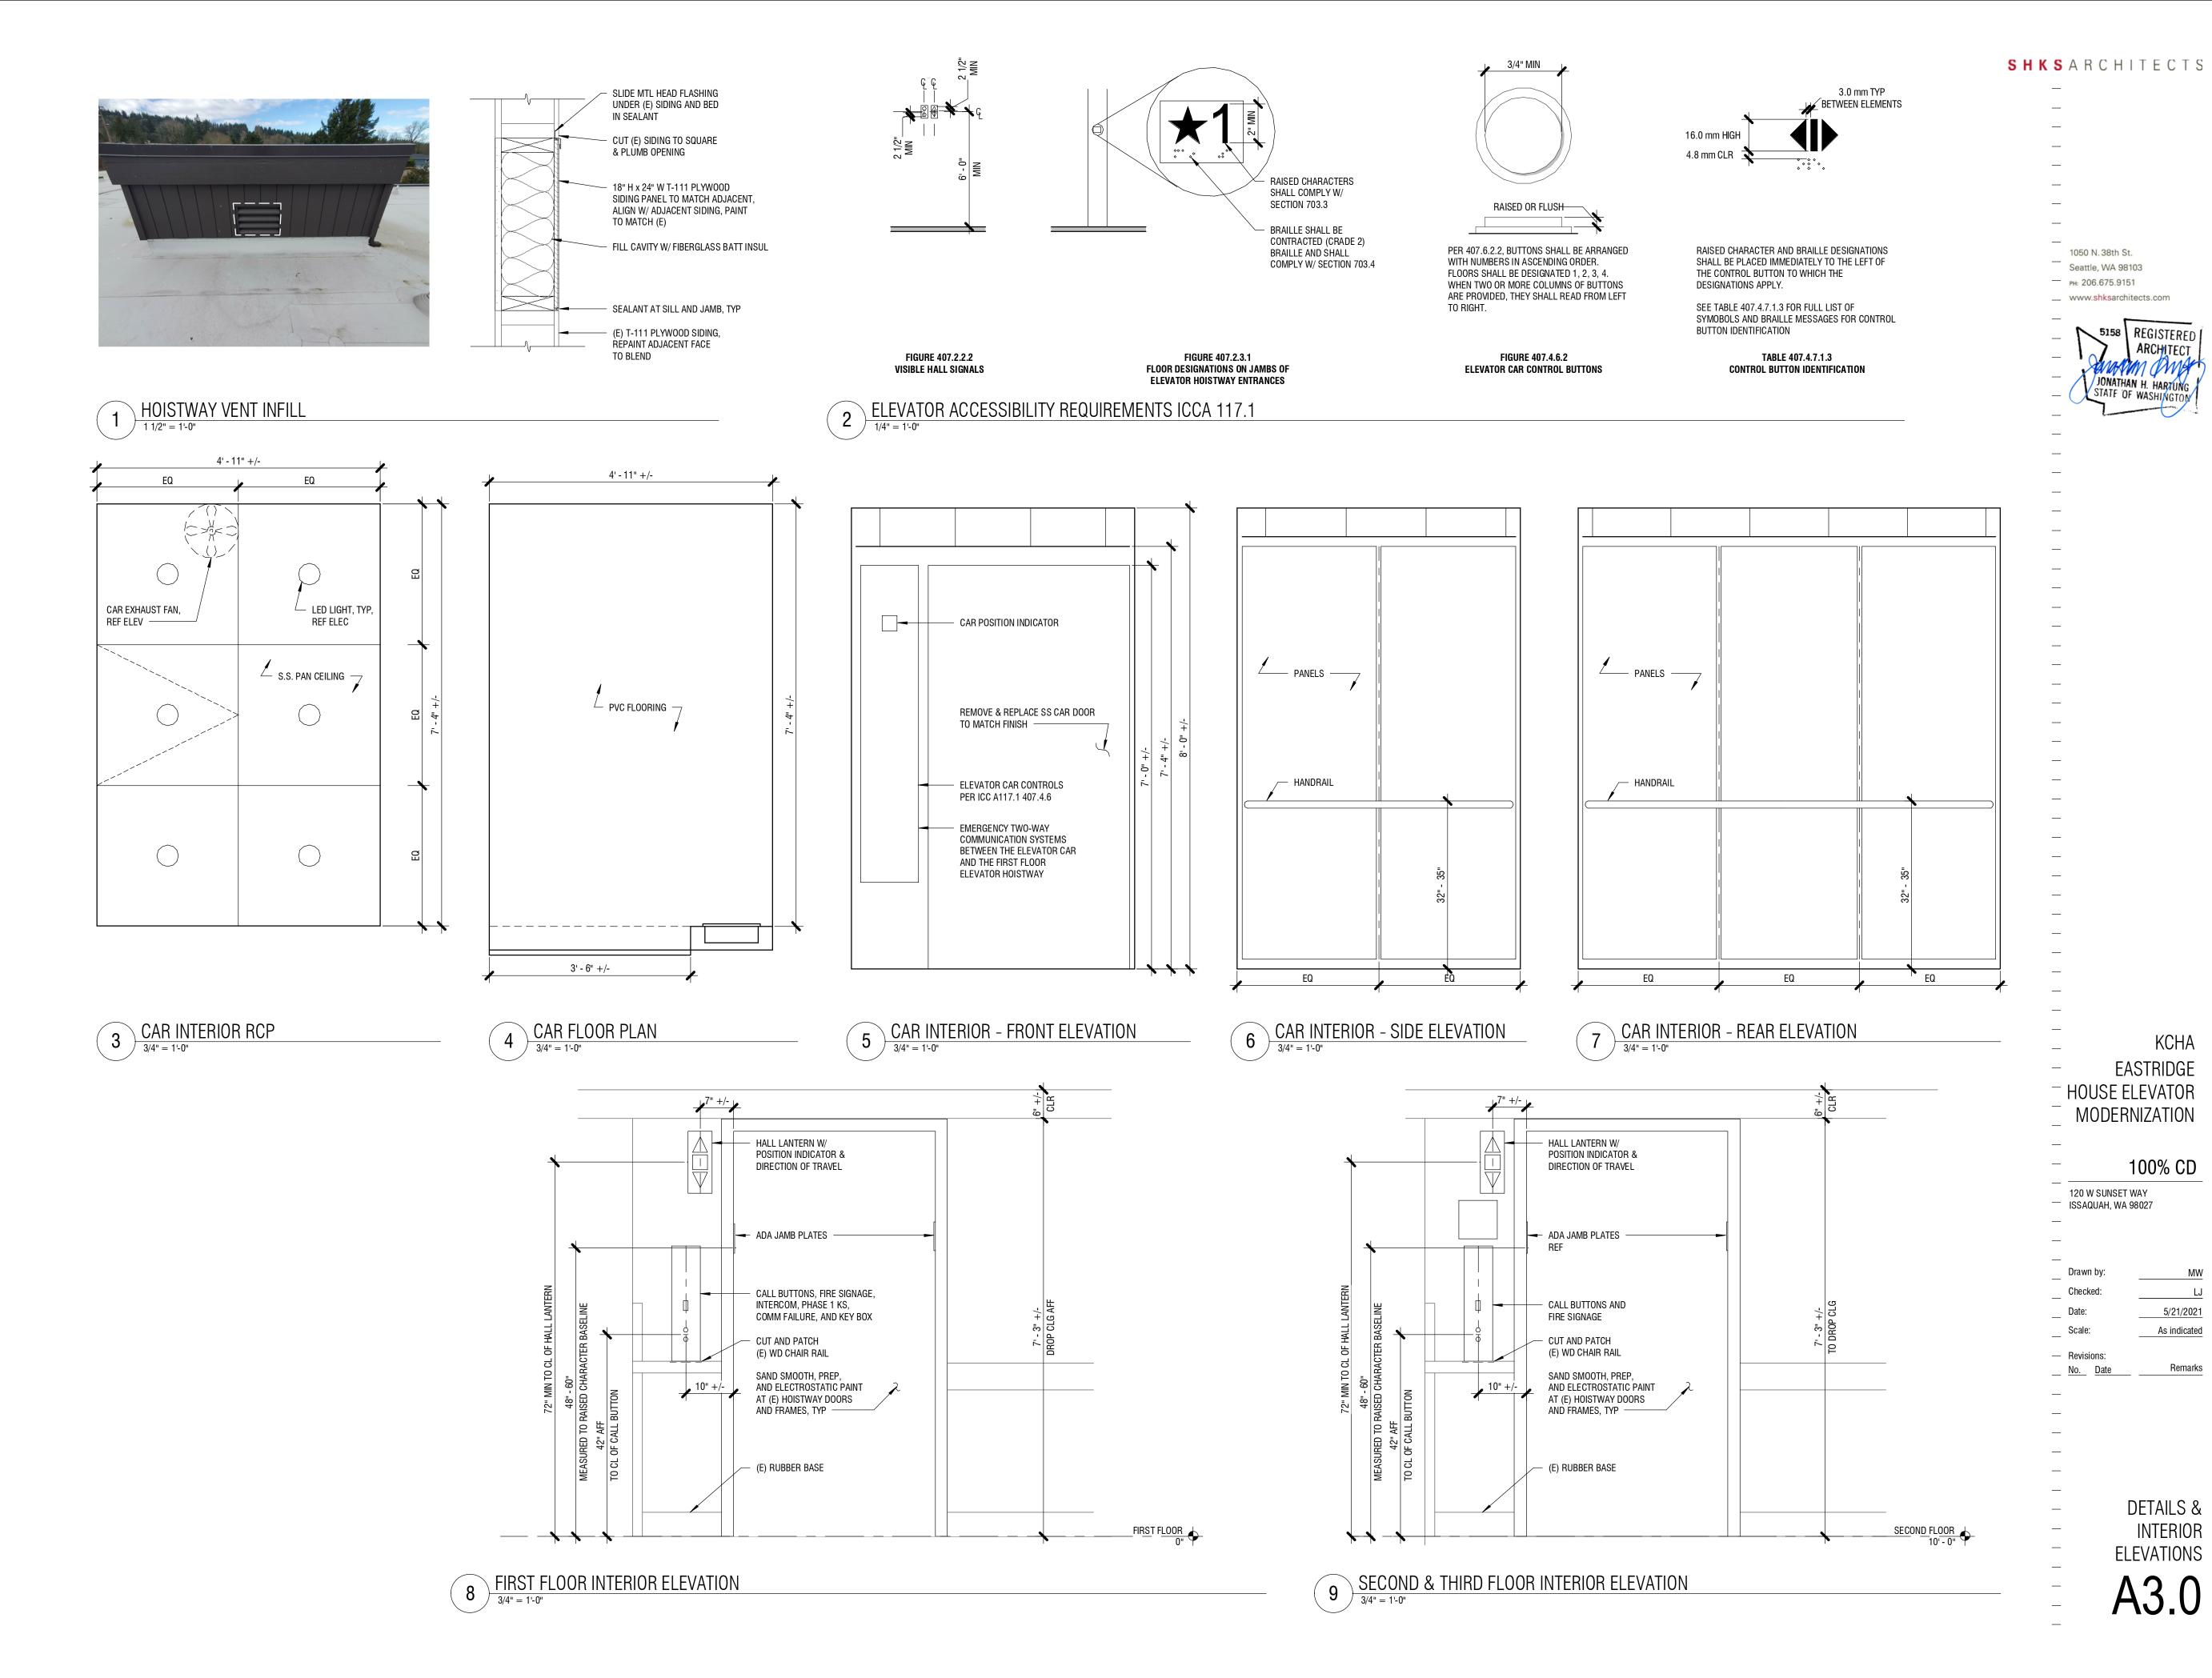

ELEVATIONS

DETAILS &

INTERIOR

KCHA


EASTRIDGE

100% CD

5/21/2021

____As indicated

Remarks

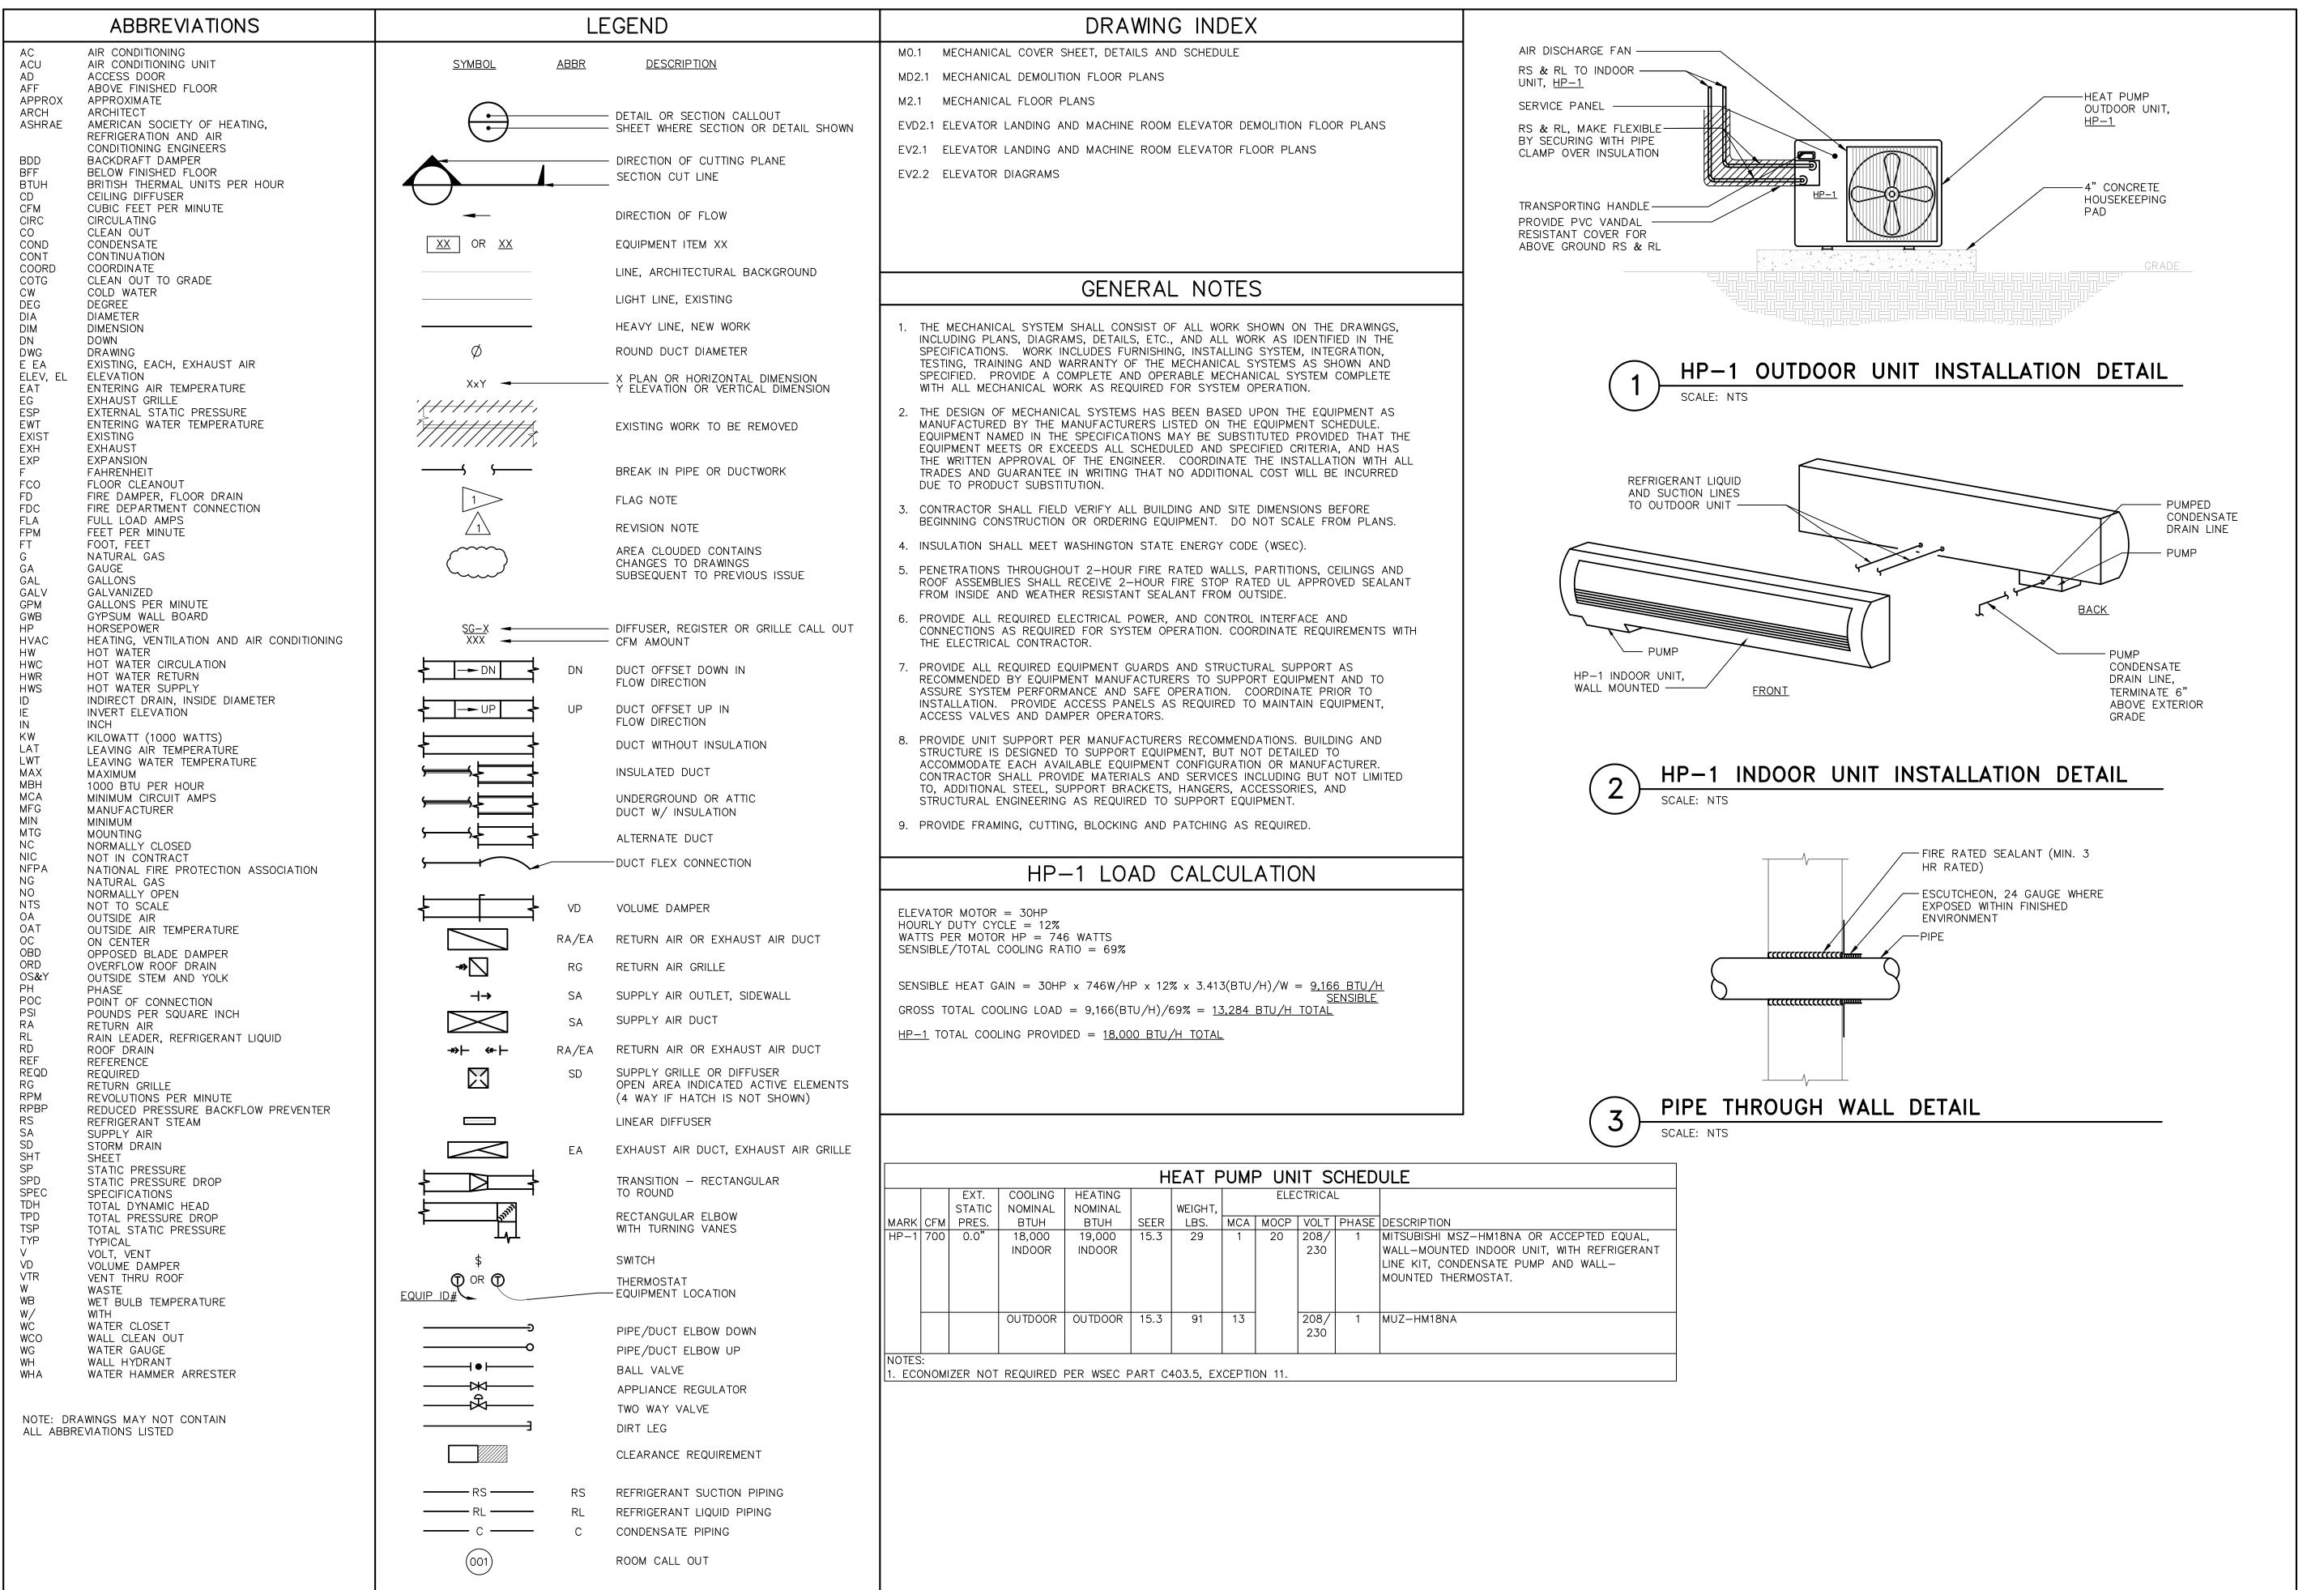

SHKSARCHITECTS

1050 N. 38th St.
Seattle, WA 98103
PH: 206.675.9151

www.shksarchitects.com
 THE GREENBUSCH GROUP, INC

ACOUSTICAL, AUDIO / VIDEO & MECHANICAL ENGINEERINI 1900 WEST NICKERSON STREET SUITE 201 SEATTLE. WA 9811

RICHARD

RICHARD

WASHING

S3373

OH SGISTER

SSIONAL ENGINE

_ KCHA - EASTRIDGE - HOUSE ELEVATOR - MODERNIZATION

100% CD

120 W SUNSET WAY
SSAQUAH, WA 98027

Drawn by: E0
Checked: RF
Date: 05/21/2021
Scale: As indicated


Revisions:

No. Date Remarks

---MECHANICAL COVER

SHEET, DETAILS ANDSCHEDULE

M0.1

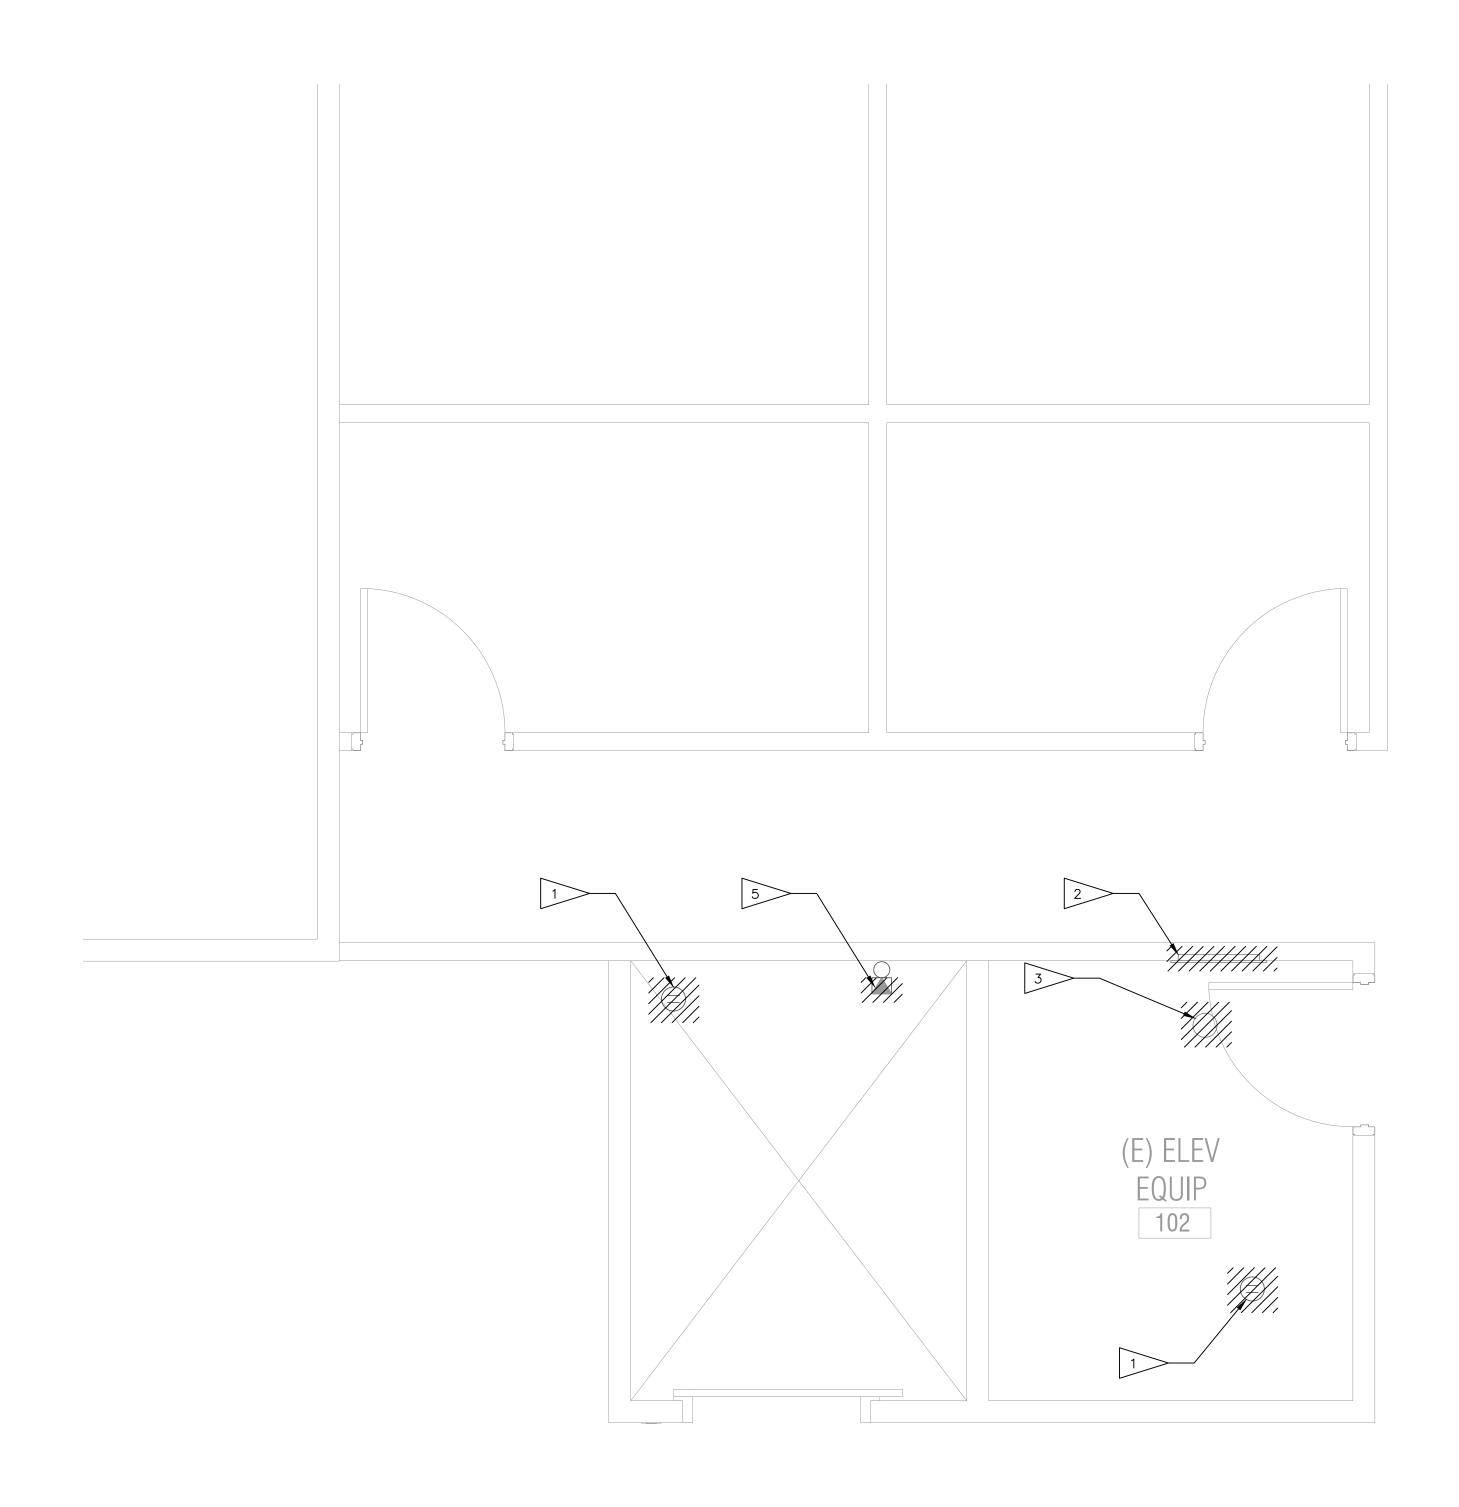

1 ENLARGED FIRST FLOOR MECHANICAL DEMOLITION PLAN

SCALE:1/2" = 1'-0"



GENERAL DEMOLITION NOTES:

 THE DEMOLITION DRAWINGS ARE DIAGRAMMATIC IN NATURE. CONTRACTOR IS RESPONSIBLE FOR COMPLETE REMOVAL OF INDICATED SYSTEMS & ASSOCIATED APPURTENANCES

FLAG NOTES:


1 EXISTING FLOOR DRAIN, CAP PIPE AND PATCH FLOOR PER ARCHITECTURAL.

2 REMOVE EXISTING VALVE ACCESS PANEL AND PATCH AND PAINT WALL PER ARCHITECTURAL.

3 EXISTING FLOOR CLEANOUT, CAP AND PATCH FLOOR PER ARCHITECTURAL.

REMOVE EXISTING LOUVER IN HOISTWAY OVERRUN ABOVE LEVEL 3. PATCH WALL PER ARCHITECTURAL.

5 REMOVE EXISTING SPRINKLER HEAD.

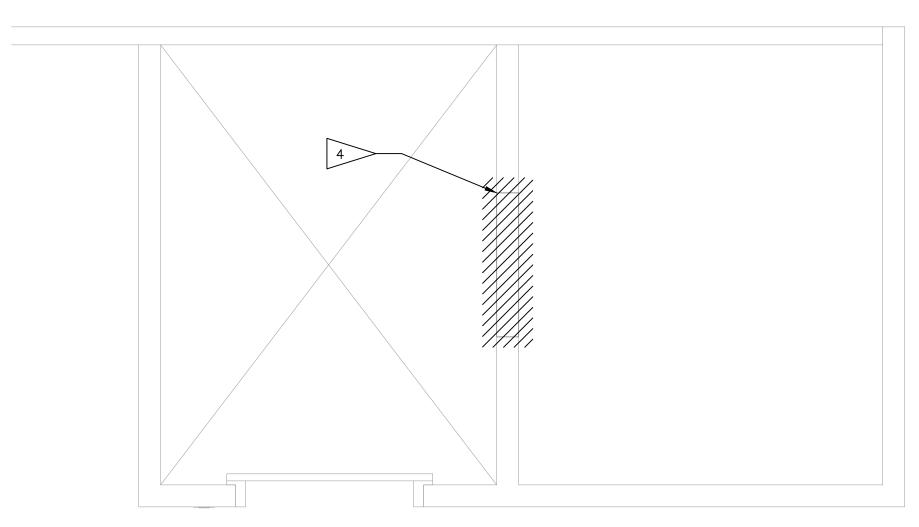



2 ENLARGED SECOND & THIRD FLOOR MECHANICAL DEMOLITION PLAN

SCALE:1/2" = 1'-0"




SHKSARCHITECTS
-

— рн: 206.675.9151

____ www.shksarchitects.com

THE GREENBUSCH GROUP, INC

ACOUSTICAL, AUDIO / VIDEO & MECHANICAL ENGINEERING 1900 WEST NICKERSON STREET SUITE 201 SEATTLE, WA 98119 (206) 378—0569

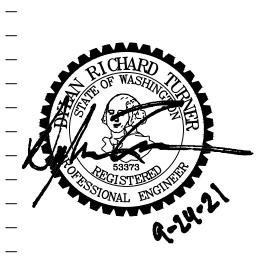

KCHA
EASTRIDGE
HOUSE ELEVATOR
MODERNIZATION

100% CD


120 W SUNSET WAY
ISSAQUAH, WA 98027

_____ Drawn by: _____ E0 ____ Checked: ____ RF ____ Date: _____ 05/21/2021 ____ Scale: ____ As indicated

- Revisions:
No. Date Rei

MECHANICAL DEMOLITION FLOOR PLANS

MD2.1

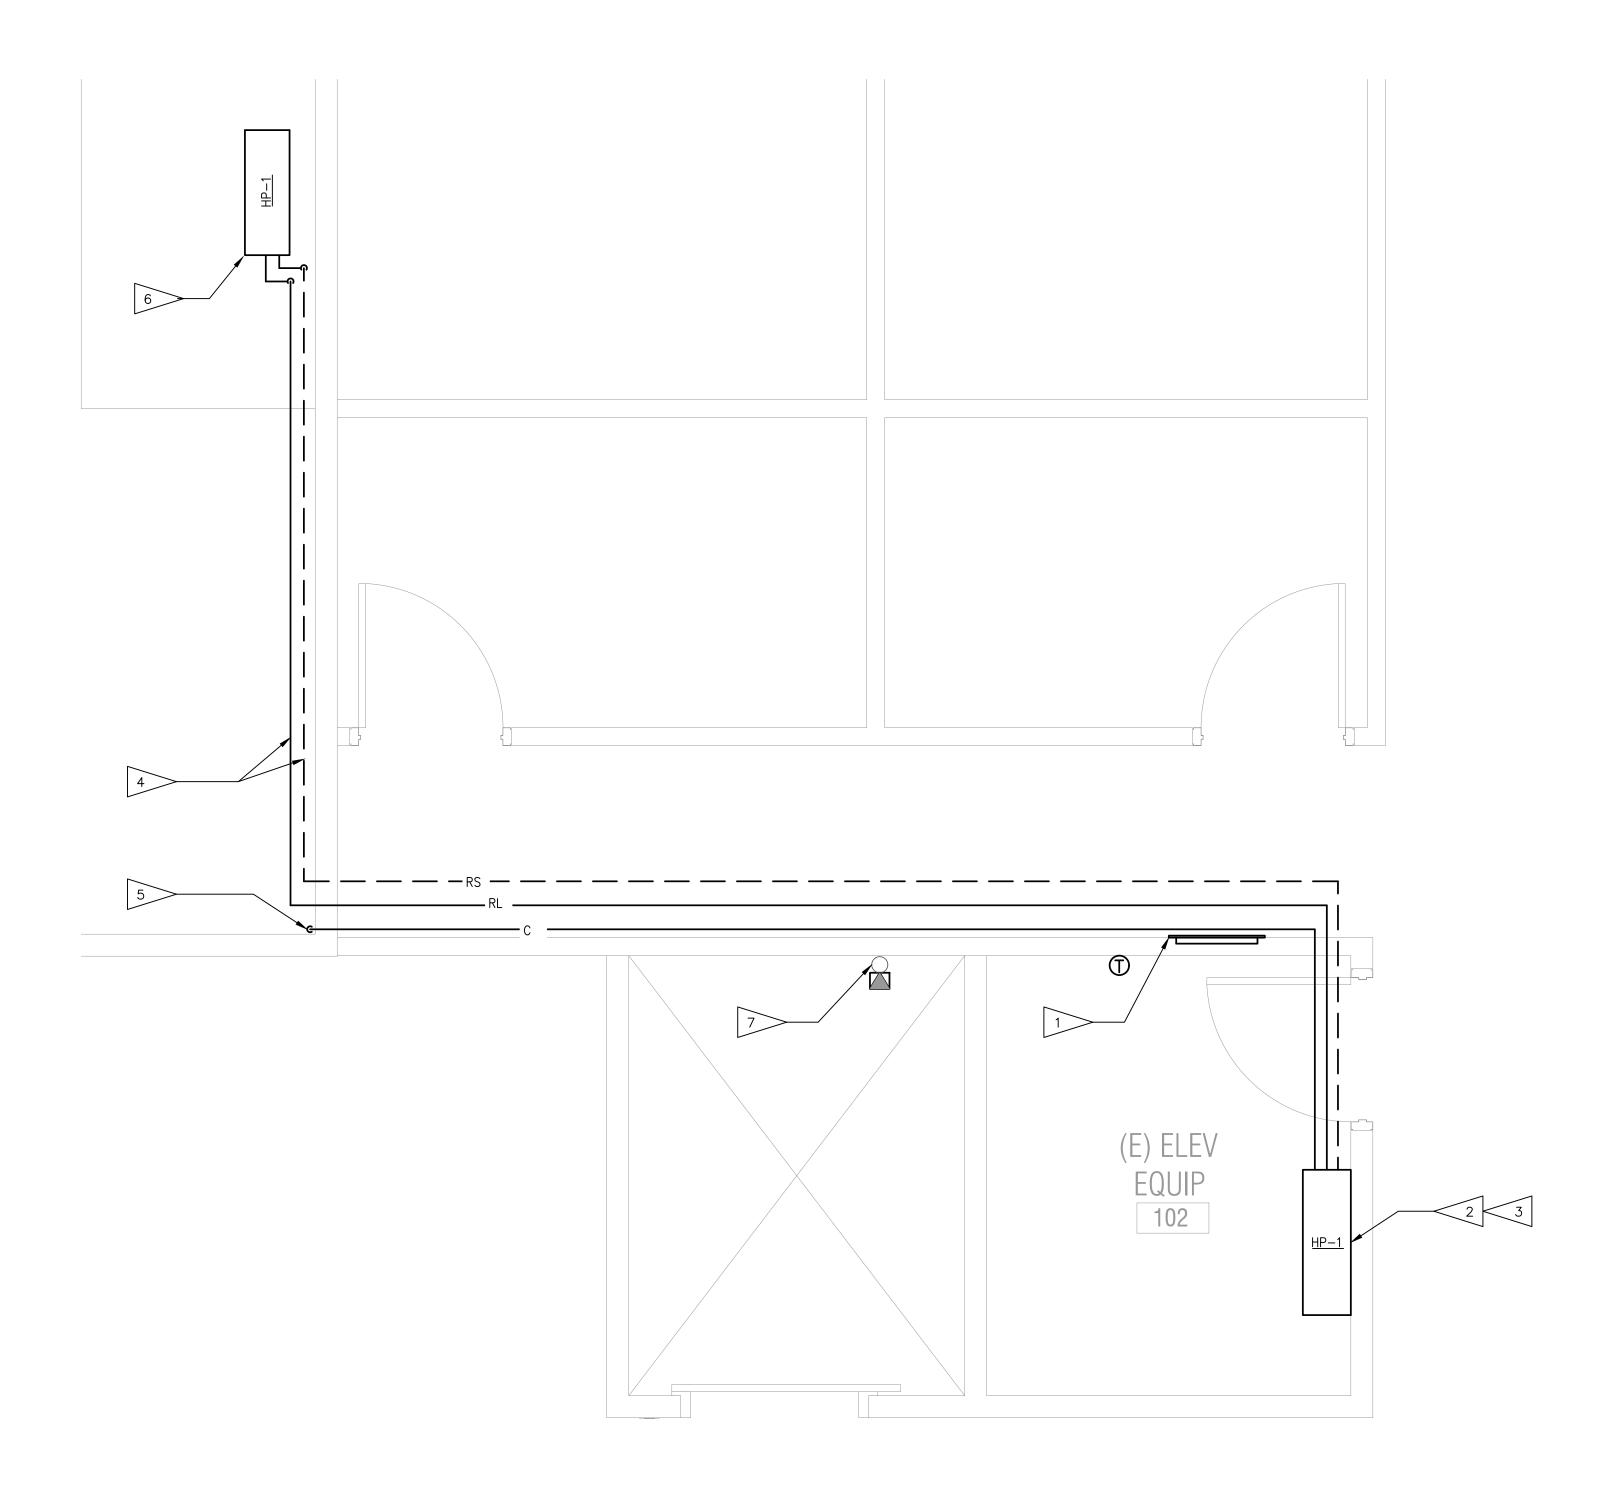

1 ENLARGED FIRT FLOOR MECHANICAL PLAN

SCALE:1/2" = 1'-0"



SHEET NOTES:

1. PROVIDE CUTTING AND PATCHING AS SPECIFIED AND AS REQUIRED TO INSTALL NEW PIPING AND EQUIPMENT.

FLAG NOTES:

1 PROVIDE NEW LOCKABLE VALVE ACCESS COVER. SEE ARCHITECTURAL.




3 INSTALL <u>HP-1</u> INDOOR UNIT IN ELEVATOR MACHINE ROOM. ROUTE RL/RS TO THE <u>HP-1</u> OUTDOOR UNIT MOUNTED OUTDOORS.

PROVIDE SHEETMETAL CONTAINMENT FOR ALL EXPOSED REFRIGERANT AND CONDENSATE PIPING. PAINT BLACK.

5 PUMP CONDENSATE TO EXTERIOR. TERMINATE 6" ABOVE GRADE.

6 COORDINATE FINAL <u>HP-1</u> OUTDOOR UNIT LOCATION WITH KCHA CONSTRUCTION MANAGER.

7 INSTALL NEW SPRINKLER HEAD AT MAX 24" AFF. EXTEND EXISTING SPRINKLER PIPE AS REQUIRED TO CONNECT TO NEW HEAD.

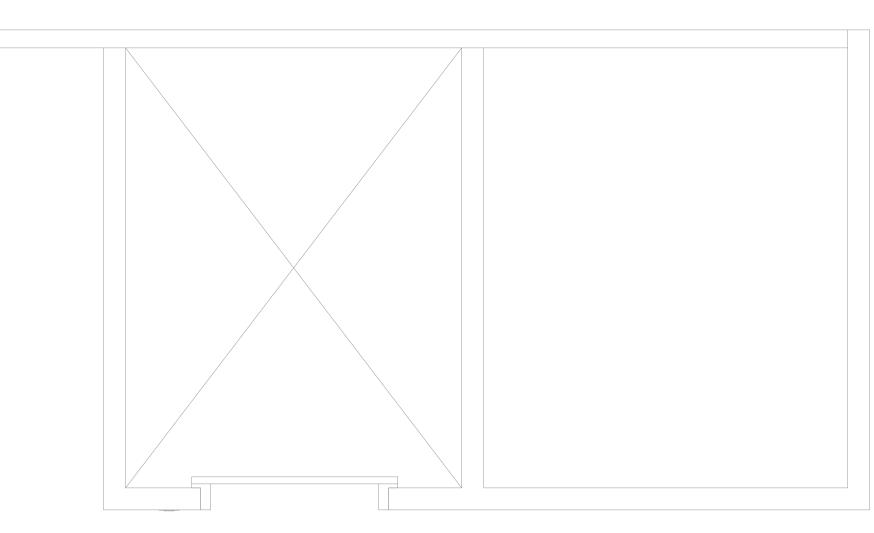

NO MECHANICAL WORK AT SECOND & THIRD FLOOR



2 ENLARGED SECOND & THIRD FLOOR PLAN

SCALE:1/2" = 1'-0"






— 1050 N.38th St. — Seattle, WA 98103

— PH: 206.675.9151

___ www.shksarchitects.com

THE GREENBUSCH GROUP, INC

///

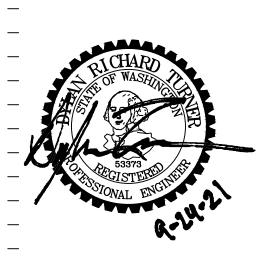

KCHAEASTRIDGEHOUSE ELEVATORMODERNIZATION

100% CD

120 W SUNSET WAY
— ISSAQUAH, WA 98027
—

 Drawn by:
 E0

 Checked:
 RF


 Date:
 05/21/2021


 Scale:
 As indicated

Revisions:No. Date Remarks

ELEVATOR
LANDING AND
MACHINE ROOM
MECHANICAL
FLOOR PLANS

M2.1

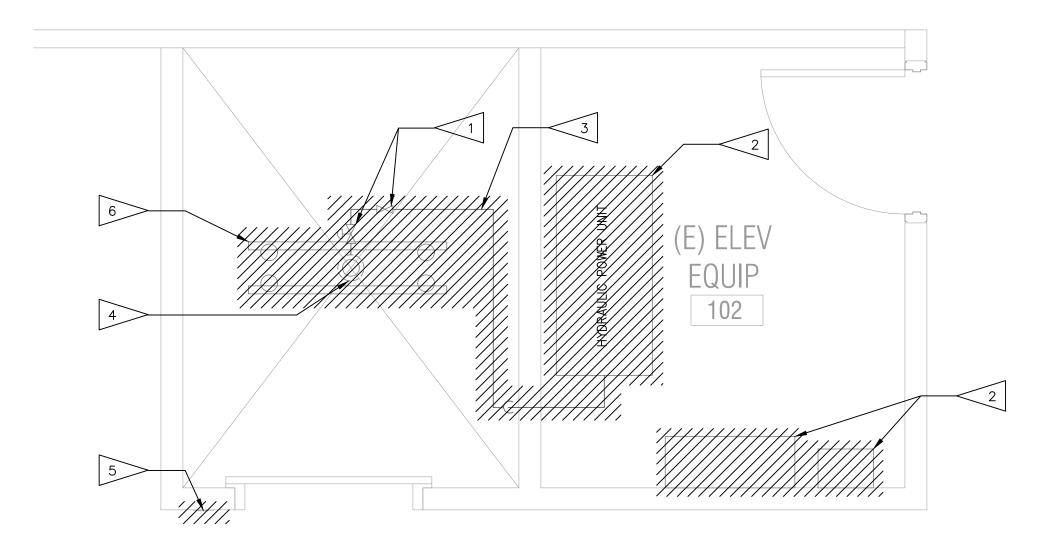

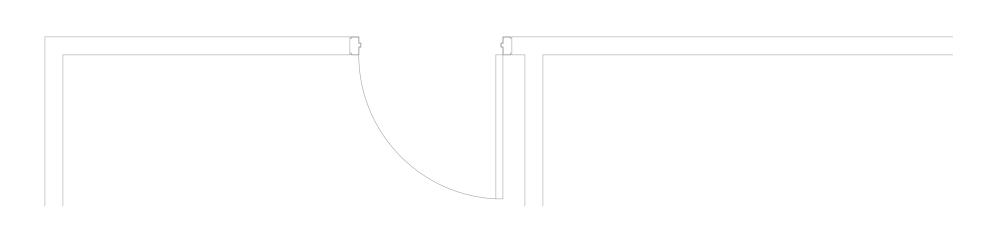

1 ENLARGED FIRST FLOOR ELEVATOR DEMOLITION PLAN
SCALE:1/2" = 1'-0"





GENERAL DEMOLITION NOTES:

- 1. THE DEMOLITION SHOWN DOES NOT ATTEMPT TO COVER ALL ITEMS WHICH MUST BE REMOVED OR REPLACED AS PART OF THE ELEVATOR MODERNIZATION. CONTRACTOR IS NOT RELIEVED FROM PROVIDING ALL DEMOLITION SERVICES REQUIRED TO COMPLETE THE SCOPE SPECIFIED IN THE CONTRACT DOCUMENTS.
- CONTRACTOR IS RESPONSIBLE FOR VERIFYING CONSTRUCTION AND EQUIPMENT ARRANGEMENTS ARE AS SHOWN. REPORT DISCREPANCIES TO OWNER BEFORE DISTURBING EXISTING INSTALLATION.

FLAG NOTES:

- 1 REMOVE EXISTING SHUTOFF VALVE, RUPTURE VALVE AND ASSOCIATED LENGTH OF PIPE TO ALLOW INSTALLATION OF NEW SHUT OFF VALVE AND RUPTURE VALVE.
- 2 REMOVE EXISTING POWER UNIT, ASSOCIATED CONTROLLER & BATTERY LOWERING DEVICE.
- 3 REMOVE EXISTING HYDRAULIC LINES. PATCH EXISTING PENETRATION THROUGH WALL. SEE ARCHITECTURAL.
- 4 REMOVE EXISTING IN-GROUND JACK ASSEMBLY COMPLETE. DEMOLISH SURROUNDING SLAB AS REQUIRED FOR REMOVAL. INCLUDE REPLACEMENT OF SECONDARY CYLINDER CASING AS ADD ALTERNATE 1. INCLUDE REQUIRED HOURS IN BID
- 5 REMOVE EXISTING HALL LANTERNS AND FIXTURES.
- 6 REMOVE EXISTING PIT CHANNELS AND BUFFERS.

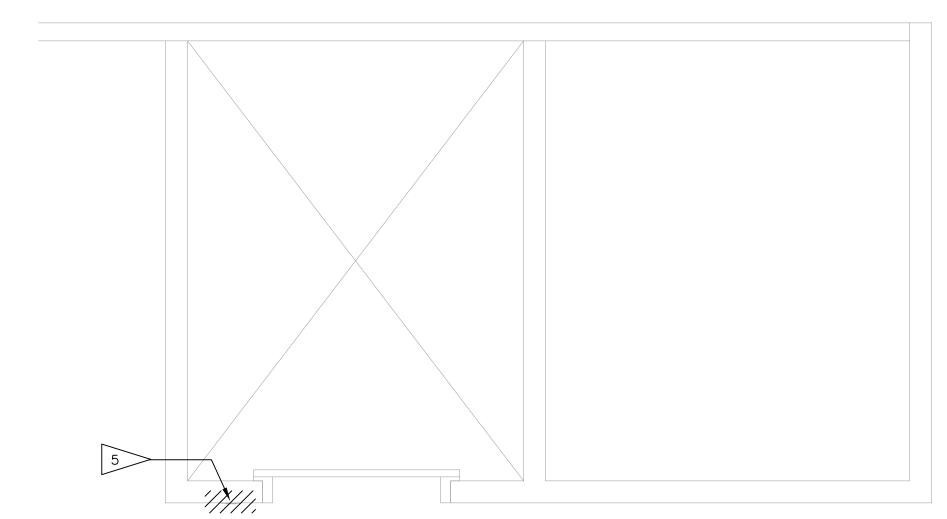

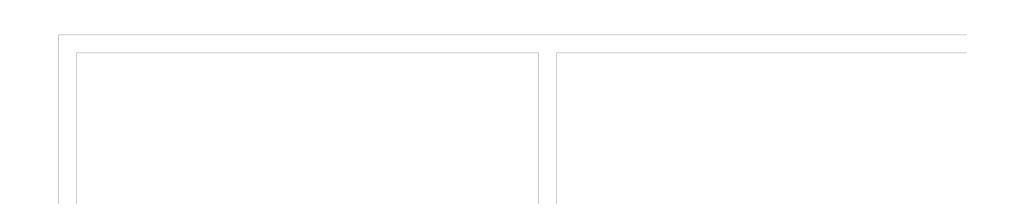

2 ENLARGED SECOND & THIRD FLOOR ELEVATOR DEMOLITION PLAN

SCALE:1/2" = 1'-0"



- 1050 N.38th St.
- Seattle, WA 98103
- PH: 206.675.9151
- www.shksarchitects.com
- THE GREENBUSCH GROUP, INC

S H K S A R C H I T E C T S



KCHA
EASTRIDGE
HOUSE ELEVATOR
MODERNIZATION

100% CD


120 W SUNSET WAY
— ISSAQUAH, WA 98027
—


Drawn by: E0
Checked: RF
Date: 05/21/2021
Scale: As indicated

— Revisions:
____No. <u>Date</u> Rema

ELEVATOR
LANDING AND
MACHINE ROOM
ELEVATOR
DEMOLITION
FLOOR PLANS

EVD2.1

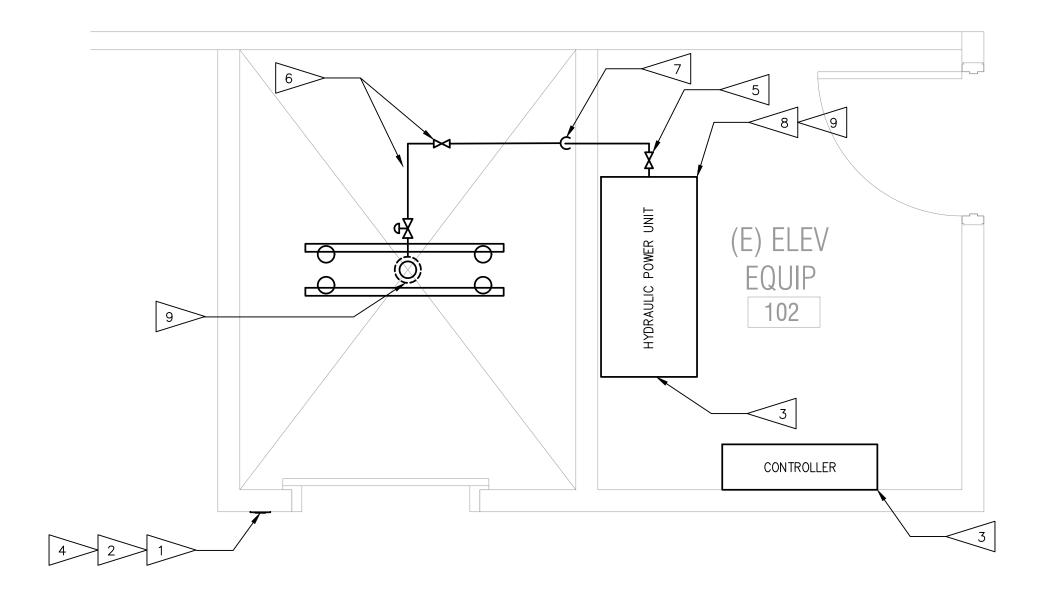

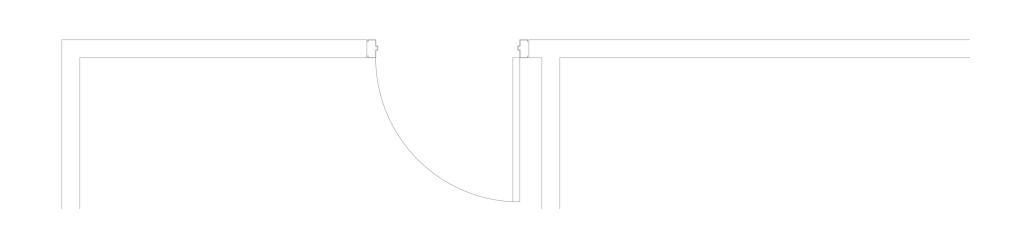

1 ENLARGED FIRST FLOOR ELEVATOR PLAN

SCALE:1/2" = 1'-0"



SHEET NOTES:

 PROVIDE CUTTING AND PATCHING AS SPECIFIED AND AS REQUIRED TO INSTALL NEW PIPING AND EQUIPMENT.

S:

1 PROVIDE NEW SURFACE MOUNTED HALL CALL BUTTONS.

FLAG NOTES:

2 PROVIDE NEW SURFACE MOUNTED HALL LANTERNS.

3 PROVIDE NEW SUBMERSIBLE POWER UNIT AND SOLID STATE MICROPROCESSOR BASED CONTROLS.

4 HALL BUTTON FIXTURE AT EACH FLOOR SHALL BE PROVIDED WITH INTEGRAL POSITION INDICATORS.

5 NEW SHUTOFF VALVE.


6 PROVIDE NEW SHUTOFF VALVE AND RUPTURE VALVE.

7 CUT AND PATCH WALL AS REQUIRED TO INSTALL NEW HYDRAULIC LINE.

8 PROVIDE ISOLATION COUPLING AT POWER UNIT.

PROVIDE VIBRATION ISOLATION CONSISTING OF THE FOLLOWING: NEOPRENE PADS UNDER POWER UNIT AND PIPE STANDS WITH MINIMUM 1/4" DEFLECTION; NEOPRENE INSERTS AT ALL PIPE CLAMPS/SUPPORTS.

PROVIDE NEW IN-GROUND HYDRAULIC JACK, PIT CHANNELS, AND BUFFERS. INCLUDE REPLACEMENT OF SECONDARY CYLINDER CASING AS ADD ALTERNATE 1. INCLUDE REQUIRED HOURS IN BID.

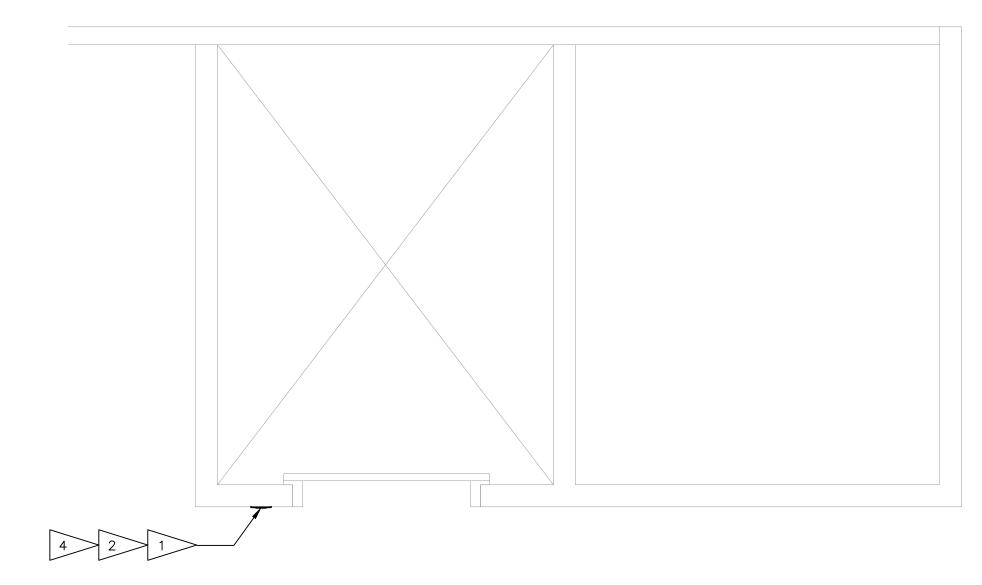



2 ENLARGED SECOND & THIRD FLOOR ELEVATOR PLAN

SCALE:1/2" = 1'-0"




S H K S A R C H I T E C T S

Seattle, WA 98103PH: 206.675.9151

www.shksarchitects.comTHE GREENBUSCH GROUP, INC

ACOUSTICAL, AUDIO / VIDEO & MECHANICAL ENGINEERING

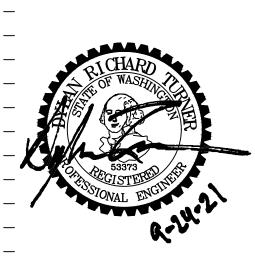

KCHAEASTRIDGEHOUSE ELEVATORMODERNIZATION

100% CD

120 W SUNSET WAY
— ISSAQUAH, WA 98027

______ Drawn by: ______ E0 _____ Checked: _____ RF _____ Date: ______ 05/21/2021 _____ Scale: _____ As indicated

- Revisions:
No. Date Remarks

ELEVATOR
LANDING AND
MACHINE ROOM
ELEVATOR
FLOOR PLANS

EV2.1

SHEET NOTES:

 PROVIDE CUTTING AND PATCHING AS SPECIFIED AND AS REQUIRED TO INSTALL NEW PIPING AND EQUIPMENT.

FLAG NOTES:

1 PROVIDE NEW POSITION INDICATORS INTEGRATED WITHIN HALL FIXTURES AT EACH LANDING

2 EXISTING JACK TO BE REMOVED AND REPLACED WITH NEW DOUBLE BOTTOM JACK.

3 PROVIDE SHUT-OFF VALVES AND SEISMIC SAFETY

4 SPRING BUFFERS AND CHANNEL, PROVIDE NEW

5 GUIDE RAILS EXISTING TO REMAIN. PROVIDE RAIL BACKING OR FISH PLATES AS REQUIRED TO MEET THE ELEVATOR SAFETY CODE. FIELD VERIFY AND PROVIDE QUANTITY REQUIRED.

6 RETAIN EXISTING PLATFORM, ENCLOSURE AND SUB-FLOOR.

7 FINISHES AS SPECIFIED.

8 > PROVIDE NEW HANDRAILS.

9 PROVIDE NEW HALL LANTERNS

10 > PROVIDE CAR EXHAUST FAN.

PROVIDE CAR OPERATING PANEL WITH TELEPHONE, INTERCOM, EMERGENCY LIGHT AND LED POSITION, DIRECTION INDICATORS, AND KEYSWITCH OVERRIDE.

12 PROVIDE CAR LED LIGHTING.

13 PROVIDE CAR TOP OPERATING STATION.

14 PROVIDE NEW TRAVELING CABLES.

15 > PROVIDE TERMINAL LIMIT SWITCHES.

16 > PROVIDE ADA JAMB PLATES.

17 PROVIDE HALL BUTTONS TO MEET ACCESSIBILITY REQUIREMENTS.

18 > PROVIDE NEW TOE GUARD.

19 FASCIA PLATES EXISTING TO REMAIN.

20 LANDING SILLS ARE EXISTING TO REMAIN.

21 > PROVIDE NEW CLOSED LOOP DOOR OPERATOR.

> PROVIDE MECHANICAL KEYED ACCESS AT THE INTERMEDIATE LANDING.

23 PROVIDE DOOR EDGE PROTECTION DEVICE.

PROVIDE FIRE SIGNAGE AT EACH LANDING PROHIBITING USE OF ELEVATOR, DURING FIRE. SIGNAGE MAY BE INCORPORTATED INTO HALL STATIONS.

25 PROVIDE NEW ROLLER GUIDES.

26 PROVIDE CAR TOP HATCH WITH ALARM.

27 PROVIDE NEW CAB DOORS.

28 PATCH ALL EXISTING AND CREATED HOLES IN THE HOISTWAY.

29 PROVIDE NEW INTERCOM AT FIRST FLOOR LOBBY.

30 PROVIDE NEW FIRE DEPARTMENT KEY BOX AT FIRST

PROVIDE NEW SLAB AS REQUIRED DURING JACK REPLACEMENT.

32 HOISTWAYS ENTRANCES REPAINTED (BY OTHERS).


33 PROVIDE DUST COVER.


34 PROVIDE NEW CODE COMPLIANT PIT LADDER.

35 ALL FRAMES TO BE RE-PAINTED.

PROVIDE HOISTWAY ACCESS KEYSWITCHES AT TERMINAL LANDINGS.

37 INCLUDE REPLACEMENT OF SECONDARY CYLINDER CASING AS ADD ALTERNATE 1. INCLUDE REQUIRED HOURS IN BID.

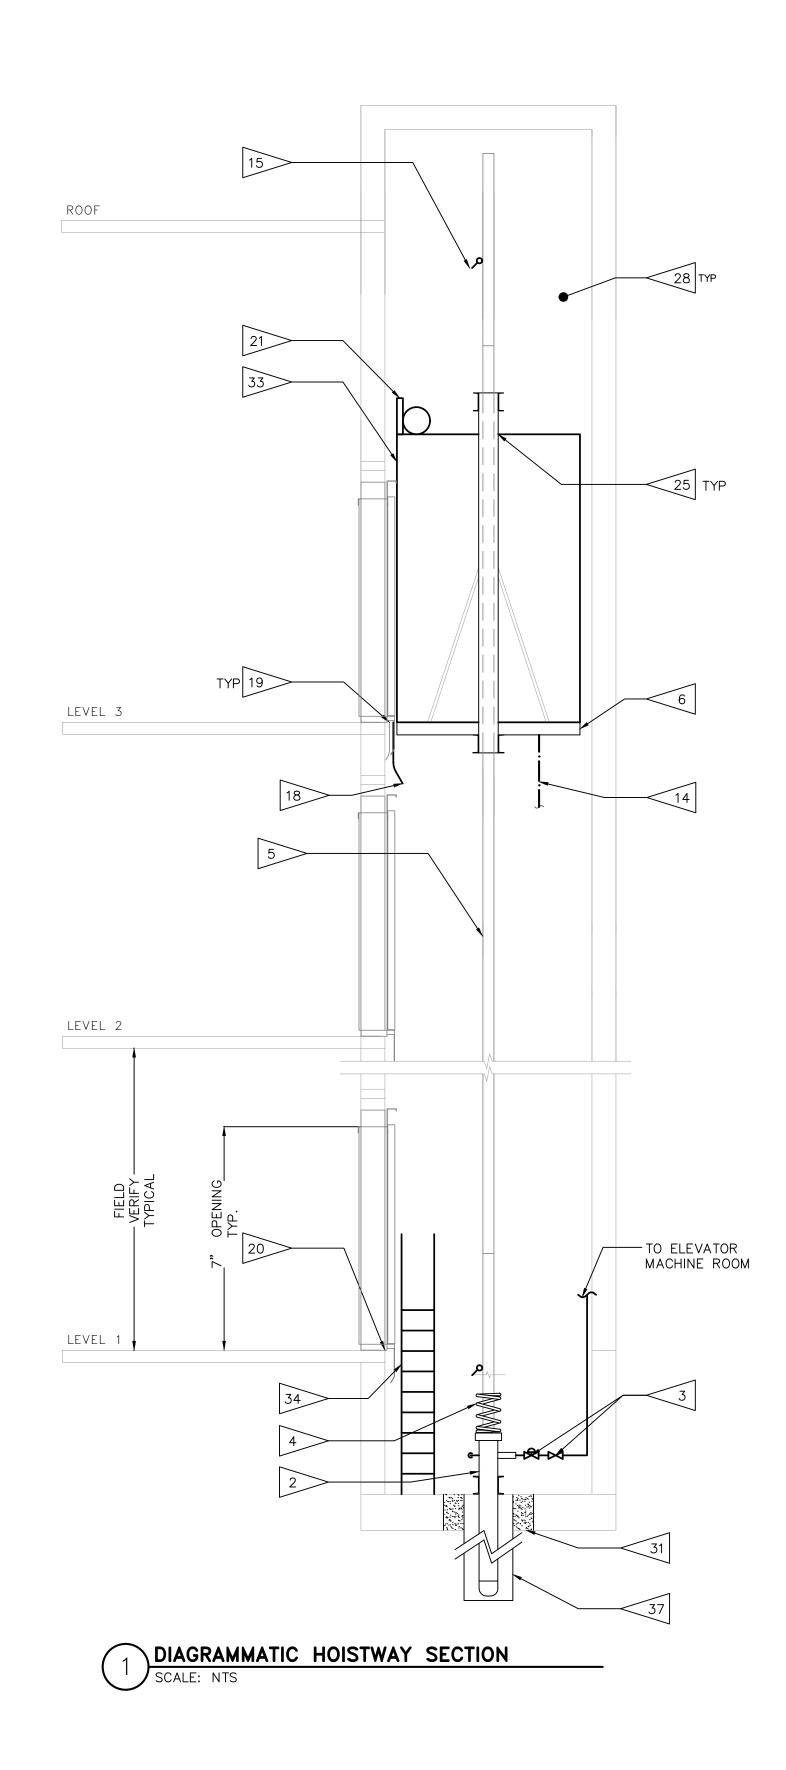


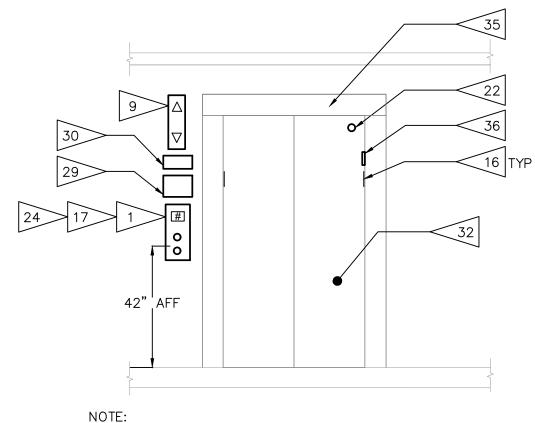

NOTE:
REFER TO ARCHITECTURAL FOR ADDITIONAL LOCATION INFORMATION

TYPICAL ELEVATOR LOBBY


SCALE: NTS

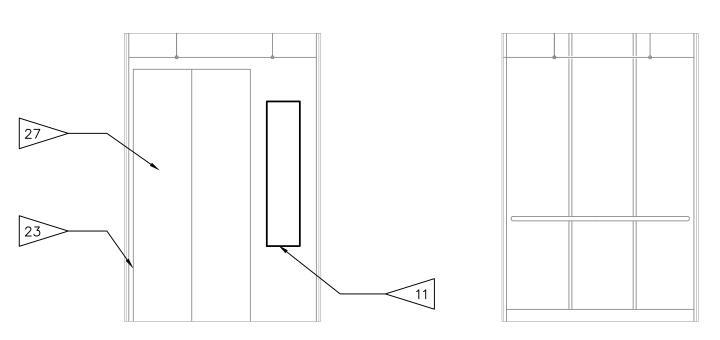


3 CAR FRONT ELEVATION
SCALE: NTS





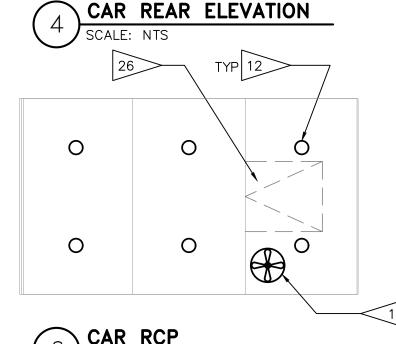



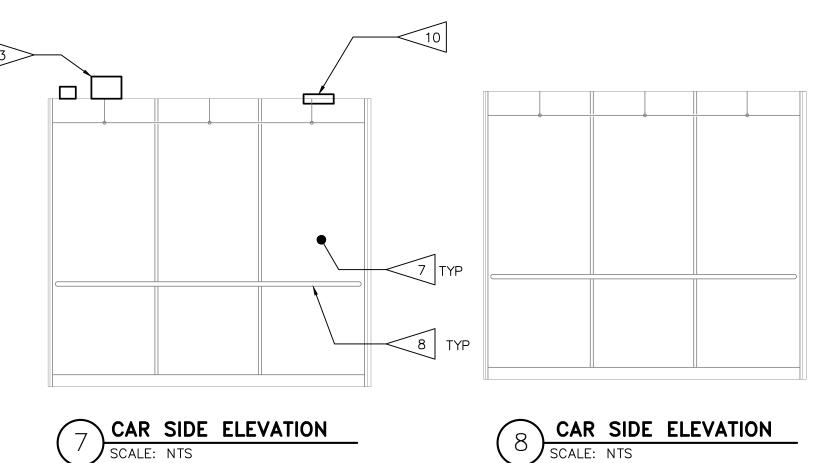

S H K S A R C H I T E C T S

— 1050 N. 38th St.
— Seattle, WA 98103
— рн: 206.675.9151
— www.shksarchitects.com

THE GREENBUSCH GROUP, INC

ACOUSTICAL, AUDIO / VIDEO & MECHANICAL ENGINEE
1900 WEST NICKERSON STREET SUITE 201 SEATTLE, WA 9

CHARD
WASHING
STONAL ENGINEER

KCHAEASTRIDGEHOUSE ELEVATORMODERNIZATION

100% CD
120 W SUNSET WAY


— ISSAQUAH, WA 98027

Drawn by: E0
Checked: RF
Date: 05/21/2021
Scale: As indicated

Revisions:No. Date Remarks

ELEVATOR DIAGRAMS

EV2.2

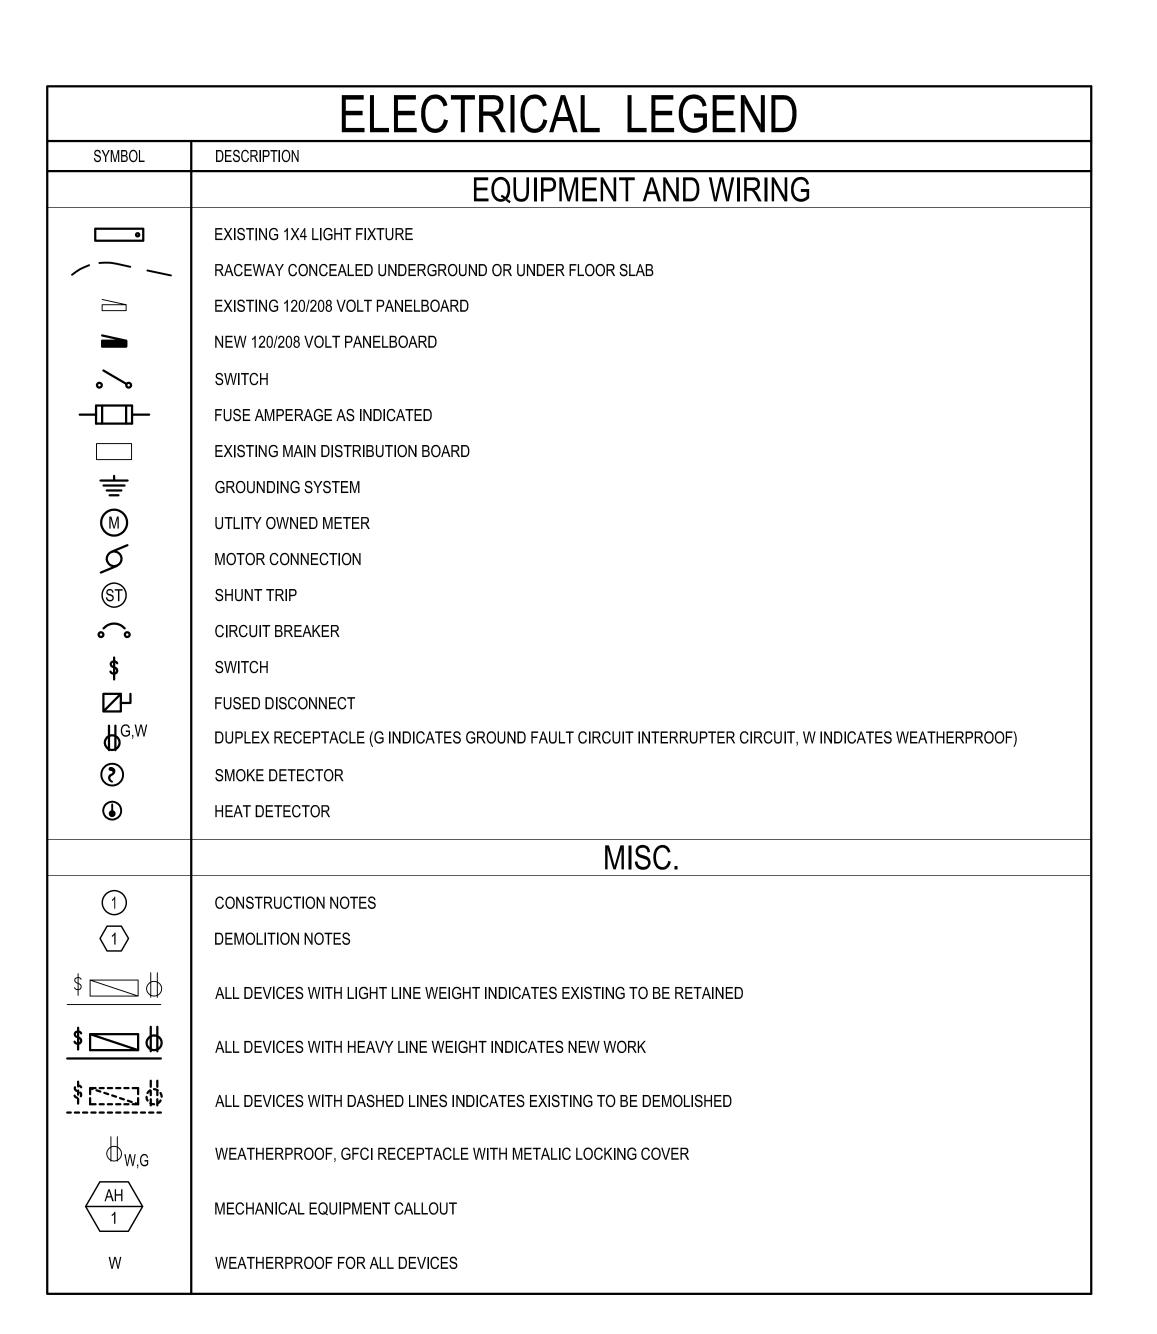

	MECHANICAL EQUIPMENT CONNECTION SCHEDULE (EXHAUST FANS, AIR HANDLING UNITS, ETC)													
			LOAD		CIR	CUIT		STARTER	FUSED DISC.					
EQUIP.	VOLT/PH	VA	MCA	HP	PANEL	BKR	CONDUIT/WIRE SIZE	(NOTE 1)	(NOTE 1)	REMARKS				
HP- 1 (O)	208/1	2704	13		ELEV	1,3	3/4" C., (3)#12 & (1) #12 CU GND	MFR	EC	PROVIDE 20A FUSES				
HP- 1 (I)	208/1	208	1				3/4" C., (3)#12 & (1) #12 CU GND			FED FROM OUTDOOR UNIT.				
NOTE: 1.	CONTRACT	OR LIS	TED SH	ALL FUI	RNISH AND	INSTALL T	HE LISTED DEVICE.							

	ES FOR LIGHTING FIXTURE SCHEDULE	_				
	100 0 2 102 102 103	LIGHTING FIXTURE	SCHEDULE			
SYMBOL	FIXTURE DESCRIPTION	MANUFACTURER/MODEL#	LUMENS	V	W	MOUNTING & REMARKS
PL1	4' PENDANT MOUNTED LED	EATON - FAIL-SAFE# HVL8-4-LD4-2STD-35-UNV-O-EDD1	7018	120V	1 69	PENDANT MOUNT. PROVIDE MOUNTING HARDWARE AS REQUIRED.
RL1	6" RECESS MOUNTED LED	COOPER - PORTFOLIO# LD6B15D010EMBOD EU6B10208030 6LBW1LIE	1345	120V	15.5	
SL1	4' SURFACE MOUNTED LED	EATON - FAIL-SAFE# HVL8-4-LD4-2STD-35-UNV-O-EDD1	7018	120V	69	SURFACE MOUNT. PROVIDE MOUNTING HARDWARE AS REQUIRED.

5410

120V


EATON - FAIL-SAFE#

4VRVT3-LD5-5-W-120V-L835-CD1-U

4' WALL MOUNTED LED

GENERAL NOTES (APPLY TO ALL DRAWINGS)

- 1. SEE EACH SHEET FOR ADDITIONAL GENERAL NOTES THAT ARE SPECIFIC TO AN AREA OR SHEET.
- 2. THE CONTRACTOR IS RESPONSIBLE TO VERIFY ALL CABLE ROUTING AND ALL WORK REQUIRED TO FACILITATE A COMPLETE AND FULLY FUNCTIONAL SYSTEM.
- 3. ALL CIRCUIT EXTENSIONS AND NEW RACEWAYS SHALL BE CONCEALED IN FINISHED AREAS. NOTIFY KCHA PROJECT MANAGER FOR APPROVAL, PRIOR TO INSTALLATION OF ANY SURFACE MOUNTED RACEWAY WHERE CONCEALMENT IS NOT POSSIBLE. ROUTE ALL SURFACE METAL RACEWAY AS INCONSPICUOUSLY AS POSSIBLE AND PAINT TO MATCH ADJACENT SURFACE.
- 4. PANEL DESIGNATIONS AND CIRCUIT NUMBERS ARE ONLY INDICATED ON THE DRAWINGS FOR REFERENCE BY THE ELECTRICAL CONTRACTOR. THE E.C. IS RESPONSIBLE TO PROVIDE ALL CONDUIT, WIRING, JUNCTION BOXES, AND MISCELLANEOUS ACCESSORIES TO ACCOMMODATE INSTALLATION AND CONNECTION OF ALL DEVICES INDICATED ON THE CONTRACT DOCUMENTS. ALL WIRING HOMERUNS SHALL BE IN HARD CONDUIT BACK TO THE DESIGNATED PANELBOARD. ALL JUNCTION BOXES SHALL BE LABELED IDENTIFYING THE PANELBOARD AND CIRCUIT CONTAINED WITHIN. THERE SHALL BE NO MORE THAN (3) CIRCUITS PER HOMERUN. MULTI-WIRE CIRCUITS ARE NOT ALLOWED. EACH CIRCUIT SHALL CONTAIN A DEDICATED NEUTRAL UNLESS SPECIFICALLY ALLOWED BY THE ENGINEER. ALL WIRING SHALL BE SIZED ACCORDING TO THE AMPACITY OF THE CIRCUIT BREAKER INDICATED ON THE PANEL SCHEDULE. ALL CONDUITS SHALL BE SIZED PER NEC CODE BASED ON THE CONDUCTOR SIZE, TYPE, QUANTITY AND MINIMUM FILL REQUIREMENTS. CIRCUITS OVER 120' FOR 120V SHALL BE UPSIZED ONE WIRE SIZE TO ACCOUNT FOR VOLTAGE DROP. E.C. IS RESPONSIBLE TO SHOW ALL JUNCTION BOX LOCATIONS, CONDUIT ROUTING, AND HOMERUNS ON A SET OF AS-BUILT DRAWINGS.
- 5. FEED THROUGH GFCI RECEPTACLES SHALL NOT BE USED.
- 6. ALL TYPICAL DEVICES SHALL BE MOUNTED AT CONSISTENT LOCATIONS AND HEIGHTS THROUGHOUT THIS PROJECT, UNLESS NOTED OTHERWISE.
- 7. SEE ALL DETAIL SHEETS AND RISER DIAGRAMS FOR ADDITIONAL WORK. ALL DETAILS AND RISERS ARE APPLICABLE TO THIS PROJECT WHETHER REFERENCED OR NOT.
- 8. GROUNDING SHALL CONFORM TO NEC 250.
- 9. COORDINATE WITH OWNER AND GENERAL CONTRACTOR FOR FURTHER REQUIREMENTS FOR THE ADVANCE NOTIFICATION TO THE BUILDING TENANTS BEFORE ANY SYSTEM SHUTDOWN. ALL SHUTDOWN AND CHANGE-OVER TIME SHALL BE KEPT TO A MINIMUM. ALL BUILDING SYSTEM SHUT DOWNS SHALL BE DISCUSSED AND COORDINATED BETWEEN THE GENERAL CONTRACTOR AND ALL SUBCONTRACTORS. THE CONTRACTOR SHALL SUBMIT A OUTAGE PROPOSAL TO OWNER FOR APPROVAL. NO BUILDING SYSTEM SHUTDOWNS WILL BE ALLOWED WITHOUT BEING SCHEDULED AND APPROVED BY KCHA.
- 10. PRIOR TO THE INSTALLATION OF CONDUIT, CONDUCTORS, OR ELECTRICAL EQUIPMENT RELATED TO THE ELEVATOR, COORDINATE ALL CONNECTION AND CIRCUITING REQUIREMENTS WITH ELEVATOR SUPPLIER.

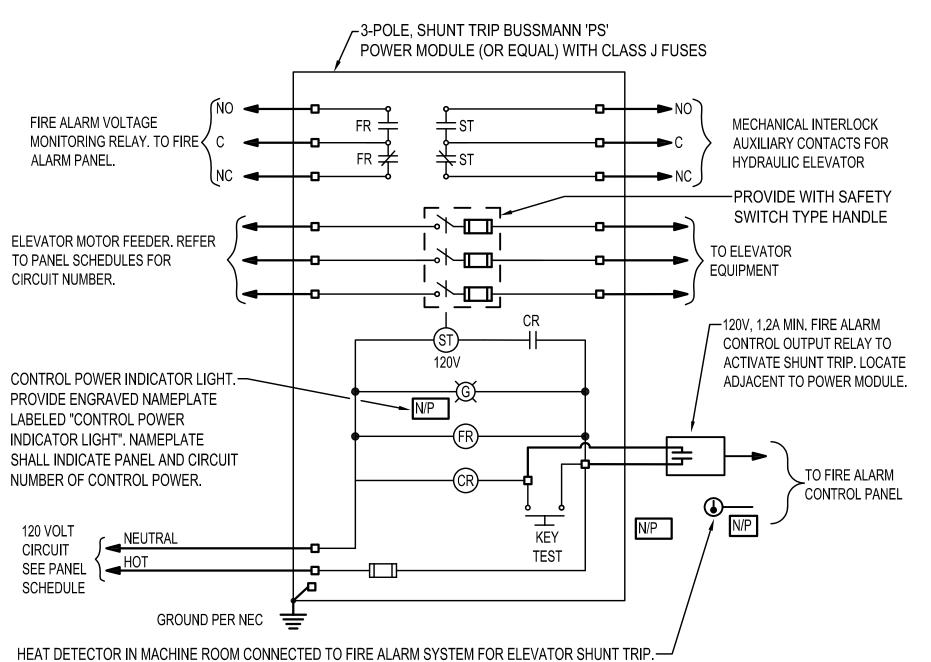

CU	COPPER
EC	ELECTRICAL CONTRACTOR
GND	GROUND
HP	HORSE POWER, HEAT PUMP
LTG	LIGHTING
RM	ROOM
KCMIL KVA	THOUSAND CIRCULAR MILS KILOVOLT-AMPERE
MDB MP	MAIN DISTRIBUTION BOARD METERING POINT
Ø P	PHASE PHASE, POLE
r	, ,

ABBREVIATION

AMPERE

CONDUIT

ALUMINUM

NO SPRINKLER IN TOP OF HOISTWAY. SPRINKLER IN BOTTOM OF HOISTWAY IS LESS THAN 2' ABOVE PIT FLOOR SHALL NOT ACTIVATE SHUNT TRIP. PROVIDE ENGRAVED NAMEPLATE: "ELEVATOR POWER SHUNT TRIP ON HEAT DETECTOR ACTIVATION". COORDINATE WITH SPRINKLER SYSTEM CONTRACTOR. COORDINATE TESTING WITH ELEVATOR AND SPRINKLER SYSTEM CONTRACTORS.

ELEVATOR SHUNT TRIP DIAGRAM

SCALE: DIAGRAMMATIC


SURFACE MOUNT. PROVIDE MOUNTING

HARDWARE AS REQUIRED.

SHKSARCHITECTS

— 1050 N. 38th St. — Seattle, WA 98103 — рн: 206.675.9151



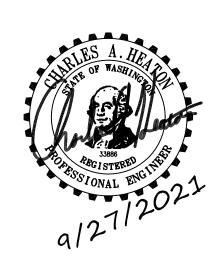

KCHA EASTRIDGE ELEVATOR MODERNIZATION

100% CD

120 W. SUNSET WAY
ISSAQUAH, WA 98027

Drawn by: JL

Checked: BM

Date: 5/21/2021

Scale: As indicated

Revisions:
No. Date Remarks

ELECTRICAL LEGEND

FO. 1

-SERVICE TRANSFORMER

4 PANEL H3 SECTION 1

PANEL 'H3' SECTION 2

(E) JANITOR

(E) STAIR #1

(E) UNIT

PANEL 'EMG'

PANEL 'H2'

18"X18" PULLBOX

CONSTRUCTION NOTES

- 1) ROUTE CONDUIT UP WALL CAVITY FROM HP-1 (O) AND LB INTO ACCESSIBLE CEILING SPACE. SEAL AND PAINT PENETRATIONS TO MATCH ADJACENT SURFACE.
- ROUTE IN ACCESSIBLE CEILING SPACE. PROVIDE ALL CORE DRILLING AS REQUIRED. AT CONTRACTORS OPTION AND WITH WRITTEN APPROVAL FROM KCHA CONTRACTOR MAY REQUEST TO SURFACE MOUNT RACEWAY IN NON-FINISHED SPACES IN LIEU OF ROUTING IN ACCESSIBLE CEILING SPACE. IF SURFACE RACEWAY IS USED PAINT TO MATCH ADJACENT SURFACE.
- (3) PROVIDE CORE DRILLING IN ACCESSIBLE CEILING SPACE.
- DEMOLISH EXISTING CCB PANEL. PROVIDE AND INSTALL NEW H3 SECTION 1 PANEL AS INDICATED ON SHEET E6.2. RE-TERMINATE BRANCH CIRCUIT TO NEW PANEL. REPLACE CONDUCTORS OR PROVIDE SPLICE BOX AS NEEDED.
- 5 SURFACE MOUNT CONDUIT ON EXTERIOR WALL OF BUILDING. CORE DRILL AND PROVIDE LB INTO ACCESSIBLE CEILING SPACE AS NECESSARY.
- 6 ROUTE CONDUIT TO FOLLOW PATH OF REFRIGERANT LINES TO INDOOR UNIT. COORDINATE WITH INSTALLER PRIOR TO ROUGH-IN.
- 7 INTERCEPT, SPLICE AND EXTEND CIRUCIT FROM NEAREST HOUSE RECEPTCLE. CUT, PATCH, REPAIR AND PAINT AS REQUIRED TO MATCH ADJACENT SURFACE.
- PROVIDE GFCI, WEATHERPROOF, LOCKABLE-WHILE-IN-USE RECEPTACLE AT +24" AFG. PROVIDE 3/4" C., WITH (2) #12 CU AND (1) #12 CU GROUND.
- EXISTING FEEDER FOR EXISTING MOTOR. REUSE FOR NEW ELEV PANEL IN ELEVEVATOR EQUIPMENT ROOM. SEE SHEET E2.0 FOR MORE INFORMATION.
- PROVIDE LB INTO ACCESSIBLE CEILING SPACE. CORE DRILL AS REQUIRED.

(E) UNIT

(2) (3)

(E) UNIT


ROUTE ELEVATOR FEEDER BELOW CONTACTOR AND PANEL H3 SECITON 2
AND UP WALL NEAR DOOR. SURFACE MOUNT IN METER ROOM AND PROVIDE MOUNTING EQUIPMENT AS NEEDED.

(E) UNIT

(E) UNIT

AND CHARGER

(E) UNIT

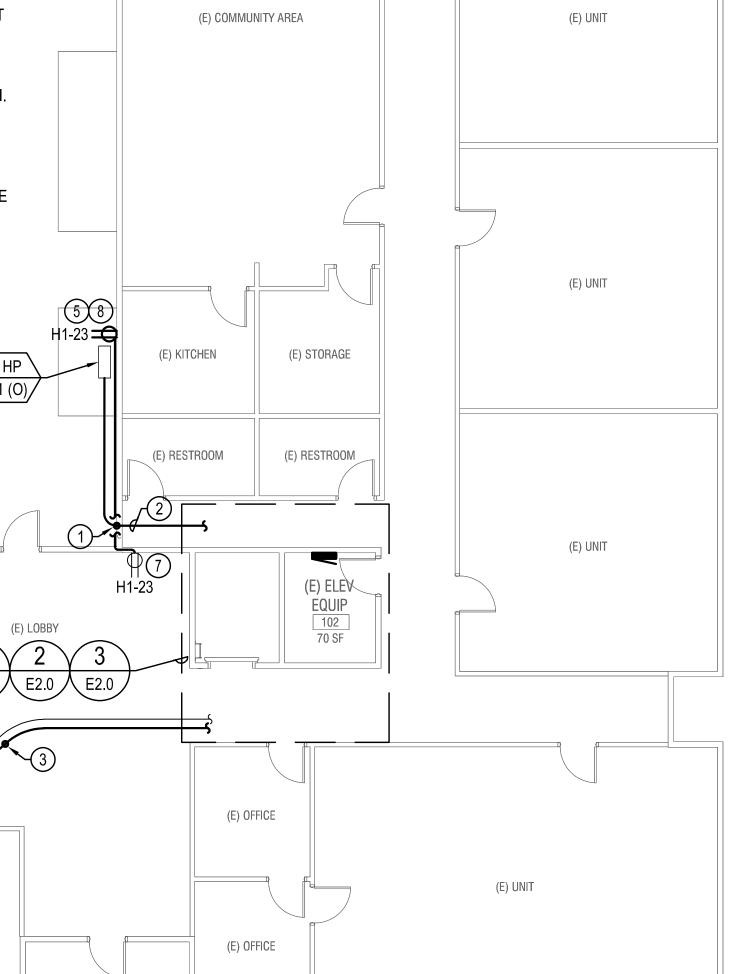

(E) STAIR #2

FIRST FLOOR ELECTRICAL PLAN

0 1' 2' 4' 8' 12'

1050 N. 38th St.
Seattle, WA 98103
PH: 206.675.9151

SHKSARCHITECTS

6021 12th Street East, Suite 200
Fife, Washington 98424
T: 253.922.0446
F: 253.922.0896

www.shksarchitects.com

AND ASHING OF WASHING OF WASHING

KCHA EASTRIDGE ELEVATOR MODERNIZATION

100% CD
120 W. SUNSET WAY
ISSAQUAH, WA 98027

Drawn by: JL
Checked: BM
Date: 5/21/2021
Scale: As indicated

— Revisions:
No. Date Re

ELECTRICAL SITE PLAN

E1.0


ELEVATOR (12) 30 HP 208V, 3Ø-

8 HP 1 (I)


CONTROLS 12

FELEA

1 ENLARGED ELECTRICAL PLANS - FIRST FLOOR

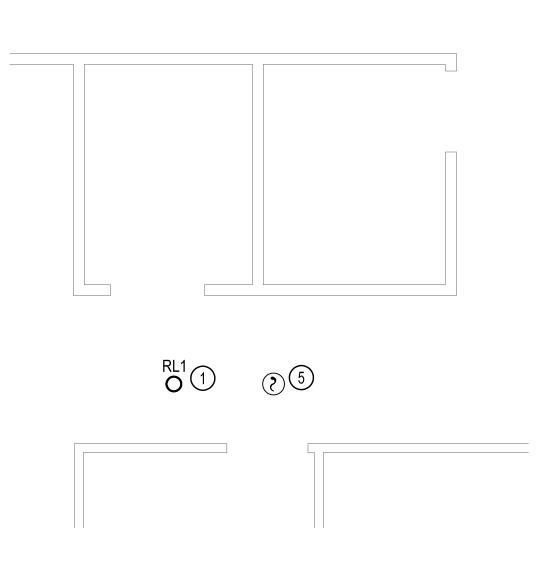

2 ENLARGED ELECTRICAL PLANS - SECOND FLOOR

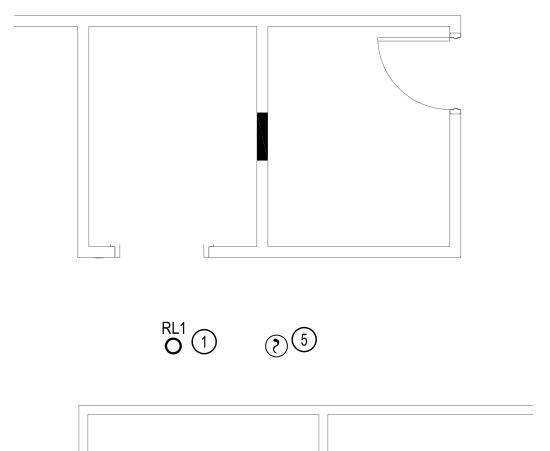

3 ENLARGED ELECTRICAL PLANS - THIRD FLOOR

GENERAL NOTES

- PROVIDE ALL CORE DRILLING THROUGH EXISTING WALLS FOR NEW CONDUIT AS REQUIRED. COMPLETELY SEAL ALL PENETRATIONS TO MATCH RATING OF WALL. FINISH AND PAINT AROUND PENETRATION TO MATCH ADJACENT SURFACE.
- SEE ELECTRICAL ONE-LINE DIAGRAMS ON E6.0 FOR MORE INFORMATION.
- 3. SEE GENERAL NOTES ON E0.1.

Seattle, WA 98103 рн: 206.675.9151


1050 N. 38th St.



CONSTRUCTION NOTES

- INTERCEPT, SPLICE AND EXTEND BRANCH CIRCUIT FROM NEAREST EXISTING LIGHT
- INTERCEPT, SPLICE AND EXTEND FEEDER FROM EXISTING ELEVATOR MOTOR DISCONNECT TO NEW ELEVATOR PANEL.
- 3 JUNCTION BOX AND RECEPTACLE TO BE REPLACED WITH GFCI RECEPTACLE IN PIT.
- 4 REPLACE EXISTING LIGHT FIXTURE WITH SL1. REMOVE FROM EXISTING CIRUCIT AND PROVIDE CONNECTION TO NEW ELEV PANEL.
- 5 EXISTING SMOKE DETECTOR.
- MOUNT HANDLE OF DISCONNECT WITHIN 24 INCHES OF STRIKE SIDE OF DOOR. PROVIDE SHUNT TRIP DEVICE FEEDING THE ELEVATOR MOTOR. SEE ONE LINE DIAGRAM FOR MORE INFORMATION. SEE E0.1 FOR SHUNT TRIP DIAGRAM.
- SEE SHEET E1.0 FOR CONTINUATION.
- 8 ROUTE CONDUIT TO FOLOW PATH OF REGRIGERANT LINES TO CONDENSING UNIT HP-1 (O). COORDINATE WITH INSTALLER PRIOR TO ROUGH-IN.
- PROVIDE NEW COMPATIBLE HEAT DETECTOR IN ELEVATOR PIT TO INITIATE ELEVATOR FIRE RECALL AND TIE INTO EXISTING FIRE ALARM SYSTEM.
- CAB LIGHTS AND POWER TO CIRCUIT ELEV-2. PROVIDE MANUAL DISCONNECT AS REQUIRED BY ELEVATOR INSTALLER. PROVIDE PHENOLIC LABEL "ELEVATOR CAB".
- 11) REPLACE EXISTING RECEPTACLE IN ELEVATOR EQUIPMENT ROOM WITH A NEW GFCI RECEPTACLE AND ROUTE TO NEW PANEL ELEV.
- REMOVE AND REPLACE EXISTING ELEVATOR MOTOR, DISCONNECT, CONTROL PANEL AND ASSOCIATED APPURTENANCES NOT TO BE REUSED. SEE ONE LINE DIAGRAM ON E6.0 FOR MORE INFORMATION.
- (13) ROUTE IN ACCESSIBLE CEILING SPACE. PROVIDE ALL CORE DRILLING AS REQUIRED. AT CONTRACTORS OPTION AND WITH WRITTEN APPROVAL FROM KCHA CONTRACTOR MAY REQUEST TO SURFACE MOUNT RACEWAY IN NON-FINISHED SPACES IN LIEU OF ROUTING IN ACCESSIBLE CEILING SPACE. IF SURFACE RACEWAY IS USED PAINT TO MATCH ADJACENT SURFACE.
- SURFACE MOUNT RACEWAY FROM DISCONNECT TO ELEVATOR MOTOR.



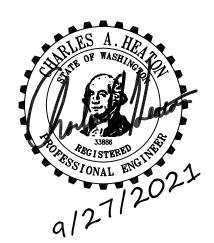

KCHA EASTRIDGE ELEVATOR MODERNIZATION

100% CD 120 W. SUNSET WAY

Drawn by: Checked: 5/21/2021 Date: Scale: As indicated

ISSAQUAH, WA 98027

ENLARGED ELECTRICAL PLANS

E2.0

1050 N. 38th St.

Seattle, WA 98103

www.shksarchitects.com

6021 12th Street East, Suite 200

Fife, Washington 98424

T: 253.922.0446

F: 253.922.0896

рн: 206.675.9151


KCHA EASTRIDGE ELEVATOR MODERNIZATION 30 DAY PEAK DEMAND CALCULATION WORKSHEET 2500A MAIN SWITCHBOARD at MAIN SWITCHBOARD (MP#1) NEC 220.87 AND WAC 296-46B-900(3)(j) 30-day demand study from : 2021-03-09 to 2021-04-14 Phase to Phase Voltage (Volts): Phases (1=Single Phase, 3=Three Phase): 30 Day Peak Demand On : 2021-03-16 239.46 Amps Apparent Peak Demand **86.27** KVA NEC 220.87(2) adjustment factor 1.25 Adjusted Peak Demand **107.84** KVA 1.00 Seasonal adjustment factor **107.84** KVA Seasonal adjustment peak demand 1.00 Occupancy adjustment factor **107.84** KVA Occupancy adjustment peak demand 1.00 Other adjustement factor(s) **107.84** KVA Measured Peak Demand with Adjustments New Calculated Demand Load Added **49.14** KVA Elevator Metered Demand Based CALCULATED DEMAND LOAD: 156.98 KVA **CALCULATED DEMAND CURRENT:** 436 AMPS Note: See WAC 296-46B-900 (3)(j) for additional metering requirements

KCHA EASTRIDGE ELEVA 30 DAY PEAK DEMAND CALO 175A PANEL EMG at P	CULATION W	ORKS		,
NEC 220.87 AND WAC	296-46B-900(3)(j)		
30-day demand study from Phase to Phase Voltage (Volts Phases (1=Single Phase, 3=Three Phase): 208	to	2021-04-0	9
30 Day Peak Demand On	: 2021-04-09	=	19.3	3 Amps
Apparent Peak Demand		=	6.96	KVA
NEC 220.87(2) adjustment factor		Χ	1.25	_
Adjusted Peak Demand		=	8.70	_ KVA
Seasonal adjustment factor		Χ	1.00	_
Seasonal adjustment peak demand		=	8.70	_ KVA
Occupancy adjustment factor		Χ	1.00	_
Occupancy adjustment peak demand		=	8.70	_ KVA
Other adjustement factor(s)		Х	1.00	_
Measured Peak Demand with Adjustments		=	8.70	KVA
New Calculated Demand Load Added	Panel ELEV	+	5.01	_KVA
Metered Demand Based				
CALCULATED DEMAND LOAD:			13.72	_KVA
CALCULATED DEMAND CURRENT :			38	_AMPS
Note: See WAC 296-46B-900 (3)(j) for	additional meteri	ng requ	irements	

KCHA EASTRIDGE ELEVATOR MODE 30 DAY PEAK DEMAND CALCULATION V 600A PANEL H3 at MAIN SWITCHBOA	NORKS	HEET	
NEC 220.87 AND WAC 296-46B-900(3	3)(j)		
30-day demand study from : 2021-03-09 Phase to Phase Voltage (Volts) : 208 Phases (1=Single Phase, 3=Three Phase) : 3	_	2021-04-09	
30 Day Peak Demand On : 2021-03-31	_ =	21.98	Amps
Apparent Peak Demand NEC 220.87(2) adjustment factor	= X	7.92 1.25	KVA
Adjusted Peak Demand	=		KVA
Seasonal adjustment factor	Х	1.00	
Seasonal adjustment peak demand	=		KVA
Occupancy adjustment factor	Χ	1.00	
Occupancy adjustment peak demand	=	9.90	KVA
Other adjustement factor(s)	Χ	1.00	
Measured Peak Demand with Adjustments	=	9.90	KVA
New Calculated Demand Load Added Elevator	+	49.14	KVA
Metered Demand Based			
CALCULATED DEMAND LOAD:		59.04	KVA
CALCULATED DEMAND CURRENT:		164	AMPS
Note: See WAC 296-46B-900 (3)(j) for additional meter	ering requ	irements	

CONSTRUCTION NOTES

- 1) INTERCEPT, SPLICE AND EXTEND EXISTING FEEDER FOR EXISTING ELEVATOR MOTOR TO NEW ELEVATOR PANEL IN THE MACHINE ROOM AS REQUIRED.
- 2 METERING POINT FOR 30 DAY METERING. SEE CALCULATIONS THIS SHEET FOR MORE INFORMATION.
- PROVIDE BUSSMAN ELEVATOR SHUNT TRIP DEVICE IN ELEVATOR MACHINE ROOM, SEE DETAIL ON E0.1 FOR MORE INFORMATION, PROVIDE FUSES SIZED PER ELEVATOR MANUFACTURERS REQUIREMENTS.
- REPLACE EXISTING CONDUCTORS IN CONDUIT.
- 5 PROVIDE GUTTER AS REQUIRED TO INTERCEPT, SPLICE AND EXTEND EXISTING BRANCH CIRCUITS TO NEW PANEL.
- REMOVE CONDUCTORS AND CUT CONDUIT TO INSTALL NEW PANEL AS CLOSE TO FLOOR AS POSSIBLE. REPLACE AND TERMINATE NEW FEEDER CONDUCTORS AS INDICATED.

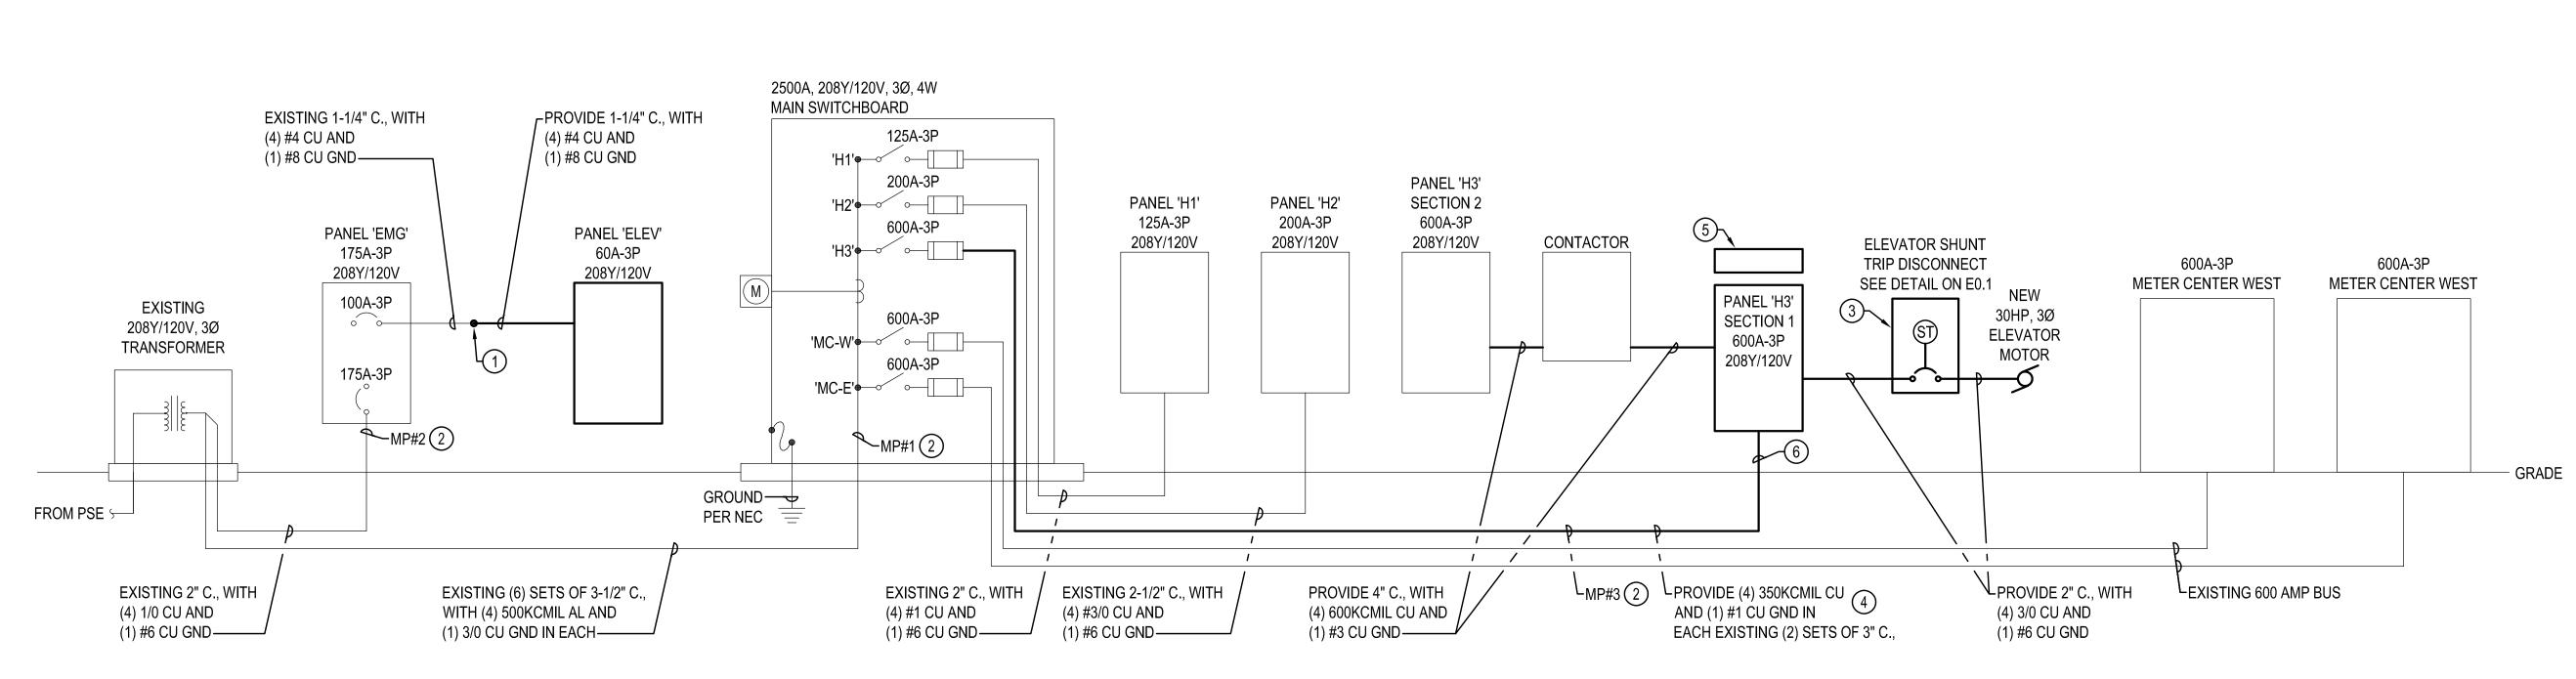

TELECTRICAL ONE-LINE DIAGRAM

5/21/2021 Date: Scale: As indicated

KCHA

EASTRIDGE

ELEVATOR

100% CD

MODERNIZATION

120 W. SUNSET WAY

ISSAQUAH, WA 98027

Drawn by:

Checked:

ELECTRICAL ONE-LINE DIAGRAM

E6.0

	PANEL:	EMG (EXISTING)	3	PH	4	WIRE		VOLTAGE:	208Y/1	20V		175A	MCB	
	LOC:			N	MOUNT:	SURFACE		FEED:	BOTT	MC				
	TYPE:	NEMA 1			POLES:	36		SF MAINS:				10,000AIC	MINIMUM]
LOAD			CIR.	CIR	BRKR				CIR.	BRKR	1			LOAD
TYPE	LOAD	CIRCUIT DIRECTORY	NO.	Р	AMP	Α	В	С	P	AMP	NO.	CIRCUIT DIRECTORY	LOAD	TYPE
		ELEVATOR LIGHTS	1	1	20				3		2			
		STAIRWAY LIGHTING	3	1	20						4	ELEVATOR MOTOR		
		ELEV. CONV. OUTLET	5	1	20					100	6			
		TELEPHONE OUTLET	7	1	20				1		8	CONTACTOR		
		EMG. CALL SYS.	9	1	20				1	20	10	ELECTRICAL ROOM OUTLET		
		INTERCOM SYS.	11	1	20				1	20	12	DOOR OPENER		
		CART ROOM OUTLET	13	1	20				1	20	14	EXISTING LOAD		
		DOOR OPENER SIDE WEST	15	1	20				1	20	16	EXISTING LOAD		
		SMOKE DETECTORS	17	1	20				1	20	18	SMOKE DETECTORS		
		2ND FLOOR SMOKE DETECTORS	19	1	20				1	20	20	1ST FLOOR SMOKE DETECTORS		
		2ND FLOOR SMOKE DETECTORS N.	21	1	20				1	20	22	1ST FLOOR SMOKE DETECTORS		
		SPARE	23	1	20				1	20	24	FACP		
		SPACE	25								26	SPACE		
		SPACE	27								28	SPACE		
		SPACE	29								30	SPACE		
		SPACE	31								32	SPACE		
		SPACE	33								34	SPACE		
		SPACE	35								36	SPACE		
		TOTAL		THI	S PANEL->							TOTAL		
									1					
		LIGHTING(125	%)=0.00									TOTAL CONNECTED LOAD (VA):		
		RECEPTS<=10000(100°	%)=0.00			LARGEST MOTO	R(125%) = 0.0)O I	KITCHEN L	OADS(65%) = 0.00	TOTAL CONNECTED CURRENT (A):		
		RECEPTS>10000(50°	•			OTHER MOTOR	. ,			ICES(100%	•			
											•			
	NOTES:	· · · · · · · · · · · · · · · · · · ·										I OTAL DEWIAND CURRENT (A)		
	NOTES:	•	%) = 0.00 AL = 0.00 %) = 0.00			OTHER MOTOR MOTO WATER HEATER	S(100%) = 0.0 R TOTAL = 0.0 S(100%) = 0.0	00 00 00	APPLIAN DEDICA	ICES(100% TED(100% MISC(100%) = 0.00) = 0.00) = 0.00	TOTAL DEMAND LOAD (VA):		

	PANEL:	ELEV (NEW)	<u>3</u>	PH	4	WIRE	•	VOLTAGE:	208Y/1	20V		60A	MCB	
	LOC:			N	OUNT:	SURFACE		FEED:	BOTTO	MC				
	TYPE:	NEMA 1			POLES:	12		SF MAINS:	NO			10,000AIC	MINIMUM	
LOAD			CIR.	CIR.	BRKR				CIR.	BRKR	CIR.			LOA
TYPE	LOAD	CIRCUIT DIRECTORY	NO.	Р	AMP	Α	В	C	Р	AMP	NO.	CIRCUIT DIRECTORY	LOAD	TYF
MO	1456	HP-1 INDOOR AND OUTDOOR UNIT	1	2		1956			1	20	2	CAB LIGHTS (NOTE 1)	500	L
МО	1456		3		20		1525		1	20	4	ELEV EQUIP ROOM LIGHTS	69	L
R	180	ELEV EQUIP ROOM RECEPT	5	1	20			303	1	20	6	PIT LIGHTS	123	L
R	180	PIT RECEPTACLE	7	1	20	380			1	20	8	ELEV. SHUNT TRIP CONTROLS	200	D
		SPACE	9	1	20						10	SPACE		
		SPACE	11	1	20						12	SPACE		
	3272	TOTAL		THIS	S PANEL->	2336	1525	303				TOTAL	892	
		LIGHTING(125%)	= 865.00			2336	1525	303				TOTAL CONNECTED LOAD (VA):	4,164.00	
		RECEPTS<=10000(100%):	= 360.00		LAR	RGEST MOTOR(1	25%) = 3380.00	ŀ	KITCHEN L	OADS(65%) = 0.00	TOTAL CONNECTED CURRENT (A):	11.56	
		RECEPTS>10000(50%	5) = 0.00		0	THER MOTORS	(100%) = 208.00		APPLIAN	CES(100%) = 0.00			
		RECEPTS TOTAL:					OTAL = 3588.00		DEDICATE	ED(100%) =	200.00		•	
		ELECTRIC HEAT(100%	5) = 0.00			WATER HEATER	RS(100%) = 0.00		N	/IISC(100%) = 0.00	TOTAL DEMAND CURRENT (A)	13.91	

D=DEDICATED, X=MISC, SF=SUB FEED

SH	K S	A R	СН	ITE	CTS
	_				

1050 N. 38th St. Seattle, WA 98103 рн: 206.675.9151

www.shksarchitects.com

6021 12th Street East, Suite 200 Fife, Washington 98424 T: 253.922.0446 F: 253.922.0896

	PANEL:	EMG (REVISED)	<u>3</u>	PH		WIRE		VOLTAGE:		-		175A	MCB	
	LOC:					SURFACE			: BOTTO	OM				
	TYPE:	NEMA 1			POLES:	36		SF MAINS:				10,000AIC	MINIMUM	
LOAD			CIR.	CIR	BRKR				CIR.	BRKR	CIR.			LOAD
TYPE	LOAD	CIRCUIT DIRECTORY	NO.	Р	AMP	Α	В	С	P	AMP	NO.	CIRCUIT DIRECTORY	LOAD	TYPE
		SPARE	1	1	20	2336			3		2		2336	SF
		STAIRWAY LIGHTING	3	1	20		1525				4	PANEL ELEV	1525	SF
		SPARE	5	1	20			303		60	6		303	SF
		TELEPHONE OUTLET	7	1	20						8	SPACE		
		EMG. CALL SYS.	9	1	20				1	20	10	SPARE		
		INTERCOM SYS.	11	1	20				1	20	12	DOOR OPENER		
		CART ROOM OUTLET	13	1	20				1	20	14	EXISTING LOAD		
		DOOR OPENER SIDE WEST	15	1	20				1	20	16	EXISTING LOAD		
		SMOKE DETECTORS	17	1	20				1	20	18	SMOKE DETECTORS		
		2ND FLOOR SMOKE DETECTORS	19	1	20				1	20	20	1ST FLOOR SMOKE DETECTORS		
		2ND FLOOR SMOKE DETECTORS N.	21	1	20				1	20	22	1ST FLOOR SMOKE DETECTORS		
		SPARE	23	1	20				1	20	24	FACP		
		SPACE	25								26	SPACE		
		SPACE	27								28	SPACE		
		SPACE	29								30	SPACE		
		SPACE	31								32	SPACE		
		SPACE	33								34	SPACE		
		SPACE	35								36	SPACE		
		TOTAL		THI	S PANEL->	2336	1525	303			•	TOTAL	4164	
		•												
		LIGHTING(125%)	= 865.00			2336	1525	303				TOTAL CONNECTED LOAD (VA):	4,164.00	
		RECEPTS<=10000(100%)	= 360.00		LAR	GEST MOTOR(12	25%) = 3380.0	0 1	KITCHEN L	OADS(65%) = 0.00	TOTAL CONNECTED CURRENT (A):	11.56	
		RECEPTS>10000(50%	•		0.	THER MOTORS(1	•			CES(100%	•			
		RECEPTS TOTAL			,		OTAL = 3588.0				(100%) = 200.00 TOTAL DEMAND LOAD (VA): 5,01			2
	NOTES:	ELECTRIC HEAT(1009 L=LIGHTING, R=RECEPTACLES, H=ELECTRIC HEAT, ML:		T MOTOF		WATER HEATERS	• •			IISC(100%		TOTAL DEMAND CURRENT (A)	13.91	\subseteq
	HOTES.	D=DEDICATED, X=MISC, SF=SUB FEED	2, 11 (020	,,,,,,,,	.,			2.13, 11 111 01121	20/120, /		 0,			

CONSTRUCTION NOTES

- 1 REPLACE EXISTING 100A-3P CIRCUIT BREAKER WITH A 60A-3P CIRCUIT BREAKER FOR NEW PANEL ELEV.
- 2 ADDED LOAD ONLY. SEE E6.0 FOR LOAD CALCULATION.

KCHA
EASTRIDGE
ELEVATOR
MODERNIZATION

100% CD

120 W. SUNSET WAY ISSAQUAH, WA 98027

Drawn by:

Checked:

Date:

Scale:

Revisions:

PANEL SCHEDULES

E6.1

PANEL:	H3 SECTION 1 (EXISTING)			4	WIRE		VOLTAGE:	208Y/1	20V		600A N	/ILO	
.OC:		MOUNT: SURFACE					FEED:	BOTTO	MC				
YPE:	NEMA 1		F	POLES:	24	SF MAINS:			: NO		10,000AIC N	/INIMUM	
		CIR.	CIR.	BRKR				CIR.	BRKR	CIR.			LOAD
LOAD	CIRCUIT DIRECTORY	NO.	Р	AMP	Α	В	С	Р	AMP	NO.	CIRCUIT DIRECTORY	LOAD	TYPE
		1	3							2			
	H3 SECTION 2	3								4	H3 SECTION 2		
		5								6			
		7								8			
	H3 SECTION 2	9								10	H3 SECTION 2		
		11		400						12			
	SPACE	13			3333			3		14	(19)	3333	Н
	SPACE	15				3333				16	HEATER SO. COMMUNITY RM.	3333	Н
	SPACE	17					3333		40	18		3333	Н
	SPACE	19			3333			3		20	(21)	3333	Н
1500	CABINET HEATER FAN, COM. RM (7)	21	1	20		4833				22	HEATER NO. COMMUNITY RM.	3333	Н
1500	EXHAUST FAN MOTORS, COM. RM (11)	23	1	20			4833		40	24		3333	Н
3000	TOTAL		THIS	PANEL->	6667	8167	8167				TOTAL	20000	
SLAVE PANEL->	H3 SECTION 2 (EXISTING)				28167	27417	26667				_		
·	LIGHTING(125%) = 0.00			34833	35583	34833				TOTAL CONNECTED LOAD (VA): 1	05,250.00	
	RECEPTS<=10000(100%		LAR	GEST MOTOR(1	25%) = 1875.00		KITCHEN L	OADS(65%) = 0.00	TOTAL CONNECTED CURRENT (A): 2	92.14		
RECEPTS>10000(50%) = 0.00					•	,							
RECEPTS TOTAL = 0.00									,	,	•		
· · ·					, ,						I OTAL DEMAND CURRENT (A) 2	93.19	Щ
		LARGES	I MOTOR,	MO=OTHE	R MOTORS, WH	=WATER HEATE	ERS, K=KITCHEI	N LOADS, A	N=APPLIAN	CES,			
	1500 1500 1500 3000 SLAVE PANEL->	NEMA 1	NEMA 1 CIR. NO.	YPE: NEMA 1 F LOAD CIRCUIT DIRECTORY CIR. NO. P 1 3 1 3 H3 SECTION 2 5 7 H3 SECTION 2 9 11 SPACE 13 SPACE SPACE 15 SPACE SPACE 17 SPACE 1500 CABINET HEATER FAN, COM. RM (7) 21 1 1500 EXHAUST FAN MOTORS, COM. RM (11) 23 1 3000 TOTAL THIS SLAVE PANEL-> H3 SECTION 2 (EXISTING) LIGHTING(125%) = 0.00 RECEPTS<10000(100%) = 0.00 RECEPTS TOTAL = 0.00 RECEPTS TOTAL = 0.00 ELECTRIC HEAT(100%) = 100000.00 NOTES: L=LIGHTING, R=RECEPTACLES, H=ELECTRIC HEAT, ML=LARGEST MOTOR	YPE: NEMA 1	NEMA 1	NEMA 1	NEMA 1	NEMA 1	YPE: NEMA 1	YPE: NEMA 1 POLES: 24 SF MAINS: NO LOAD CIRCUIT DIRECTORY CIR. DIAM BRKR DIAM CIR. DIAM AI 4	NEMA 1	No. Poles 24 SFMAINS No. No.

	PANEL: LOC:	H3 SECTION 2 (EXISTING) NEMA 1		PH N		WIRE SURFACE			208Y/120V BOTTOM NO			400A		
	TYPE:				POLES:	36		SF MAINS:				10,000AIC		
LOAD			CIR.	CIR.	BRKR				CIR	. BRKR	CIR.			LOAD
TYPE	LOAD	CIRCUIT DIRECTORY	NO.	Р	AMP	Α	В	С	Р	AMP	NO.	CIRCUIT DIRECTORY	LOAD	TYPE
ML	750	CABINET HEATER MOTORS (1)	1	1	15	1500			1	15	2	CABINET HEATER MOTORS (2)	750	ML
ML	750	CABINET HEATER MOTORS (3)	3	1	15		750		1	15	4	SPARE (4)		
		SPARE (5)	5	1	15				1	15	6	SPARE (6)		
		SPARE (7)	7	1	15				3		8			
		SPARE (9)	9	1	15						10	SPARE		
		SPARE (11)	11	1	15				1	50	12			
Н	3333	(13)	13	3		3333			3		14			
Н	3333	1ST FLOOR CABINET HEATER WEST	15				3333				16	SPARE		
Н	3333		17		40			3333	1	50	18			
Н	3333	(15)	19	3		7500			3		20	(18)	4167	Н
Н	3333	1ST FLOOR CABINET HEATER CENTER	21				7500		1		22	2ND FLOOR CABINET HEATER NORTH	4167	Н
Н	3333	1	23		40			7500	1	50	24		4167	Н
Н	3333	(17)	25	3		7500			3		26	(20)	4167	Н
Н	3333	1ST FLOOR CABINET HEATER NORTH	27				7500		1		28	3RD FLOOR CABINET HEATER WEST	4167	Н
Н	3333	7	29		40			7500	1	50	30	1	4167	Н
Н	4167	(24)	31	3		8333			3		32	(22)	4167	Н
Н	4167	3RD FLOOR CABINET HEATER NORTH	33				8333		1		34	3RD FLOOR CABINET HEATER CENTER	4167	Н
Н	4167	7	35		50			8333	1	50	36		4167	Н
	44000	TOTAL		THI	S PANEL->	28167	27417	26667		•	•	TOTAL	38250	
		_							1					1
		LIGHTING(125%	6) = 0.00			28167	27417	26667	1			TOTAL CONNECTED LOAD (VA):	82,250.00	
		RECEPTS<=10000(100%	LARGEST MOTOR(125%) = 937.50					KITCHEN LOADS(65%) = 0.00			TOTAL CONNECTED CURRENT (A):	228.30		
		RECEPTS>10000(50%		OTHER MOTORS(100%) = 1500.00					NCES(100%	-		00 407 50		
	RECEPTS TOTAL = 0.00 ELECTRIC HEAT(100%) = 80000.00				MOTOR TOTAL = 2437.50 WATER HEATERS(100%) = 0.00					ATED(100% MISC(100%	•	1 0 1 1 1 1 1 1 1 1 1 1 1 1 1 1 1 1 1 1		
	NOTES:	L=LIGHTING, R=RECEPTACLES, H=ELECTRIC HEAT, ML:		r Motor					NIOADS	<u> </u>		TOTAL DEMAND CURRENT (A)	<u> </u>	Ь

2020 6:25:13 PM


S H K S A R C H I T E C T S

LOAD TY	LOAD	NEMA 1 CIRCUIT DIRECTORY H3 SECTION 2	CIR. NO.	j	OUNT: POLES: BRKR AMP			FEED: SF MAINS:			OID	10,000AIC	MINIMUM	_
LOAD	LOAD	CIRCUIT DIRECTORY	NO .	CIR.	BRKR			SF MAINS		DDI/D	OID	10,000AIC	MINIMUM	_
			NO .	Р		Δ.			CID	DDIZD	OID.			┑
TYPE [1		AMP	Α			CIR. BRKR		CIR.			LOAD
		H3 SECTION 2	1			Α	В	С	Р	AMP	NO.	CIRCUIT DIRECTORY	LOAD	TYPE
		H3 SECTION 2		J							2			
			3								4			
			5		400						6			
ML 1	16320		7	3		19653			3		8	(19)	3333	Н
ML 1	16320	ELEVATOR MOTOR	9				19653				10	HEATER SO. COMMUNITY RM.	3333	Н
ML 1	16320		11		200			19653		40	12		3333	Н
		SPACE	13			3333			3		14	(21)	3333	Н
ML	1500	CABINET HEATER FAN, COM. RM (7)	15	1	20		4833				16	HEATER NO. COMMUNITY RM.	3333	Н
ML	1500	EXHAUST FAN MOTORS, COM. RM (11)	17	1	20			4833		40	18		3333	Н
5	51960	TOTAL	THIS PANEL-> 22987		22987	24487	24487 24487				TOTAL	20000		
SLA	LAVE PANEL->	H3 SECTION 2 (EXISTING)			28167	27417	26667							
		LIGHTING(125%		51153		51903	51153				TOTAL CONNECTED LOAD (VA):	154,210.00		
	RECEPTS<=10000(100%) = 0.00 RECEPTS>10000(50%) = 0.00 RECEPTS TOTAL = 0.00					SEST MOTOR(12	•		KITCHEN LOADS(65%) = 0.00			TOTAL CONNECTED CURRENT (A):	428.04	
						= 0.00 MOTOR TOTA			APPLIANCES(100%) = 0.00 DEDICATED(100%) = 0.00					
												· · · · · · · · · · · · · · · · · · ·		
	NOTEC:	ELECTRIC HEAT(100%) = 10 L=LIGHTING, R=RECEPTACLES, H=ELECTRIC HEAT, ML=		WATER HEATERS(100%) = 0.00					/ISC(100%	<u> </u>	TOTAL DEMAND CURRENT (A)	462.02		

D=DEDICATED, X=MISC, SF=SUB FEED

1050 N. 38th St.
Seattle, WA 98103
— PH: 206.675.9151
_ www.shksarchitects.com



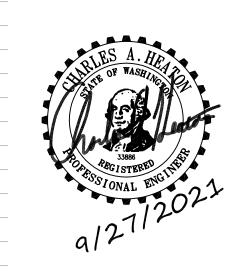

KCHA EASTRIDGE ELEVATOR MODERNIZATION

100% CD

120 W. SUNSET WAY
ISSAQUAH, WA 98027

Drawn by:

Checked:

BM

Date:

5/21/2021

Scale:

As indicated

Revisions:

PANEL SCHEDULES

-6.2