KCHA GUSTAVES MANOR ENVELOPE UPGRADE

ABBREVIATIONS

I.D.

OT

& ∟ @ # (E) Բլ	AND ANGLE AT DIAMETER POUND OR NUMBER EXISTING CENTERLINE PROPERTY LINE
A.B.	ANCHOR BOLT
ABV	ABOVE
AC	AIR CONDITIONING
ACP	ACOUSTIC CEILING PANEL
ACU	AIR CONDITION UNIT
ADJ	ADJUSTABLE
AFF	ABOVE FINISHED FLOOR
ALT	ALTERNATE
ALUM	ALUMINUM
APPROX	APPROXIMATELY
ARCH	ARCHITECT, ARCHITECTURAL
BLDG	BUILDING
BLW	BELOW
BM	BEAM
B.O.	BOTTOM OF
BRS	BACKER ROD & SEALANT
CB CBB CJ CL CLG CLR CO COL CONC COND CONT CPT CT CTR	CATCH BASIN CEMENT BACKER BOARD CEMENT CONTROL JOINT CENTERLINE CEILING CLEAR CLEAN OUT COLUMN CONCRETE CONDITION CONTINUOUS CARPET CERAMIC TILE CENTER
DBL	DOUBLE
DEMO	DEMOLISH
DF	DRINKING FOUNTAIN
DIA	DIAMETER
DIFF	DIFFUSER
DIM	DIMENSION
DISP	DISPENSER
DN	DOWN
DR	DOOR
DS	DOWNSPOUT
DTL	DETAIL
DW	DISHWASHER
E	EAST
EA	EACH
ECS	EXTERIOR COMPOSITE SIDING
EF	EXHAUST FAN
EJ	EXPANSION JOINT
EL	ELEVATION
ELEC	ELECTRICAL
ELEV	ELEVATOR
EMERG	EMERGENCY
EQ	EQUAL
EXP	EXPANSION
EXT	EXTERIOR
FBP FD FE FF FN FIN FLR F.O. FOIC FOIO FR FS FT	FIBER BOARD PANEL FLOOR DRAIN FIRE EXTINGUISHER FINISH FLOOR FIRE HYDRANT FINISH FLOOR FACE OF FURNISHED BY OWNER, INSTALL BY CONTRACTOR FURNISHED BY OWNER INSTALL BY OWNER FIRE RESISTANT FLOOR SINK FEET

GA	GAUGE
GALV	GALVANIZED
GB	GRAB BAR
GC	GENERAL CONTRACTOR
GL	GLASS
GLB	GLU-LAM BEAM
GND	GROUND
GR	GRADE
GRTD	GROUTED
GWB	GYPSUM WALL BOARD
HB	HOSE BIBB
HC	HANDICAP
HCMU	HOLLOW CLAY MASONRY UNIT
HDWD	HARDWOOD
HDWE	HARDWARE
HT	HEIGHT
HM	HOLLOW METAL
HR	HOUR
HORIZ	HORIZONTAL
I.D.	INSIDE DIAMETER
Insul	INSULATION
Int	INTERIOR
JAN	Janitor
Jt	Joint
KIT	KITCHEN
LAB	LABORATORY
LAM	LAMINATE
LAV	LAVATORY
LKR	LOCKER
LOC	LOCATE
LT	LIGHT
LVL	LAMINATED VENEER LUMBER
M MATL MAX MC MECH MEMB MFR MIN MIR MIR MISC MH MO MTD MTL MULL	MEN'S MATERIAL MAXIMUM MEDICINE CABINET MECHANICAL MEMBRANE MANUFACTURER MINIMUM MIRROR MISCELLANEOUS MANHOLE MASONRY OPENING MOUNTED METAL MULLION
N	NORTH
NA	NOT APPLICABLE
NIC	NOT IN CONTRACT
NOM	NOMINAL
NTS	NOT TO SCALE
NR	NOT RATED
OA	OVERALL
OBS	OBSCURE
O.C.	ON CENTER
O.D.	OUTSIDE DIAMETER
OFF	OFFICE
OPNG	OPENING
OPP	OPPOSITE
PC	PRECAST CONCRETE
PL	PLATE
PLAS	PLASTER
PLY	PLYWOOD
P.LAM	PLASTIC LAMINATE
PNT	PAINT
POC	POINT OF CONNECTION
PR	PAIR
PSL	PARALLEL STRAND LUMBER
PT	PRESSURE TREATED
PTN	PARTITION

R or RAD	RADIUS
RB	RESILIENT BASE
RCP	REFLECTED CEILING PLAN
RD	ROOF DRAIN
REF	REFERENCE
REFR	REFRIGERATOR
REINF	REINFORCED
RELOC	RELOCATE
REQ'D	REQUIRED
RES	RESILIENT
RM	ROOM
RO	ROUGH OPENING
RV	ROOF VENT
RL	RAIN WATER LEADER
S SA SC SCHED SECT SG SHT SIM SPEC SQ S.S. STA STD STL STN STD STL STN STOR STN STOR STN STOR STRUCT SOG SUSP SYM	SOUTH SMOKE ALARM SOLID CORE SCHEDULE SECTION SAFETY GLASS SHEET SIMILAR SPECIFICATION SQUARE STAINLESS STEEL STATION STANDARD STEEL STAIN STORAGE STRUCTURE SLAB ON GRADE SUSPENDED SYMMETRICAL
T, TMP	TEMPERED
T&G	TONGUE & GROOVE
TEL	TELEPHONE
TER	TERRAZZO
THK	THICK
T.O.	TOP OF
TS	TUBE STEEL
TV	TELEVISION
TYP	TYPICAL
UL	UNDERWRITERS' LABORATI
UNO	UNLESS NOTED OTHERWIS
UTIL	UTILITY
VCT	VINYL COMPOSITION TILE
VERT	VERTICAL
VEST	VESTIBULE
VIF	VERIFY IN FIELD
VTR	VENT THRU ROOF
W W/ WC WD WF WIN W/O WOM WM WM WP WR WR WRB WRB WSCT WT	WEST WITH WATER CLOSET WOOD WIDE FLANGE WINDOW WITHOUT WALK OFF MAT WOMEN'S WATER PROOFING WATER RESISTANT WATER-RESISTIVE BARRIE! WAINSCOT WEIGHT

R or RAD

RADIUS

A101 A101 A101 A101 (0)ROOM NAME 101 1t ERS' LABORATORIES ED OTHERWISE R1 OSITION TILE <C1> (101a) STIVE BARRIER _____ /1\ DESCRIPTION

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A101

DRAFTING SYMBOLS

A101

WALL SECTION

BLDG SECTION

EXTERIOR ELEVATION

INTERIOR ELEVATION

DETAIL

NORTH ARROW

GRID HEAD

ROOM TAG

WINDOW &

OR ROOF TAG


STOREFRONT TAG


FLOOR, WALL, CEILING

CASEWORK TAG DOOR TAG KEY NOTE ELEVATION NOTE SPOT ELEVATION CENTERLINE PROPERTY LINE FLOOR TRANSITION REVISION BREAKLINE DIMENSION POINT

ENLARGED DETAIL CALLOUT

MATERIAL SYMBOLS

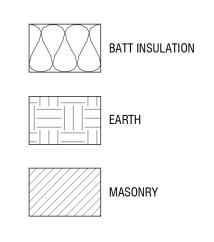

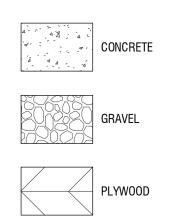

QUARRY TILE

RIGID INSULATION



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GENERAL NOTES

- 1. WHERE CONFLICTS OCCUR, THE SCOPE OF WORK TAKES PRECEDENCE OVER SPECIFICATIONS, AND SPECIFICATIONS TAKE
- PRECEDENCE OVER THE DRAWINGS. 2. REVIEW GUSTAVES ENVELOPE & ROOF INVESTIGATIVE REPORT DATED 4/8/20.
- 3. MATERIALS, ASSEMBLIES AND NOTED ITEMS ARE NEW UNLESS OTHERWISE NOTED.
- 4. CONTRACTOR SHALL VERIFY CONDITIONS. NOTIFY THE OWNER OF ANY CONDITIONS INCONSISTENT WITH THE INTENT OF THE DRAWINGS PRIOR TO STARTING OR CONTINUING WORK IN THE AREA CONCERNED.
- 5. DO NOT DISCONNECT POWER, DATA OR CABLE DUBING CONSTRUCTION, COORDINATE REQUIRED SHUTDOWNS WITH OWNER

- ALL WORK SHALL CONFORM TO APPLICABLE CODES AND LOCAL BUILDING REQUIREMENTS, WHICH INCLUDE THE MOST CURRENT EDITIONS OF THE INTERNATIONAL BUILDING CODE WITH LOCAL AMENDMENTS. INTERNATIONAL MECHANICAL CODE (IMC), NATIONAL ELECTRICAL CODE (NEC), INTERNATIONAL FIRE CODE (IFC), AND WASHINGTON STATE ENERGY CODE (WEC)
- 2 PER JERC 503 1 ALL WORK IS CLASSIFIED AS AN ALTERATION LEVEL 1 REMOVAL OR REPLACEMENT OF EXISTING MATERIALS ELEMENTS, EQUIPMENT, OR FIXTURES USING NEW MATERIALS, ELEMENTS, EQUIPMENT, OR FIXTURES THAT SERVE THE SAME PURPOSE, PER IEBC 701.2. AN EXISTING BUILDING SHALL NOT BE ALTERED SUCH THAT THE BUILDING BECOMES LESS SAFE THAN ITS EXISTING CONDITION.
- 3. PER WSEC R503.1.1 EXCEPTION 3, THE BUILDING ENVELOPE ALTERATION IS NOT REQUIRED TO MEET NEW CONSTRUCTION BECAUSE THE WALL AND ROOF CAVITIES EXPOSED DURING CONSTRUCTION SHALL BE FILLED WITH INSULATION. PER WSEC R503.1.1.1. REPLACEMENT FENESTRATION WILL MEET U-FACTORS AND SHGC PER TABLE R402.1.2.
- 4. BEFER TO WINDOW SCHEDULE FOR WINDOW SIZES AND TYPES. ALL GLAZING WITHIN 18" OF INTERIOR FLOOR. EXTERIOR WALKING SURFACE OR WITHIN 24" OF A DOOR IN ANY POSITION TO BE TEMPERED GLASS UNLESS INDICATED OTHERWISE.
- 5. ELECTRICAL PERMITS TO BE APPLIED FOR UNDER SEPARATE APPLICATION BY CONTRACTOR. 6. EXISTING FIRE EXTINGUISHERS AND CABINETS ARE NOT SHOWN ON PLANS. PROTECT EXISTING FIRE EXTINGUISHERS AND CABINETS (RECESSED OR SURFACE MOUNTED) FROM DAMAGE.

HA7MAT

1. THE CONTRACTOR WILL SUSPEND WORK IMMEDIATELY AND NOTIFY THE OWNER IF MATERIALS SUSPECTED OF BEING HAZARDOUS, AND NOT PREVIOUSLY IDENTIFIED, ARE ENCOUNTERED IN THE COURSE OF THE CONTRACTOR'S WORK.

DEMOLITION:

- 1. WHERE ITEMS ARE INDICATED ON PLANS TO BE DEMOLISHED, IT SHALL MEAN THE COMPLETE REMOVAL AND DISPOSAL OF THE ITEM INDICATED UNLESS OTHERWISE NOTED. "REMOVE" MEANS TO COMPLETELY AND PERMANENTLY REMOVE FROM THE PROJECT.
- 2. CONTRACTOR IS RESPONSIBLE FOR REVIEW OF THE ARCHITECTURAL DRAWINGS AND SPECIFICATIONS FOR CUTTING AND PATCHING WORK.

DIMENSIONS:

- 1. DO NOT SCALE DRAWINGS
- 2. VERIFY DIMENSIONS SHOWN ON DRAWINGS. USE ONLY DIMENSIONS INDICATED. PRIOR TO STARTING OR CONTINUING WORK, NOTIFY OWNER OF DISCREPANCIES OR CONDITIONS INCONSISTENT WITH THE INTENT OF THE CONSTRUCTION DOCUMENTS. 3. DIMENSIONS ARE TO FACE OF CONCRETE, FACE OF MASONRY, OR FACE OF STUD, UNLESS OTHERWISE NOTED.
- 4. FINISHED SURFACE OF INFILL OR EXTENSIONS OF EXISTING PARTITIONS SHALL ALIGN WITH ADJACENT EXISTING SURFACES UNLESS OTHERWISE NOTED.
- 5. VERTICAL DIMENSIONS ARE MEASURED FROM STRUCTURAL SLAB, TOP OF STEEL OR TOP OF SHEATHING, UNLESS NOTED OTHERWISE

COORDINATION

- 1. COORDINATE ALL OPERATIONS WITH OWNER, SUCH AS AREAS USED FOR MATERIAL STORAGE, ACCESS TO AND FROM THE SITE, TIMING OF WORK AND REQUIREMENTS OF NOISE ORDINANCE. INSTALL DUST AND NOISE BARRIERS AS REQUIRED TO PROTECT EXISTING ADJACENT BUILDINGS AND OCCUPANTS AND TO MAINTAIN AN ENVIRONMENT SUITABLE TO PERMIT CONTINUED OCCUPANCY OF SUBJECT AND ADJACENT BUILDINGS.
- 2. REVIEW DEMOLITION DRAWINGS. PATCH AND REPAIR ALL EXISTING SURFACES AFFECTED BY DEMOLITION WORK.
- 3. VERIFY LOCATIONS OF EXISTING UTILITIES. CAP, MARK AND PROTECT AS NECESSARY TO COMPLETE THE WORK.
- 4. PIPING, CONDUITS, DUCTS, ETC. SHALL BE CONCEALED IN WALLS, CHASES, ABOVE SUSPENDED CEILINGS, BELOW FLOORS OR BE FURRED-IN IN ROOMS WITH EXISTING CEILINGS, UNLESS OTHERWISE NOTED. DO NOT CONCEAL PIPING, CONDUITS, DUCTS, ETC. IN ELECTRICAL, MECHANICAL, AND COMMUNICATION ROOMS.
- 5. COORDINATE AND PROVIDE REQUIRED PENETRATIONS AND PATCHING WITH INDIVIDUAL SUBCONTRACTORS TO SUIT NEW WORK.



PROJECT INFORMATION

PROJECT OWNER KING COUNTY HOUSING AUTHORITY

PROJECT MANAGER AMY KURTZ TEL: (206) 574-1283 EMAIL: amyk@kcha.org

PROJECT ADDRESS 107 W MAIN ST AUBURN, WA 98001

SCOPE DESCRIPTION EXTERIOR ENVELOPE UPGRADES INCLUDING REPLACEMENT OF EXTERIOR SIDING, SHEATHING, TRIM, WEATHER PROOFING, WINDOWS, DOORS, ROOFING, AND LIGHTING.

ZONING ANALYSIS

PARCEL NUMBER 781620-0130

LEGAL DESCRIPTION SLAUGHTER 1ST ADD TO TOWN OF

LOT AREA 10,200 SF / .23 ACRES

ZONE DUC

1982

CURRENT USE APARTMENT

YEAR BUILT

(E) BLDG AREA

39,732 SF +/- (GROSS) (E) LOT COVERAGE

9,958 SF +/-, NO CHANGE

HT LIMIT 51'-10" +/- ABOVE GRADE, NO CHANGE

PARKING QUANTITY NO CHANGE

REQUIRED SETBACKS NO CHANGE

APPLICABLE CODES

- AUBURN MUNICIPAL CODE
- 2018 INTERNATIONAL BUILDING CODE
- 2018 INTERNATIONAL EXISTING BUILDING CODE 2009 ICC A117.1 ACCESSIBILITY REQUIREMENTS
- 2018 WASHINGTON STATE ENERGY CODE
- ALL CODES ADOPTED AND AMENDED BY THE STATE BUILDING CODE COUNCIL IN CHAPTER 51 WAC

DESIGN TEAM

ARCHITECT SHKS ARCHITECTS 1050 NORTH 38TH ST SEATTLE, WA 98103

CONTACT: LEVI JETTE TEL: 206.675.9151 EMAIL: levij@shksarchitects.com ELECTRICAL ENGINEER

CASE ENGINEERING 19515 NORTH CREEK PARKWAY, SUITE 302 BOTHELL, WA 98011 CONTACT: MICHAEL CASE TEL: 425.402.9400 x112 EMAIL: michael@caseeng.co


STRUCTURAL ENGINEER PCS STRUCTURAL SOLUTIONS 1011 WESTERN AVENUE, SUITE 810 SEATTLE WA 98104 CONTACT: DAN TAPPEL TEL: 206.292.5076 EMAIL:DTappel@pcs-structural.com

SHEET INDEX

A0.0	COVER SHEET
A1.0	SITE PLAN
AD2.1	FIRST FLOOR DEMO PLAN
	SECOND FLOOR DEMO PLAN
AD2.3	THIRD-FIFTH FLOOR DEMO PLAN
AD2.4	ROOF DEMO PLAN
AD3.0	DEMO ELEVATIONS
AD3.1	DEMO ELEVATIONS
	FIRST FLOOR PLAN
	SECOND FLOOR PLAN
	THIRD-FIFTH FLOOR PLAN
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	EXTERIOR ELEVATIONS
	EXTERIOR ELEVATIONS & BLDG SECTION
	WALL SECTIONS
	WALL SECTIONS
A3.4	EXTERIOR FINISH ELEVATIONS
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A4.1	DETAILS
A4.2	ROOF ASSEMBLIES AND DETAILS
A4.3	ROOF AND CURB DETAILS
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A4.5	WINDOW & DOOR DETAILS, SCHEDULES
- 4 4	
	ELEC LEGEND AND SITE PLAN, LIGHT SCHEDULE
	1ST AND 2ND FLOOR LIGHTING PLANS
E2.2	3RD THRU 5TH FLOOR TYP LIGHTING PLAN

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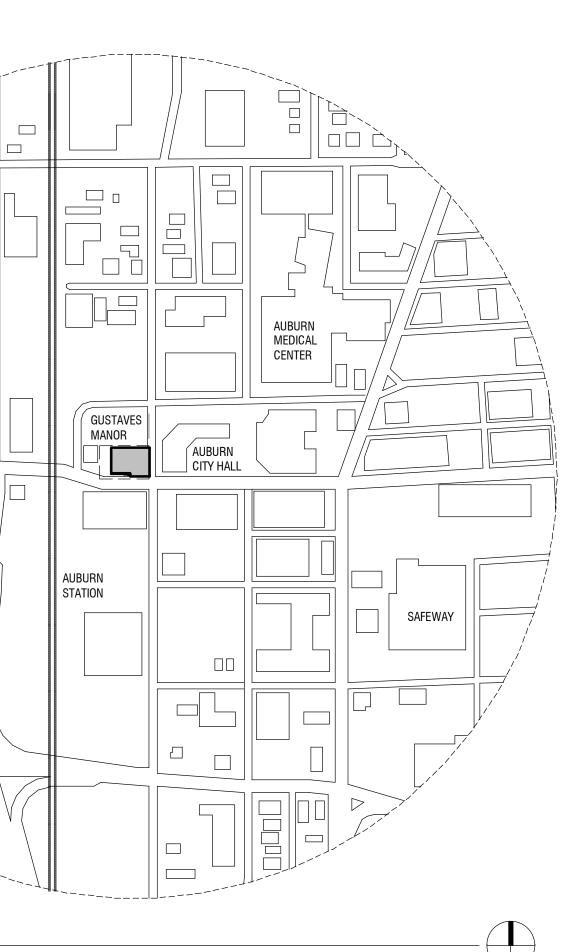
1050 N. 38th St. Seattle, WA 98103 рн: 206.675.9151 www.shksarchitects.com JONATHAN H. HARTUR STATE OF WASHINGT ____ _ KCHA - GUSTAVES MANOR - ENVELOPE UPGRADE BID SET 107 W MAIN ST — AUBURN, WA 98001 Drawn by: Checked: 03/08/2022 Date: Scale: As indicated Revisions: Remarks <u>No.</u> Date _ COVER SHEET

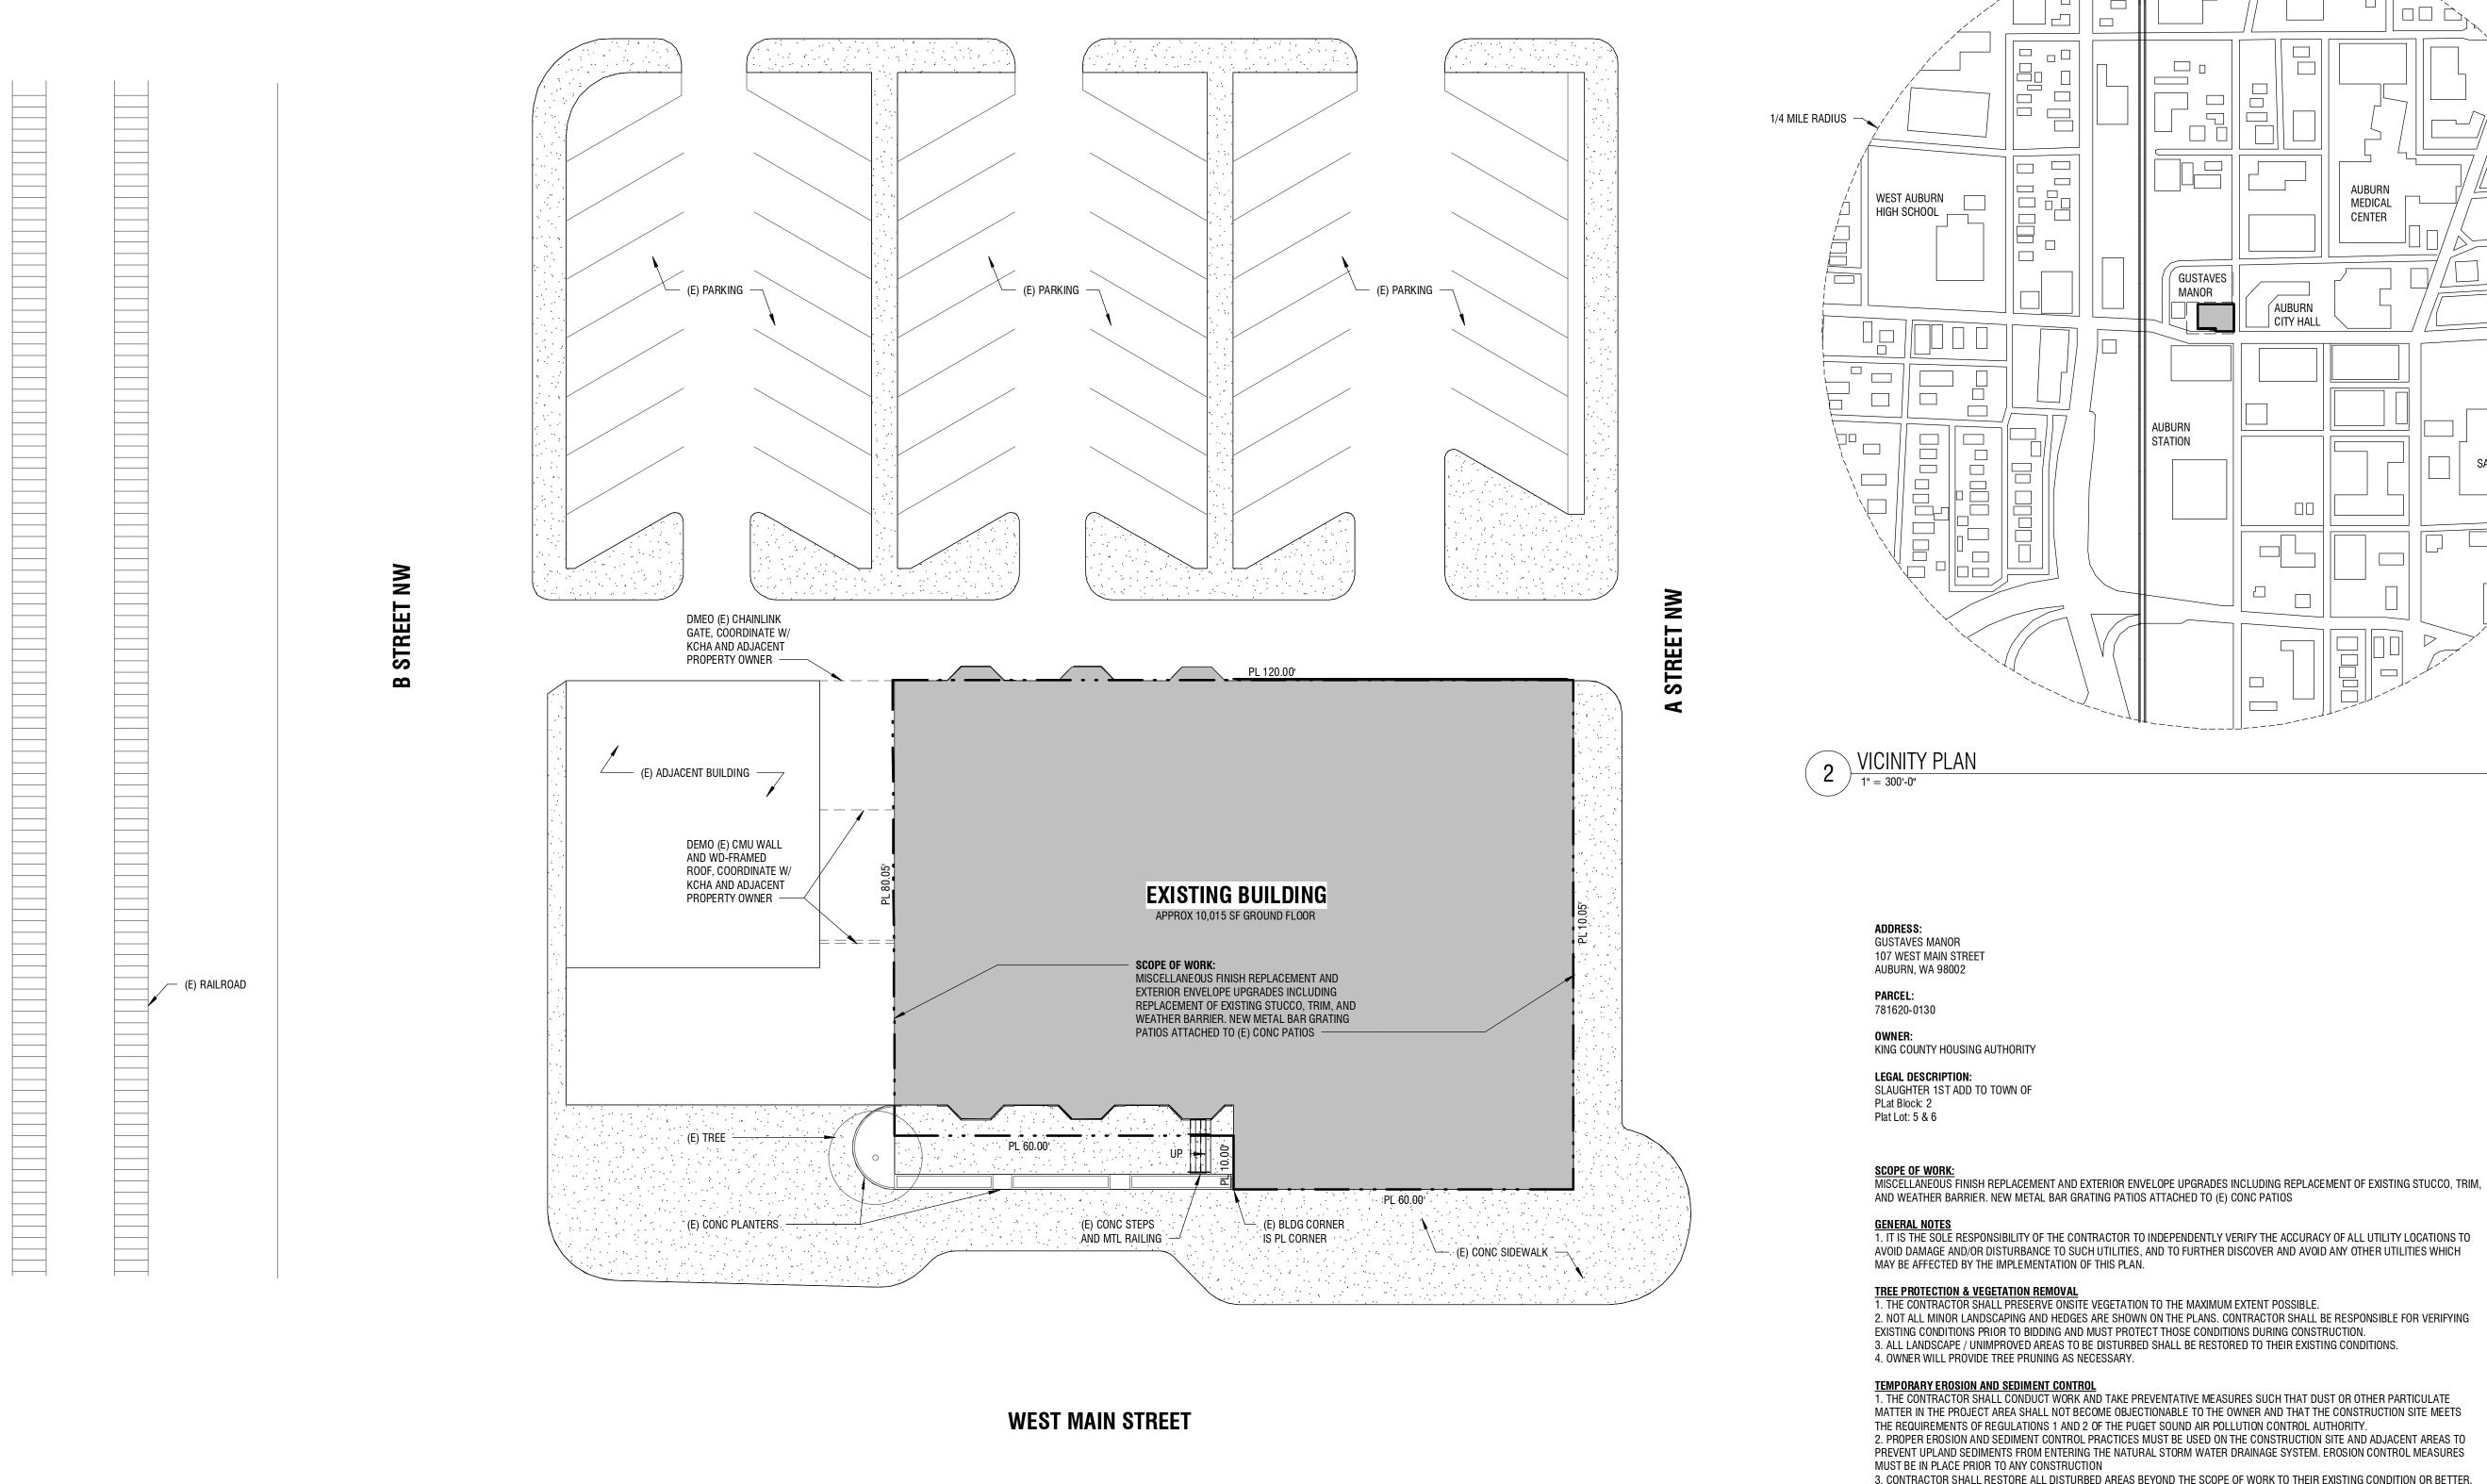

1ST STREET NW

0 2' 4' 8' 16'

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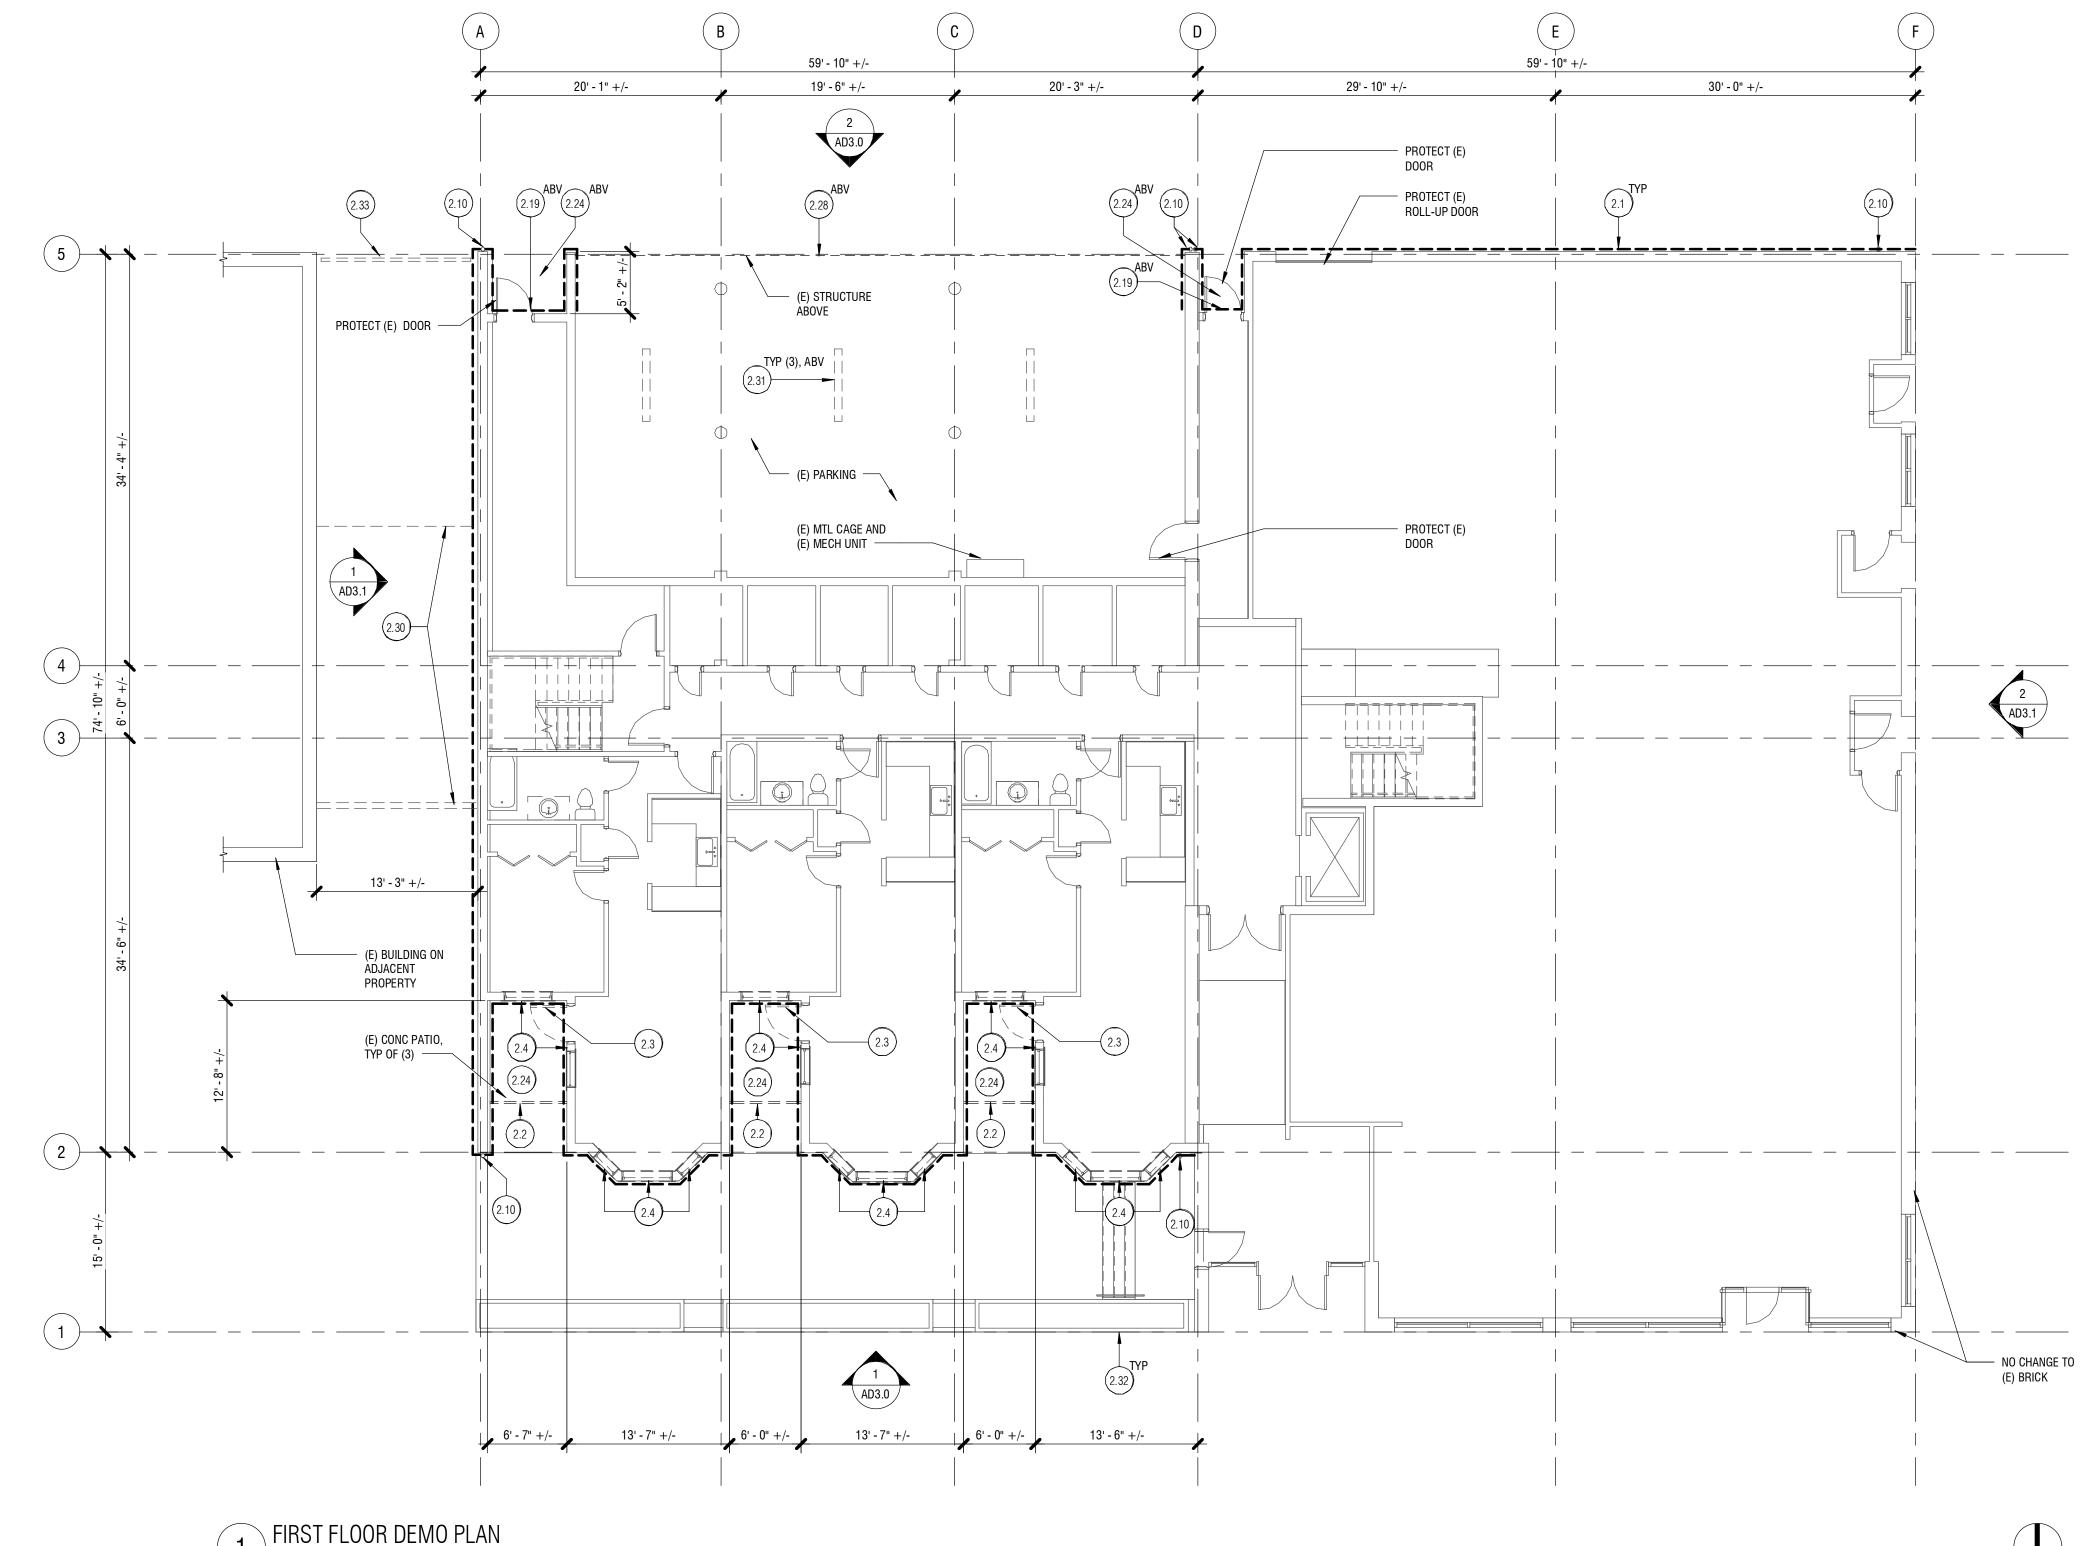
AVOID DAMAGE AND/OR DISTURBANCE TO SUCH UTILITIES, AND TO FURTHER DISCOVER AND AVOID ANY OTHER UTILITIES WHICH

2. NOT ALL MINOR LANDSCAPING AND HEDGES ARE SHOWN ON THE PLANS. CONTRACTOR SHALL BE RESPONSIBLE FOR VERIFYING EXISTING CONDITIONS PRIOR TO BIDDING AND MUST PROTECT THOSE CONDITIONS DURING CONSTRUCTION. 3. ALL LANDSCAPE / UNIMPROVED AREAS TO BE DISTURBED SHALL BE RESTORED TO THEIR EXISTING CONDITIONS.

1. THE CONTRACTOR SHALL CONDUCT WORK AND TAKE PREVENTATIVE MEASURES SUCH THAT DUST OR OTHER PARTICULATE MATTER IN THE PROJECT AREA SHALL NOT BECOME OBJECTIONABLE TO THE OWNER AND THAT THE CONSTRUCTION SITE MEETS THE REQUIREMENTS OF REGULATIONS 1 AND 2 OF THE PUGET SOUND AIR POLLUTION CONTROL AUTHORITY. 2. PROPER EROSION AND SEDIMENT CONTROL PRACTICES MUST BE USED ON THE CONSTRUCTION SITE AND ADJACENT AREAS TO PREVENT UPLAND SEDIMENTS FROM ENTERING THE NATURAL STORM WATER DRAINAGE SYSTEM. EROSION CONTROL MEASURES

3. CONTRACTOR SHALL RESTORE ALL DISTURBED AREAS BEYOND THE SCOPE OF WORK TO THEIR EXISTING CONDITION OR BETTER.

1050 N. 38th St. Seattle, WA 98103 рн: 206.675.9151 www.shksarchitects.com 5158 REGISTERED ARCHITEC JONATHAN H. HARTUNG STATE OF WASHINGTON ____ $_$ KCHA - GUSTAVES MANOR ⁻ ENVELOPE UPGRADE BID SET 107 W MAIN ST — AUBURN, WA 98001 Drawn by: Checked: IJ ___ Date: 03/08/2022 Scale: As indicated Revisions: Remarks No. Date SITE PLAN



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	- 5158 REGISTERED ARCHITECT
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IOR FINISHES TO ME 25 SHEETS	_ KCHA
	- GUSTAVES MANOR
owner immediately.	 ENVELOPE UPGRADE
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	BID SET
	107 W MAIN ST — AUBURN, WA 98001
M. DAMAGED	_
) DOOR THRESHOLD,	Drawn by:JI
	Checked:LJ Date: 03/08/2022
	Scale: As indicated
KCHA AND ADJACENT	— Revisions: <u>No. Date Remarks</u>
	1 2.23.22 ASI-01
OORDINATE W/ KCHA	_
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	- FIRST FLOOR
	- AD2.1

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DEMO LEGEND: — — — DEMOLISH


 (E) WALL

----- DEMO (E) STUCCO, (E) WEATHER BARRIER, AND (E) TRIM.

(E) SHEATHING, (E) STRUCTURE, (E) INSULATION AND (E) INTERI ŘÉMAIN, PROTEČT AND COORDINATE REPAIR W/ OWNĚŘ, ASSUM TO BE REPLACED

0 1' 2' 4' 8' 12'

- GENERAL NOTES: 1. COORDINATE REQUIRED SHUTDOWNS WITH OWNER.
- PROTECT EXISTING LANDSCAPE.
 IF WATER DAMAGE IS OBSERVED IN THE COURSE OF THE PROJECT, NOTIFY COURSE OF THE PROJECT.
- 4. ALL DIMENSIONS ARE APPROXIMATE. VERIFY IN FIELD.
- **KEYNOTE LEGEND** MARK KEYNOTE TEXT Demo (E) Stucco siding, (E) weather Barrier, and (E) trim. 2.1 SHEATHING TO BE REPLACED 2.2 SALVAGE (E) GLASRAIL RAILING. COORDINATE DECK ACCESS A TEMPORARY RAILINGS WITH KCHA 2.3 REMOVE (E) DOOR, (E) DOOR FRAME, (E) DOOR HARDWARE, (E) and (E) interior trim 2.4 Remove (E) Window, (E) exterior and interior trim 2.10 REMOVE (E) DOWNSPOUT 2.19 SALVAGE (E) SPRINKLER HEAD TO BE REINSTALLED 2.24 Remove (E) Light Fixture 2.28 SALVAGE (E) SECURITY DEVICE 2.30 Demo (E) CMU Wall and WD-Framed Roof. Coordinate W/ PROPERTY OWNER 2.31 Demo (E) Clg-mounted light fixtures 2.32 REMOVE (E) STUCCO FROM EXTERIOR OF PLANTER 2.33 SALVAGE (E) MTL FENCE FOR ADJACENT PROPERTY OWNER. CO

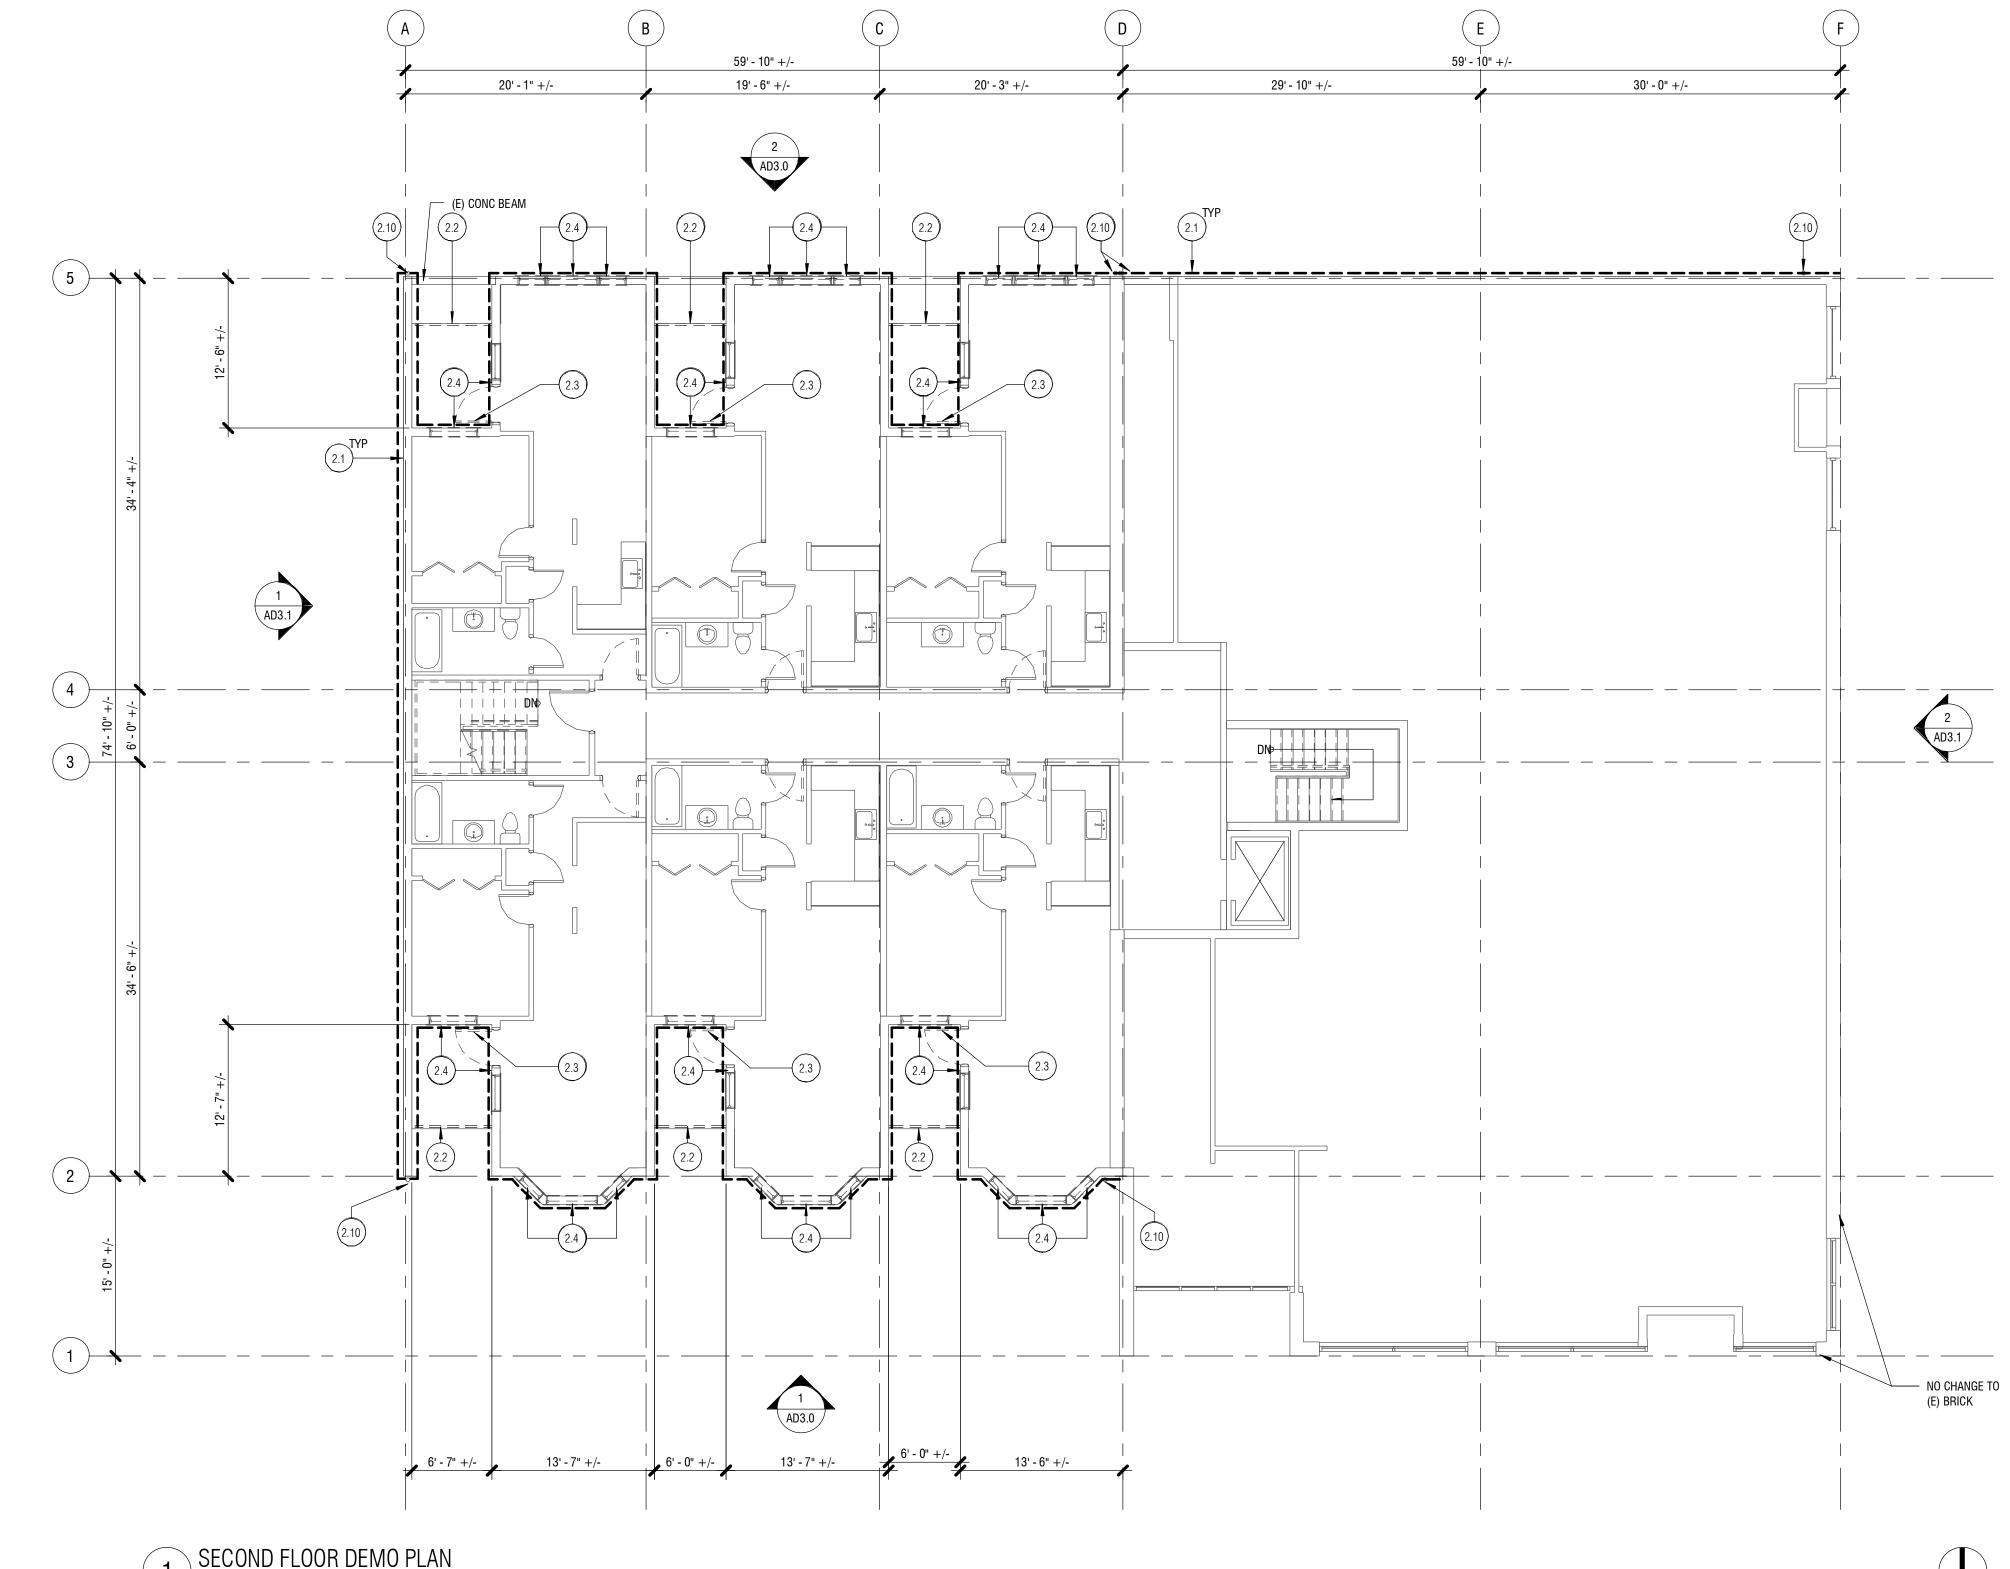

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_	GUSTAVES MANOR ENVELOPE
_	UPGRADE
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	BID SET
_	AUBURN, WA 98001
	Drawn by: JI Checked: LJ
	Date: 03/08/2022 Scale: As indicated
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_	SECOND FLOOR
_	
_	AD2.2

DEMO LEGEND: — — — Demolish

 / _ \
(E) \M/AI

_____ (E) WALL

DEMO (E) STUCCO, (E) WEATHER BARRIER, AND (E) TRIM.


(E) SHEATHING, (E) STRUCTURE, (E) INSULATION AND (E) INTERIOR FINISHES TO RÉMAIN, PROTECT AND COORDINATE REPAIR W/ OWNER, ASSUME 25 SHEETS TO BE REPLACED

0 1' 2' 4' 8' 12'

- GENERAL NOTES: 1. COORDINATE REQUIRED SHUTDOWNS WITH OWNER.
- PROTECT EXISTING LANDSCAPE.
 IF WATER DAMAGE IS OBSERVED IN THE COURSE OF THE PROJECT, NOTIFY OWNER IMMEDIATELY.
- 4. ALL DIMENSIONS ARE APPROXIMATE. VERIFY IN FIELD.

KEYNOTE LEGEND MARK KEYNOTE TEXT Demo (e) Stucco Siding, (e) weather Barrier, and (e) trim. Damaged 2.1 SHEATHING TO BE REPLACED 2.2 SALVAGE (E) GLASRAIL RAILING. COORDINATE DECK ACCESS AND REQUIREMENTS FOR TEMPORARY RAILINGS WITH KCHA 2.3 Remove (E) door, (E) door frame, (E) door hardware, (E) door threshold, and (E) interior trim 2.4 Remove (E) Window, (E) exterior and interior trim 2.10 REMOVE (E) DOWNSPOUT

1THIRD THRU FIFTH FLOOR DEMO PLAN, TYP 1/8" = 1'-0"

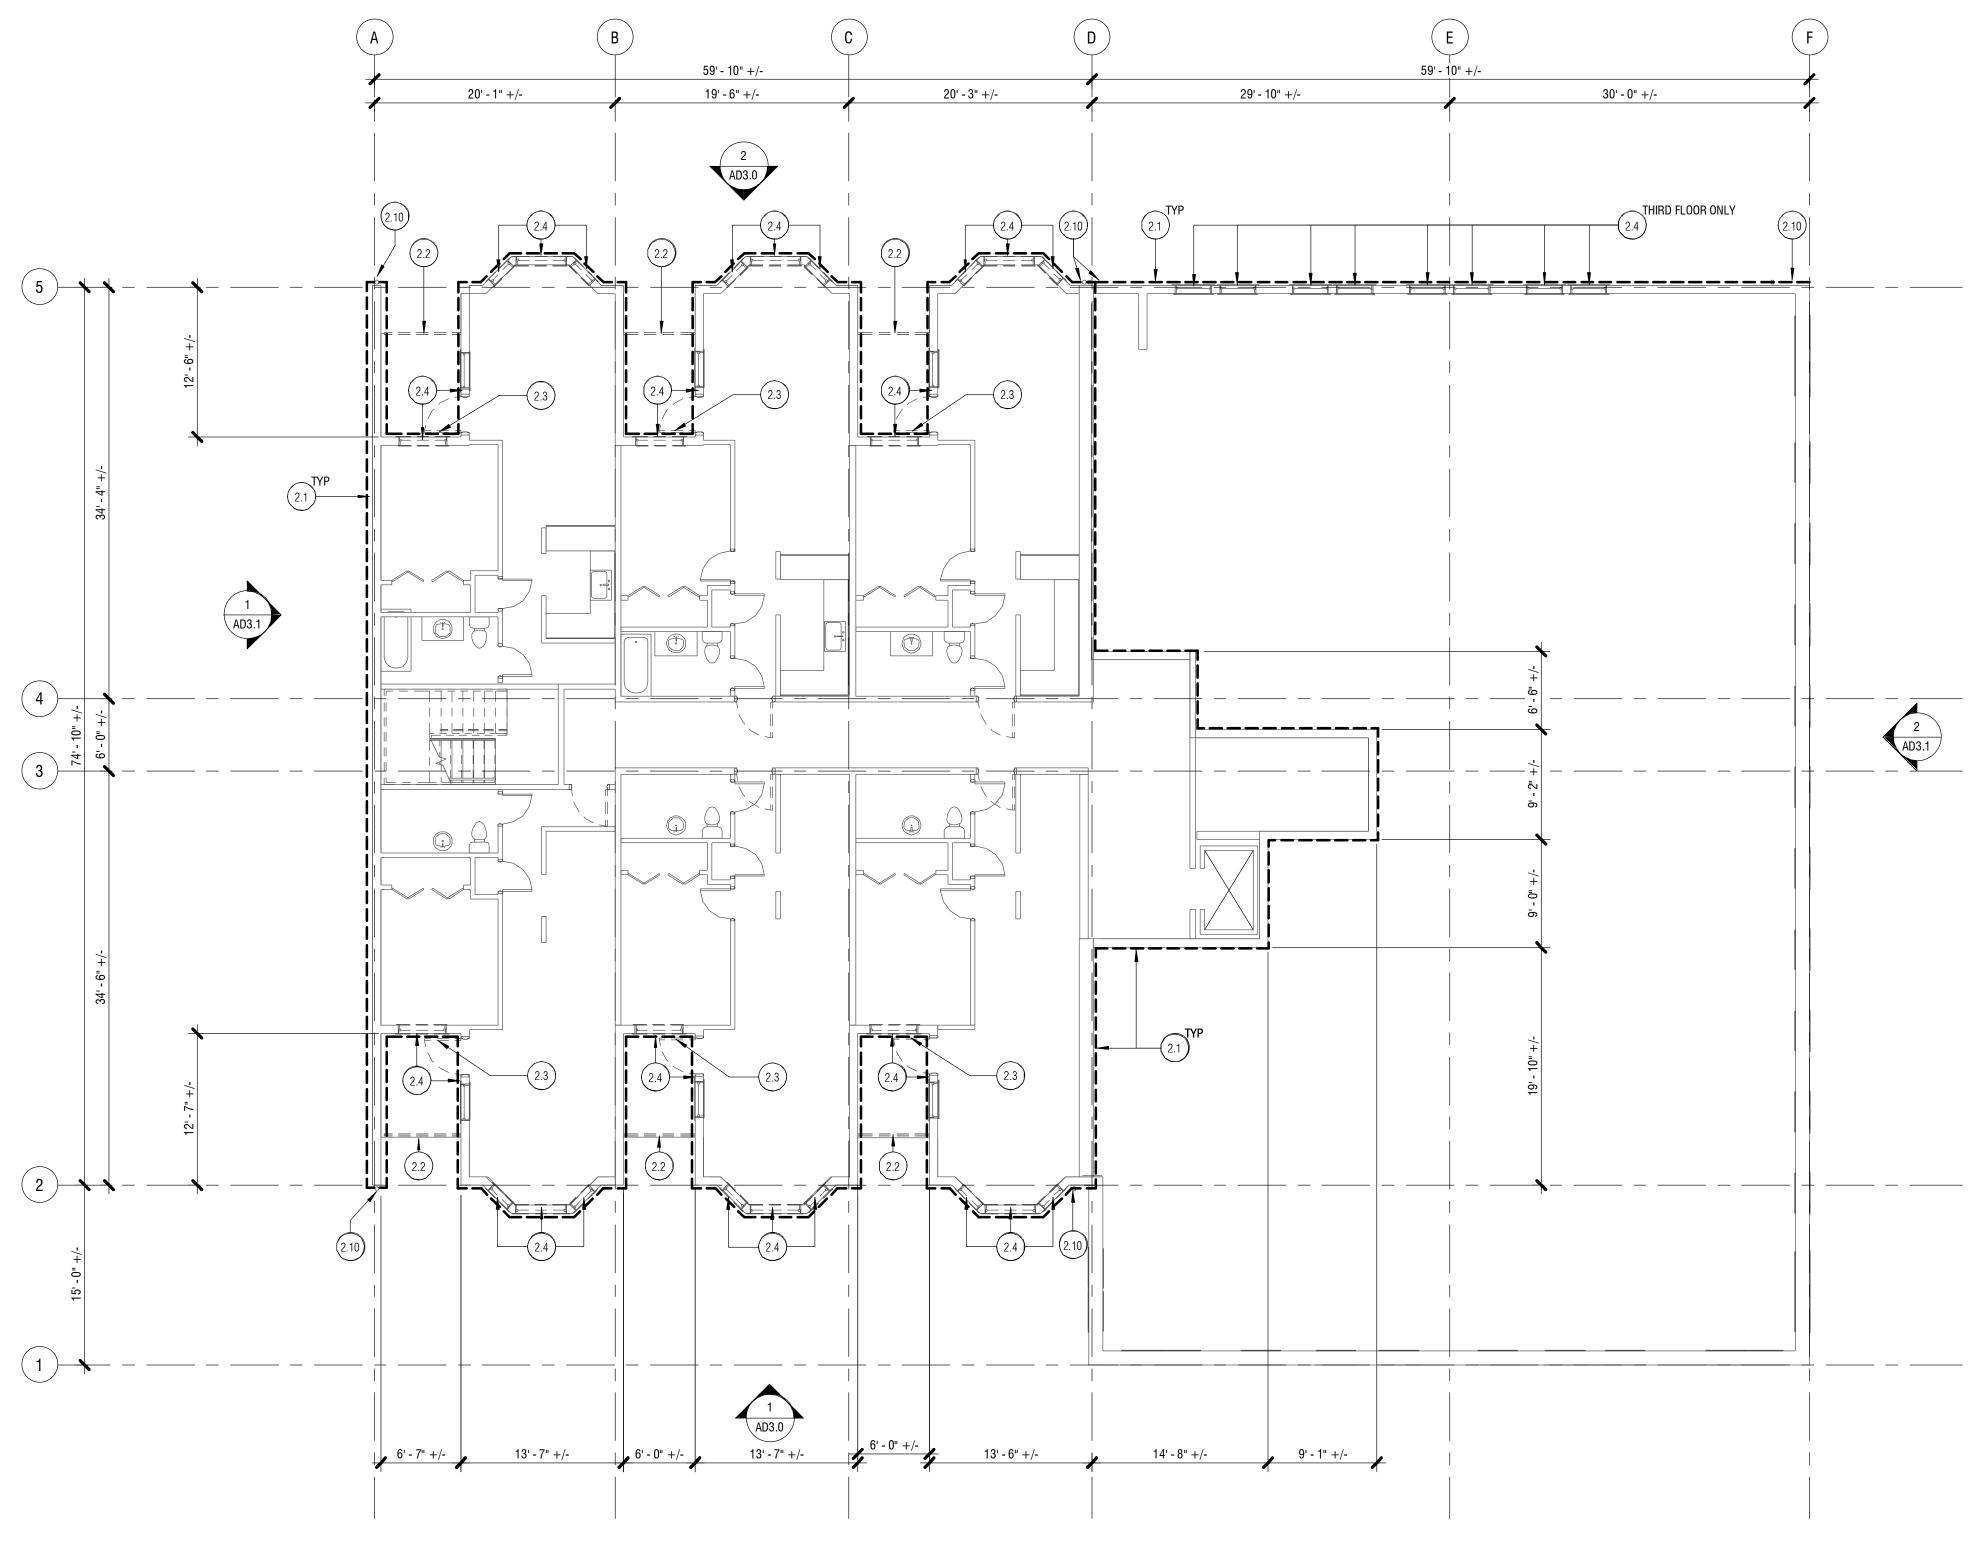

0 1' 2' 4' 8' 12'

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		 GUSTAVES MANOR ENVELOPE
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		 THIRD-FIFTH FLOOR DEMO
		PLAN
		- AD2.3

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DEMO LEGEND: ——— Demolish

(E) WALL


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- 2.4 Remove (E) Window, (E) exterior and interior trim
- 2.10 REMOVE (E) DOWNSPOUT



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ROOF DEMO PLAN

DEMO LEGEND: DEMOLIS

_____ (E) WALL

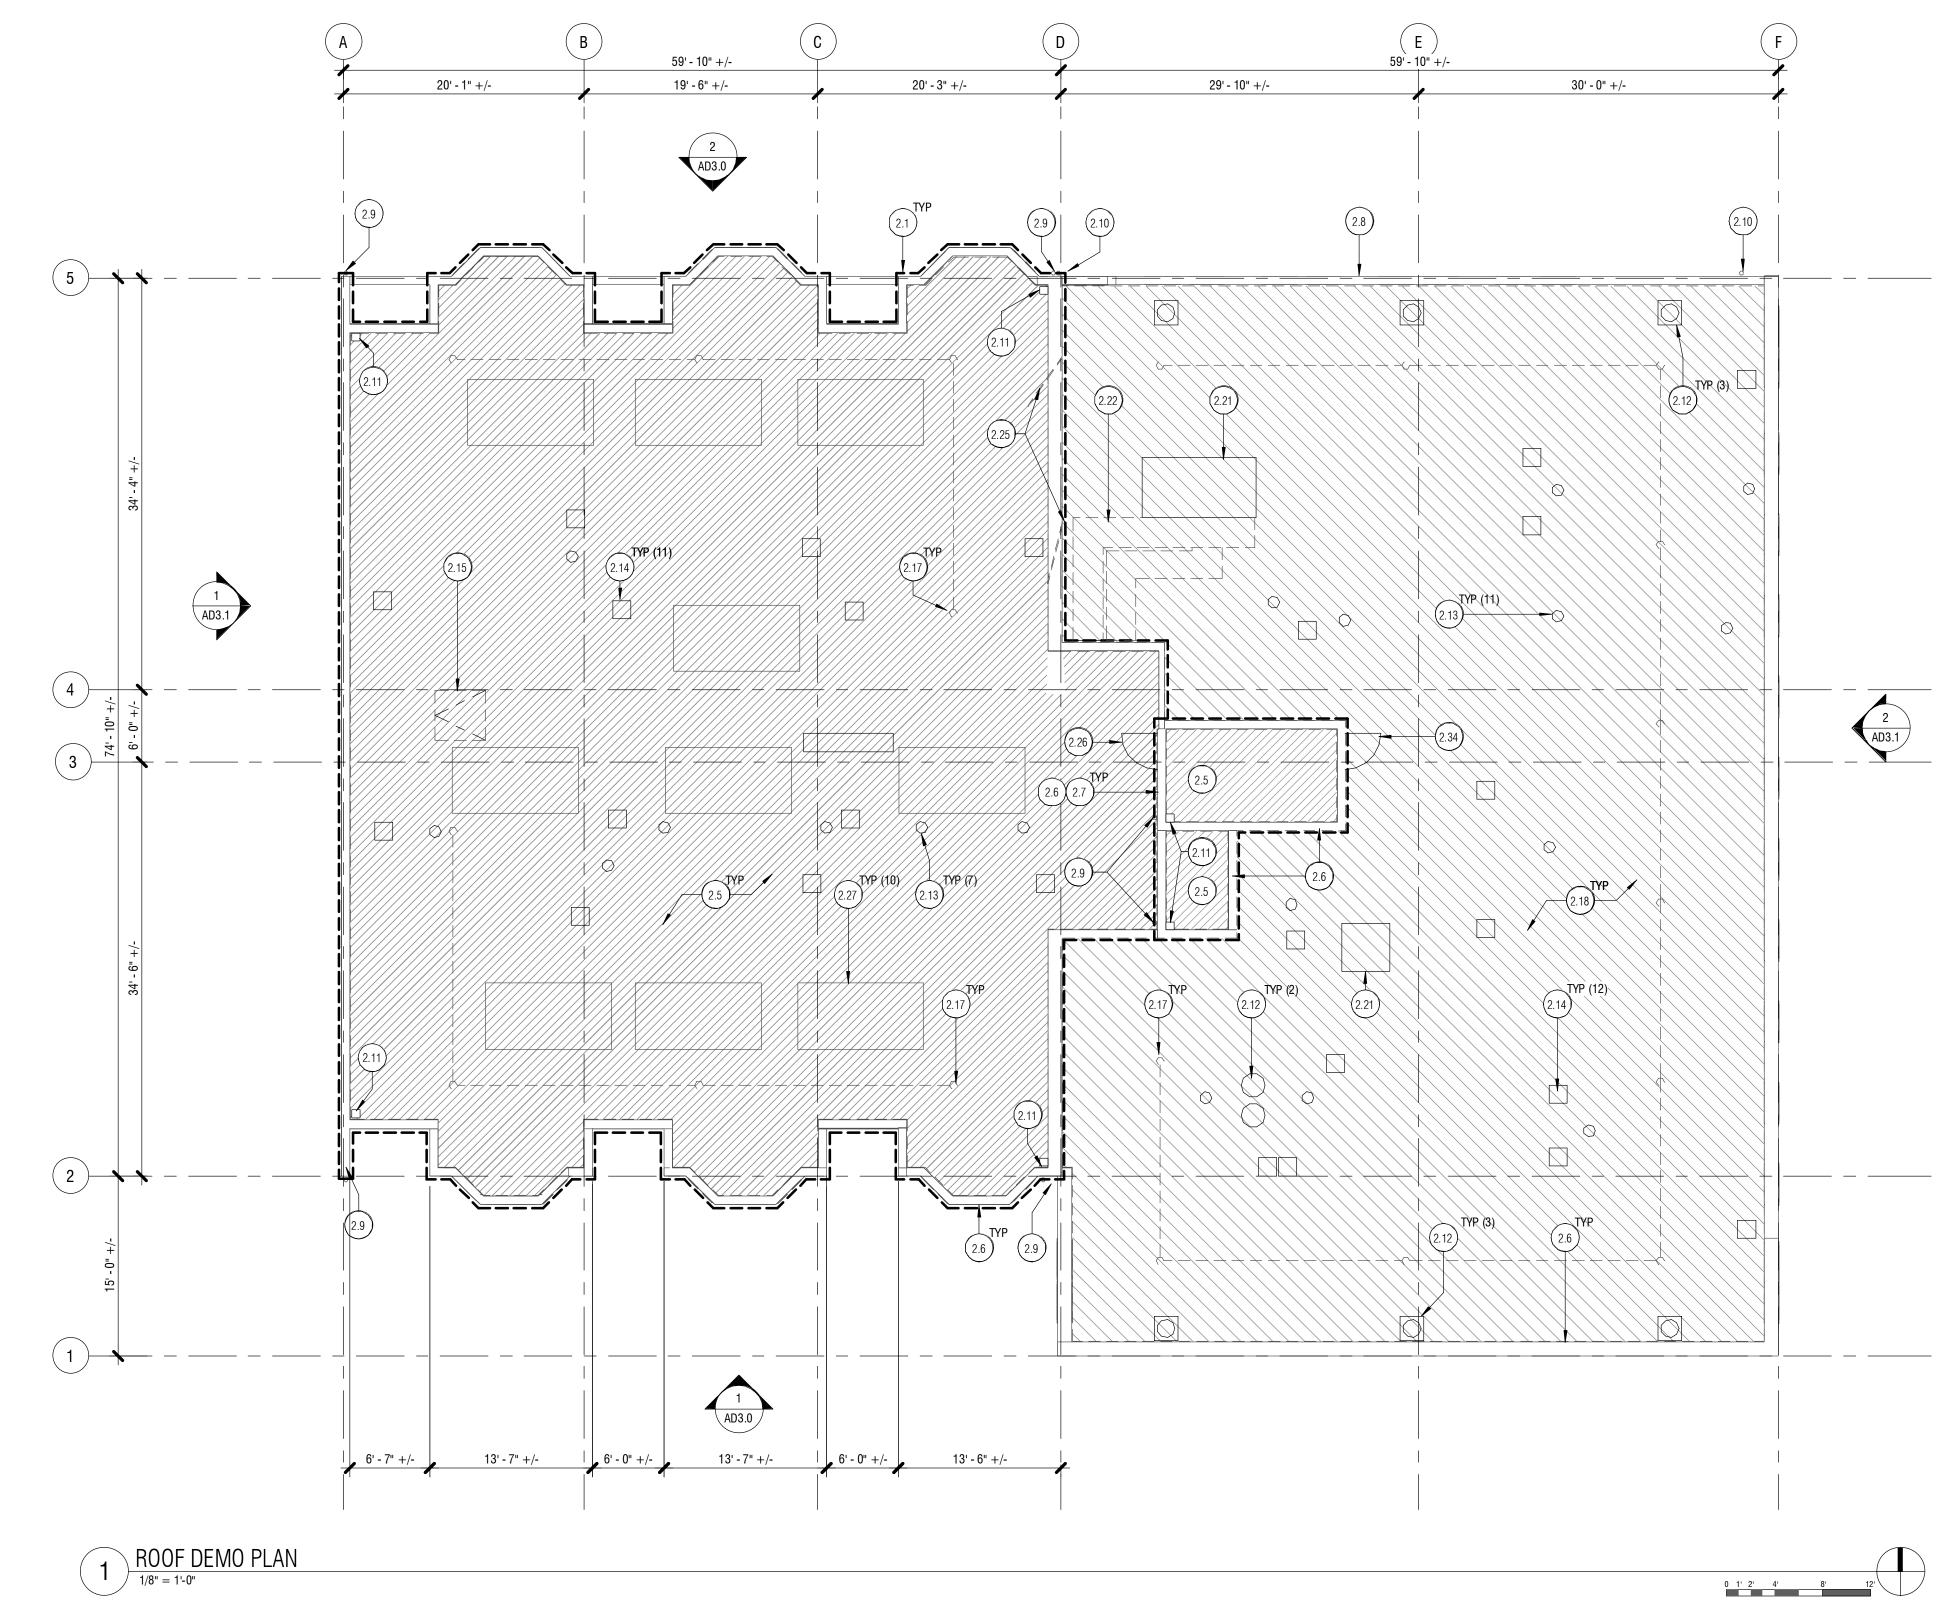DEMO (E) ROOF MEMBRANE AND FLASHING


DEMO (E) ROOF MEMBRANE, INSULATION, AND FLASHING

----- DEMO (E) WEATHER BARRIER, (E) STUCCO, AND (E) TRIM.


(E) SHEATHING, (E) STRUCTURE, INSULATION, AND INTERIOR FINISHES TO REMAIN, PROTECT AND COORDINATE REPAIR W/ OWNER

- <u>GENERAL NOTES:</u> 1. COORDINATE REQUIRED SHUTDOWNS WITH OWNER. 2. PROTECT EXISTING LANDSCAPE. 3. IF WATER DAMAGE IS OBSERVED IN THE COURSE OF THE PROJECT, NOTIFY OWNER IMMEDIATELY. 4. ALL DIMENSIONS ARE APPROXIMATE. VERIFY IN FIELD.

MARK	KEYNOTE TEXT
2.1	Demo (E) Stucco Siding, (E) weather Barrier, and (E) Trim. Damaged sheathing to be replaced
2.5	REMOVE (E) ROOFING, (E) RIGID INSULATION, AND (E) FLASHING
2.6	REMOVE (E) METAL COPING AT ROOF PARAPET
2.7	REMOVE (E) FLASHING AT PENTHOUSE BASE
2.8	REMOVE (E) GUTTER
2.9	SALVAGE (E) DOWNSPOUT
2.10	REMOVE (E) DOWNSPOUT
2.11	REMOVE (E) SCUPPER
2.12	SALVAGE (E) MTL CAPS FOR ROOF VENTILATION
2.13	REMOVE (E) PIPE BOOT AND FLASHING
2.14	REMOVE (E) ROOF VENT
2.15	SALVAGE(E) ROOF ACCESS HATCH AND CURB FOR REINSTALLATION
2.17	REMOVE (E) FALL ARREST SYSTEM CABLE AND ANCHORS
2.18	REMOVE (E) ROOFING AND FLASHING. NOTIFY OWNER OF ANY MOISTURE DAMAGE FOUND AT (E) SHEATHING
2.21	SALVAGE (E) MECH UNIT, CONDUIT, AND WIRING FOR REINSTALLATION
2.22	REMOVE (E) ROOFTOP DUCTWORK
2.25	REMOVE (E) ANTENNA AND ASSOCIATED CABLE
2.26	REMOVE (E) DOOR SLAB, THRESHOLD, AND HARDWARE. (E) DOOR FRAME TO REMAIN
2.27	WORK PERFORMED BY OTHERS: SALVAGE (E) PHOTOVOLTAIC PANELS, ASSOCIATED ELECTRICAL PANELS, CONDUIT, AND WIRING FOR REINSTALLATION,
2.34	Salvage (E) MTL Door, Remove (E) Threshold and Hardware. (E) door frame to remain

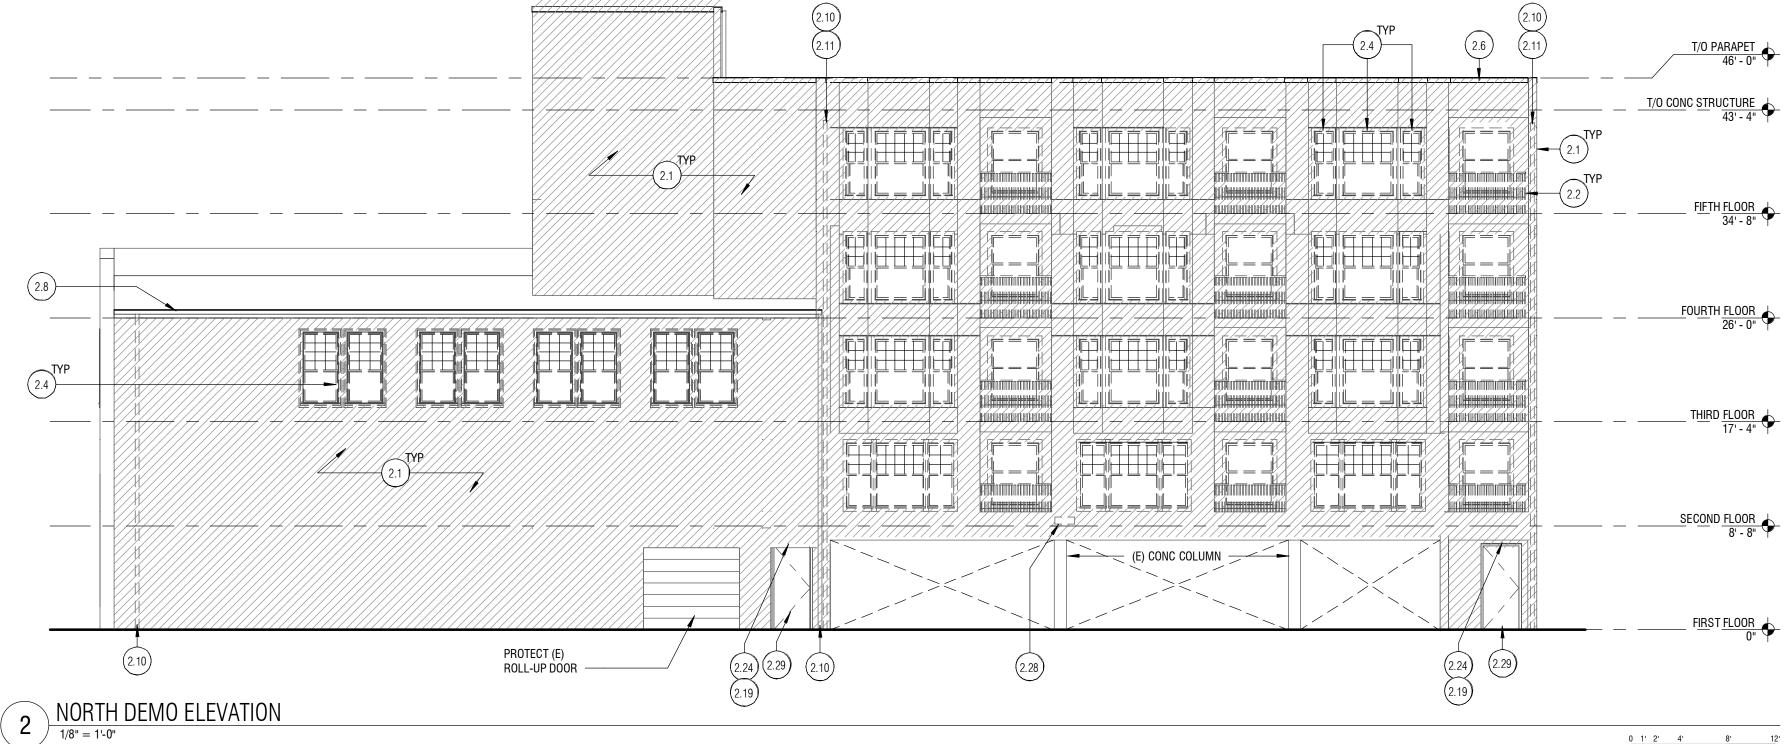



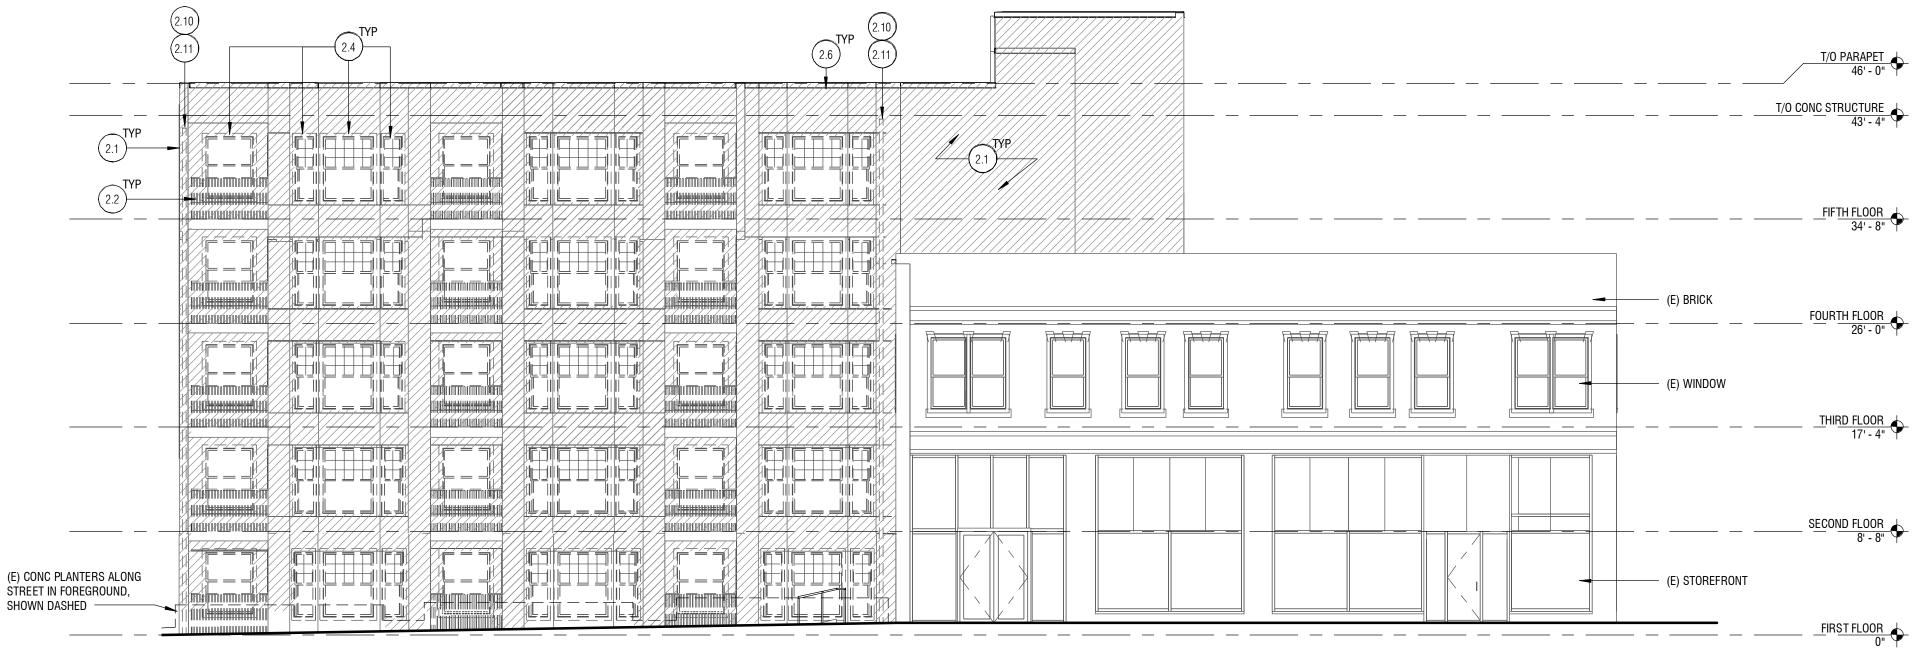

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SH	K S A R C H I T E C T S
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	5158 REGISTERED ARCHITECT
	- JONATHAN H. HARTUNG
	STATE OF WASHINGTON
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	 GUSTAVES MANOR ENVELOPE
	[–] UPGRADE
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	BID SET
	107 W MAIN ST — AUBURN, WA 98001
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	 Drawn by: JI
	Checked: LJ
	Date:03/08/2022 Scale: As indicated
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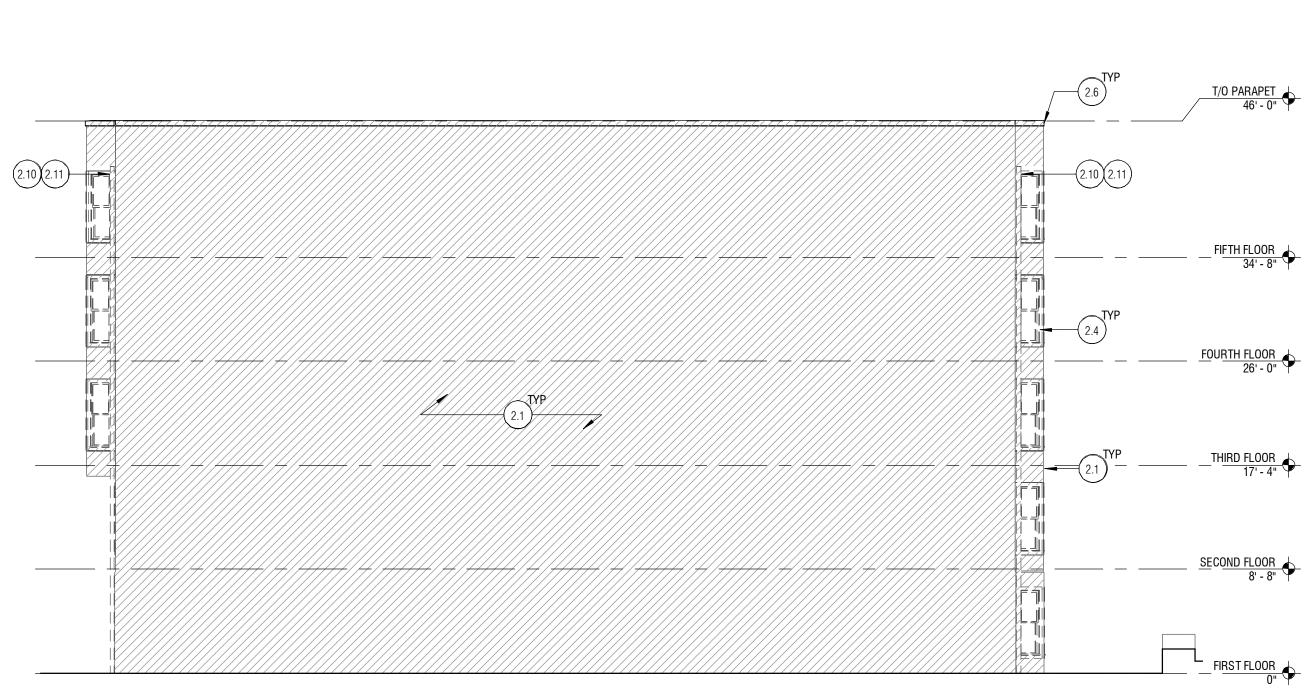
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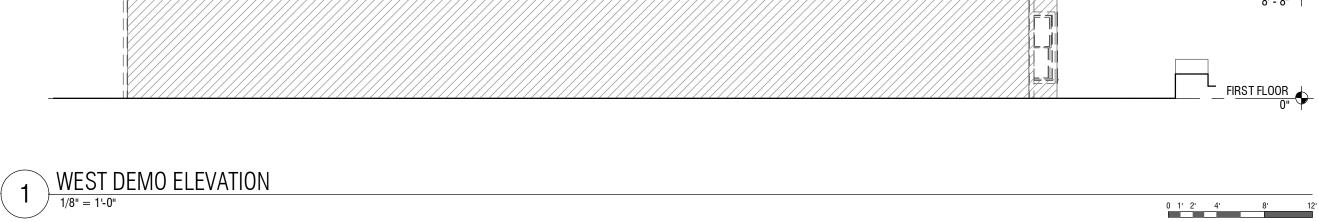
——— Demolish


DEMO (E) STUCCO, (E) WEATHER BARRIER, AND (E) TRIM. (E) SHEATHING, (E) STRUCTURE, (E) INSULATION AND (E) INTERIOR FINISHES TO REMAIN, PROTECT AND COORDINATE REPAIR W/ OWNER, ASSUME 25 SHEETS EXT SHEATHING TO BE REPLACED IN TOTAL

- GENERAL NOTES: 1. COORDINATE REQUIRED SHUTDOWNS WITH OWNER. 2. PROTECT EXISTING LANDSCAPE.
- 3. IF WATER DAMAGE IS OBSERVED IN THE COURSE OF THE PROJECT, NOTIFY OWNER IMMEDIATELY.
- 4. ALL DIMENSIONS ARE APPROXIMATE. VERIFY IN FIELD.

MARK	KEYNOTE TEXT
2.1	DEMO (E) STUCCO SIDING, (E) WEATHER BARRIER, AND (E) TRIM. DAMAGED SHEATHING TO BE REPLACED
2.2	SALVAGE (E) GLASRAIL RAILING. COORDINATE DECK ACCESS AND REQUIREMENTS FOR TEMPORARY RAILINGS WITH KCHA
2.4	Remove (E) Window, (E) exterior and interior trim
2.6	REMOVE (E) METAL COPING AT ROOF PARAPET
2.8	REMOVE (E) GUTTER
2.10	REMOVE (E) DOWNSPOUT
2.11	REMOVE (E) SCUPPER
2.19	SALVAGE (E) SPRINKLER HEAD TO BE REINSTALLED
2.24	REMOVE (E) LIGHT FIXTURE
2.28	SALVAGE (E) SECURITY DEVICE
2.29	Salvage (E) door, (E) door frame, (E) door hardware. Remove (E) interior trim






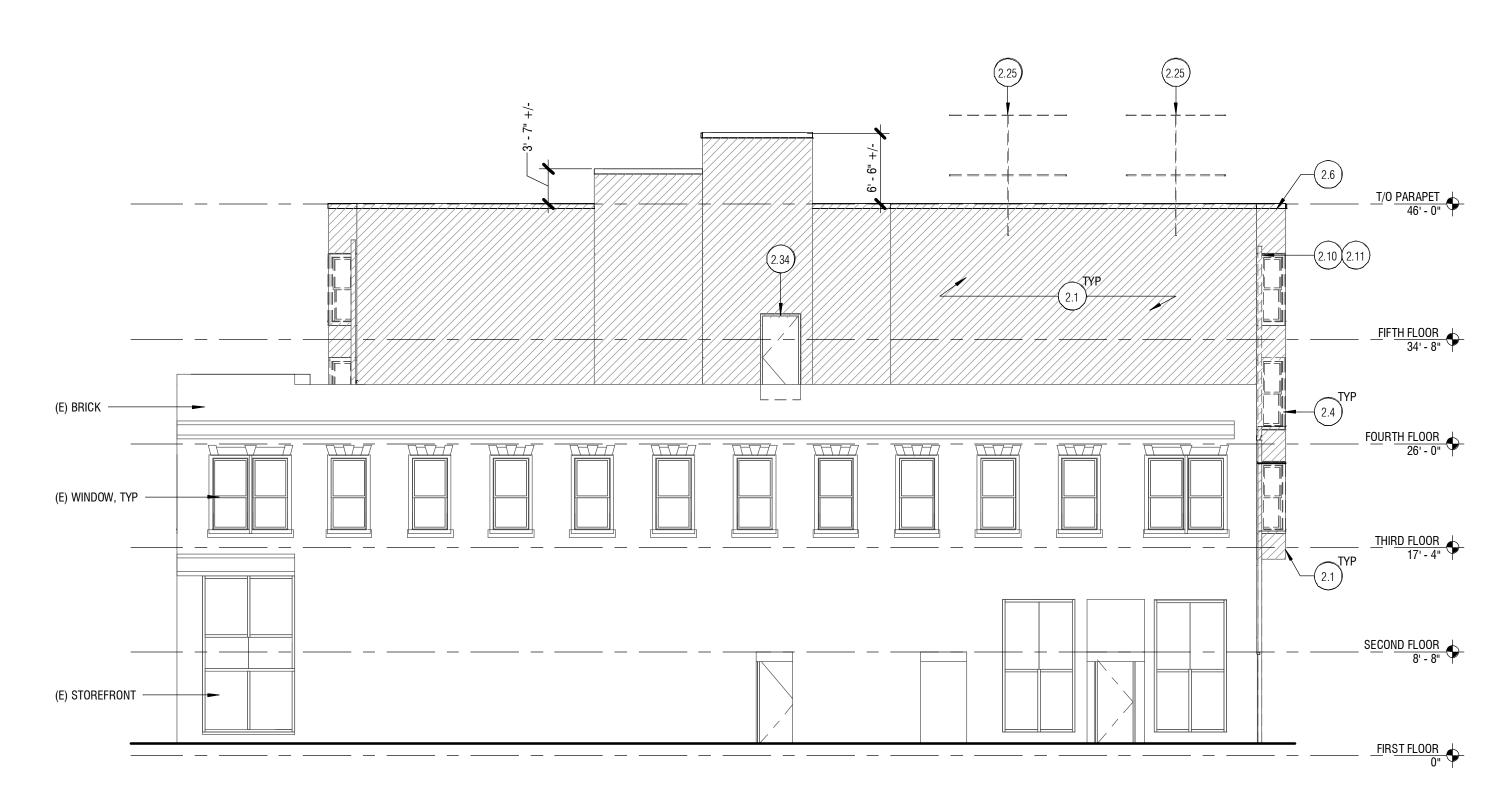





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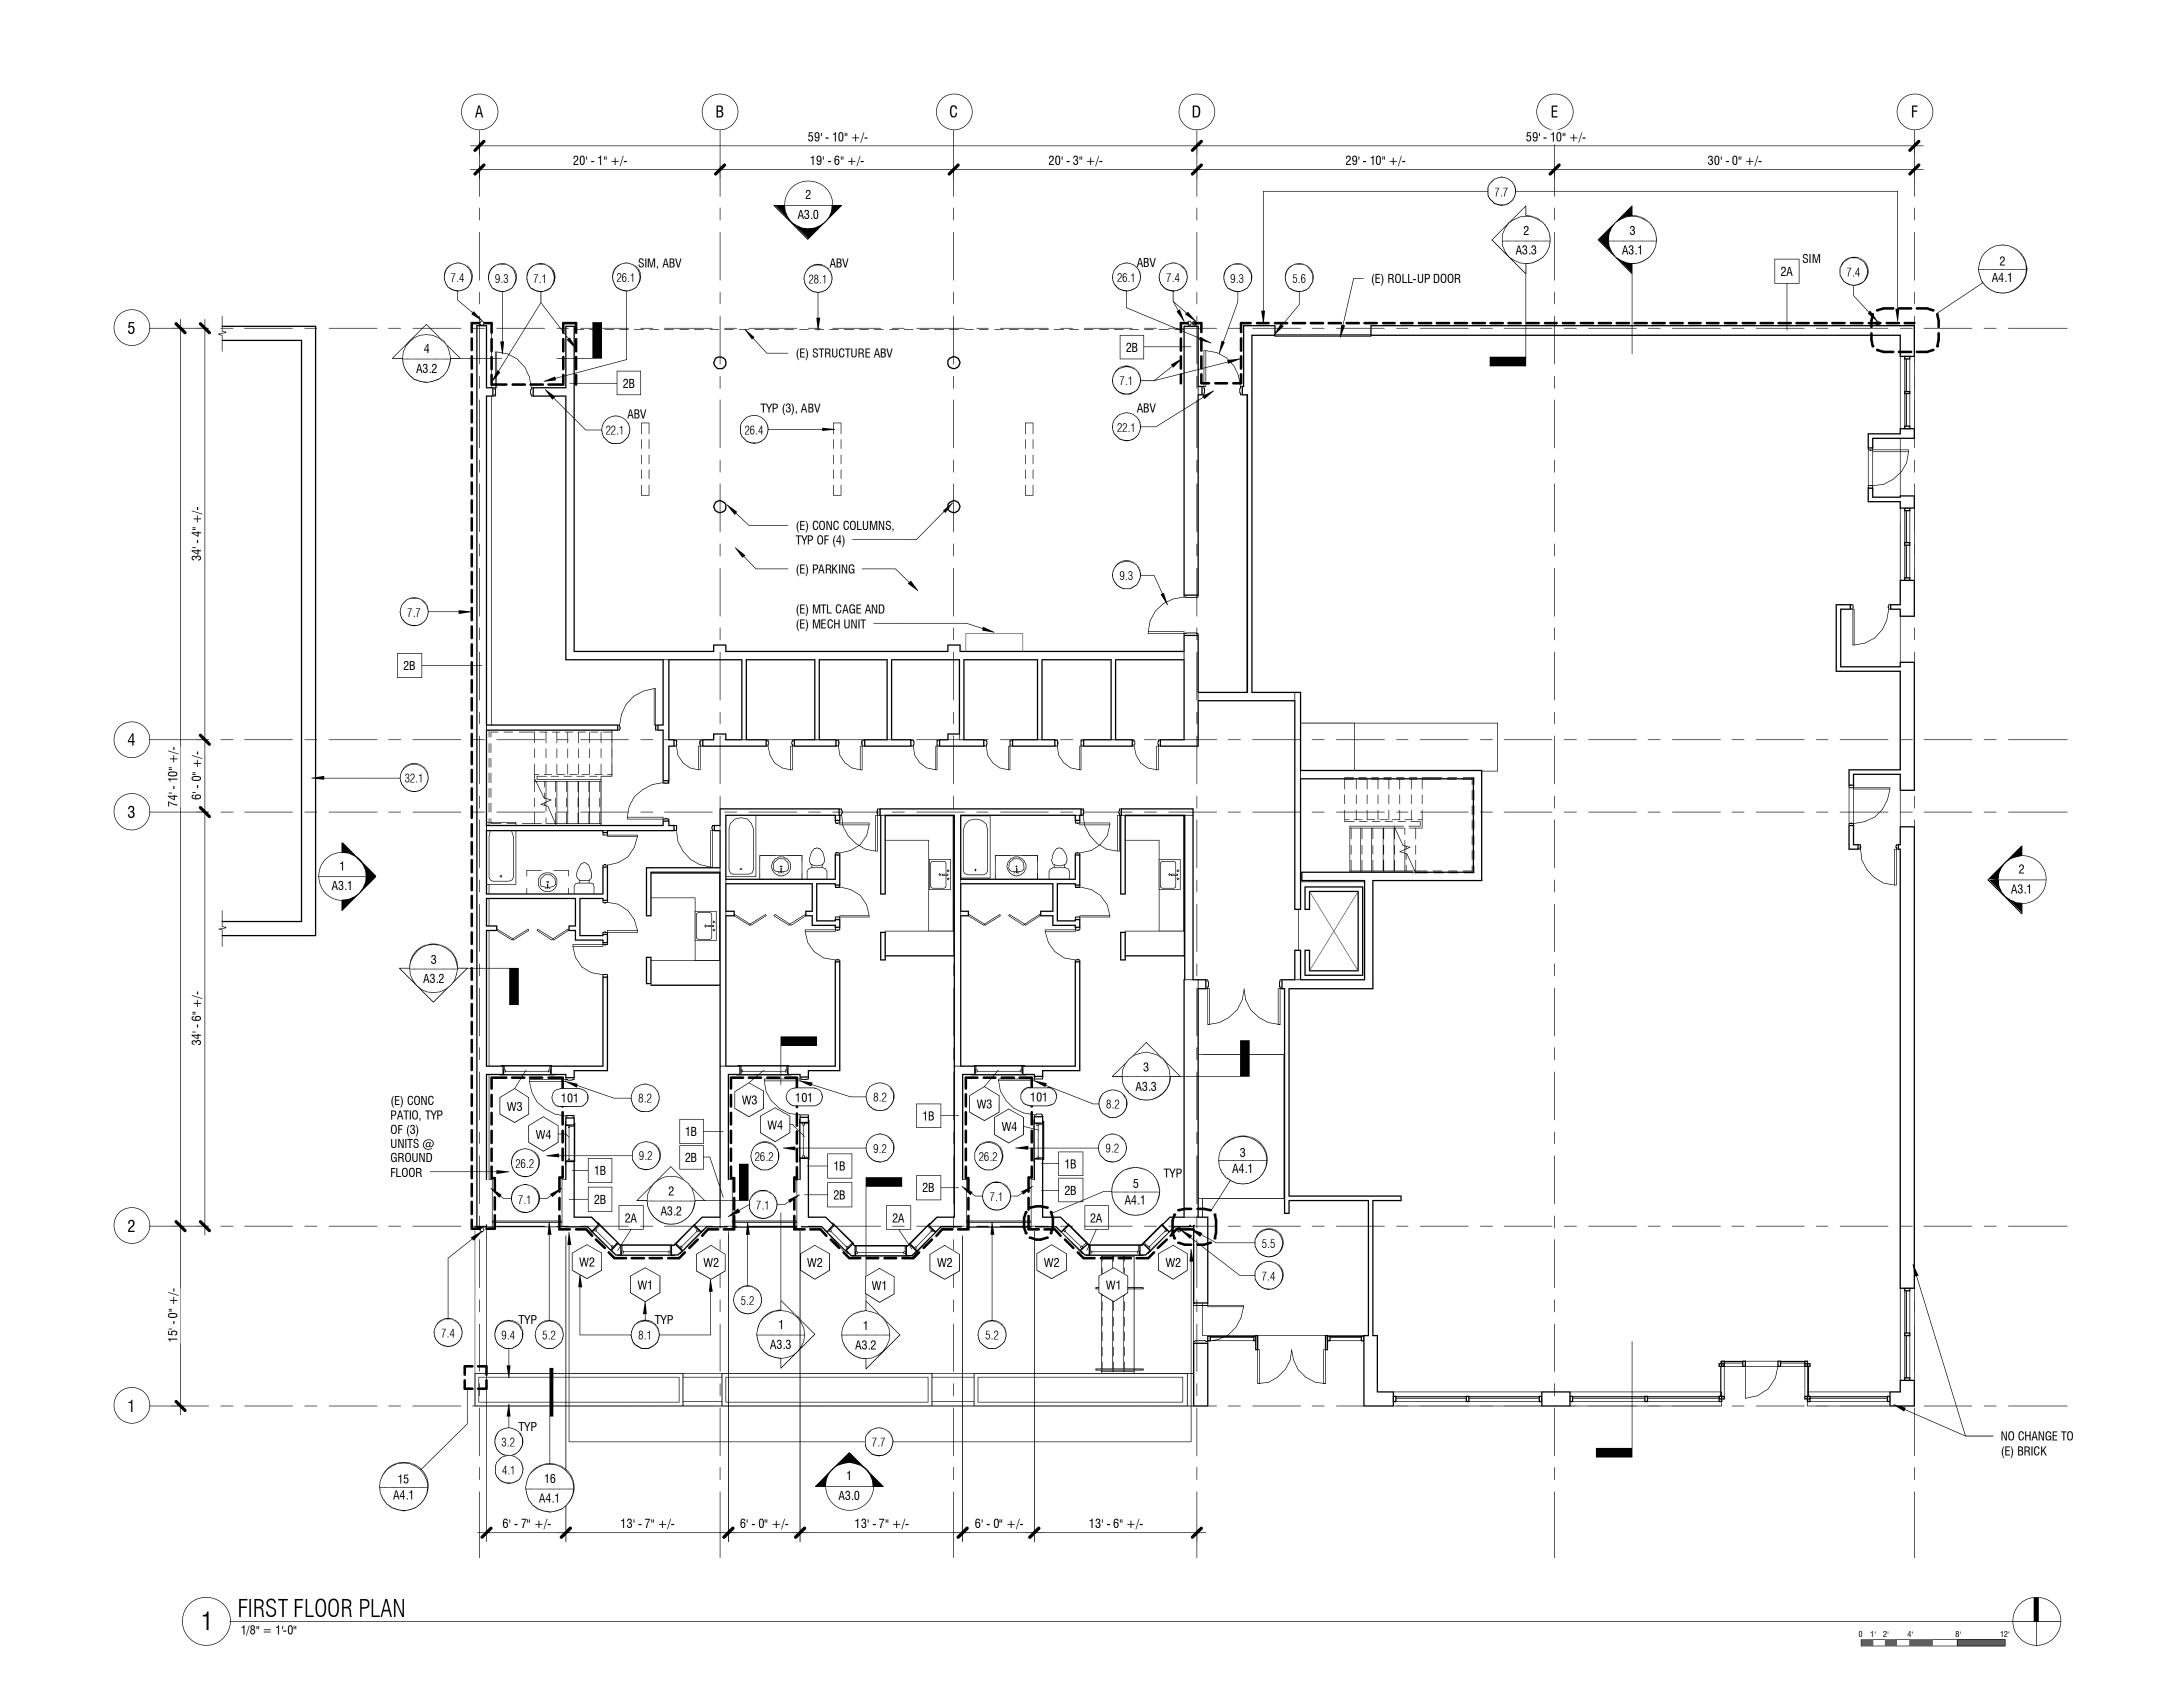
<u>DEMO LEGEND:</u>

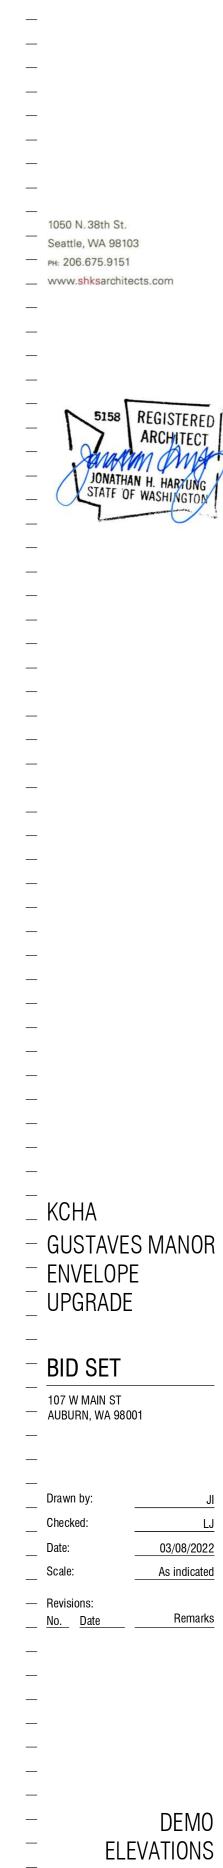——— Demolish

DEMO (E) STUCCO, (E) WEATHER BARRIER, AND (E) TRIM. (E) SHEATHING, (E) STRUCTURE, (E) INSULATION AND (E) INTERIOR FINISHES TO REMAIN, PROTECT AND COORDINATE REPAIR W/ OWNER, ASSUME 25 SHEETS EXT SHEATHING TO BE REPLACED IN TOTAL

- <u>GENERAL NOTES:</u> 1. COORDINATE REQUIRED SHUTDOWNS WITH OWNER. 2. PROTECT EXISTING LANDSCAPE. 3. IF WATER DAMAGE IS OBSERVED IN THE COURSE OF THE PROJECT, NOTIFY OWNER IMMEDIATELY. 4. ALL DIMENSIONS ARE APPROXIMATE. VERIFY IN FIELD.

MARK	KEYNOTE TEXT
2.1	DEMO (E) STUCCO SIDING, (E) WEATHER BARRIER, AND (E) TRIM. DAMAGED SHEATHING TO BE REPLACED
2.4	REMOVE (E) WINDOW, (E) EXTERIOR AND INTERIOR TRIM
2.6	REMOVE (E) METAL COPING AT ROOF PARAPET
2.10	REMOVE (E) DOWNSPOUT
2.11	REMOVE (E) SCUPPER
2.25	REMOVE (E) ANTENNA AND ASSOCIATED CABLE
2.34	SALVAGE (E) MTL DOOR, REMOVE (E) THRESHOLD AND HARDWARE. (E) DOOR FRAME TO REMAIN



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5158 REGISTERED ARCHITECT JONATHAN H. HARTUNG
STATE OF WASHINGTON
 KCHA GUSTAVES MANOR ENVELOPE UPGRADE
Drawn by: JI Checked: LJ Date: 03/08/2022 Scale: As indicated Revisions: No. Date Remarks 1 2.23.22 ASI-01
FIRST FLOOR PLAN

SHKSARCHITECTS

<u>PLAN LEGEND</u>


_____ (E) WALL

WEATHER RESISTANT BARRIER, SIDING AND TRIM PER SIDING ASSEMBLIES ____

GENERAL NOTES: 1. PATCH, REPAIR, AND PAINT INTERIOR GWB DAMAGED DURING CONSTRUCTION.

MARK	KEYNOTE TEXT
3.2	PRECAST CONCRETE CAP AT TOP OF (E) CONCRETE PLANTER, REF 16 / A4.1
4.1	BRICK VENEER AT (E) PLANTER EAST, SOUTH, AND WEST FACES. REF 16 / A4.1
5.2	MODIFY & REINSTALL SALVAGED GLASRAIL RAILING IN EXISTING LOCATION AT (E) CONC DECK
5.5	METAL ANGLE TRIM CAP AT SIDING TERMINATION ADJACENT (E) BRICK BUILDING, WELDED AND PAINTED, REF 3/A4.1 AT FIRST FLOOR AND 4/A4.1 AT OTHER FLOORS
5.6	METAL ANGLE TRIM AT DOOR JAMB AND HEADER OF (E) ROLL-UP DOOR OPENING, WELDED AND PAINTED TO MATCH WINDOW TRIM
7.1	INSTALL WEATHER RESISTANT BARRIER, FURRING, RIGID INSULATION AND FIBER CEMENT SIDING, TYP @ GROUND FLOOR ALCOVES AND ALL UPPER FLOORS, REF WALL ASSEMBLIES 1 / A4.0
7.4	Round Downspout, tie into (E) drain system at grade
7.7	INSTALL WEATHER RESISTANT BARRIER, FURRING, RIGID INSULATION AND BRICK VENEER WITH A PRECAST CONC CAP, TYP AT MAIN GROUND FLOOR FACADE, REF WALL ASSEMBLIES 1 / A4.0
8.1	VINYL WINDOW IN (E) OPENING, REF WINDOW SCHEDULE A4.5
8.2	Unit Balcony door in (E) opening, ref door schedule A4.5
9.2	FLUID APPLIED DECK COATING AT BALCONY, BUILD UP DECK TO SLOPE TO DRAIN AT EXTERIOR EDGE, MIN 1% SLOPE, CONFIRM THRESHOLD ELEVATION CAN ACCOMODATE INCREASED THICKNESS OF DECK, REF 7 / A4.4
9.3	PAINT (E) METAL DOORS AND DOOR FRAMES
9.4	PAINT NORTH FACE OF (E) CONCRETE PLANTER, NO PAINT AT OTHER FACES
22.1	REINSTALL SALVAGED SPRINKLER HEAD, REF 7/A4.1
26.1	BUILDING ENTRY LIGHT FIXTURE AT CLG ABV, REF ELEC
26.2	UNIT LIGHT FIXTURE AT UNDERSIDE OF CONC SLAB ABV, REF ELEC
26.4	LINEAR LIGHT FIXTURE INSTALLED AT (E) LOCATIONS, REF ELEC
28.1	INSTALL SALVAGED SECURITY DEVICE
32.1	MINOR IMPROVEMENTS TO ADJACENT BUILDING WHERE AFFECTED BY SITE DEMOLITION: REPAIR CMU GROUTING, REATTACH ELECTRICAL EQUIPMENT IN (E) LOCATION, PAINT (E) WALL FOUR FEET PAST AFFECTED WALL AREA TO MATCH (E). COORDINATE REPAIRS W/ KCHA



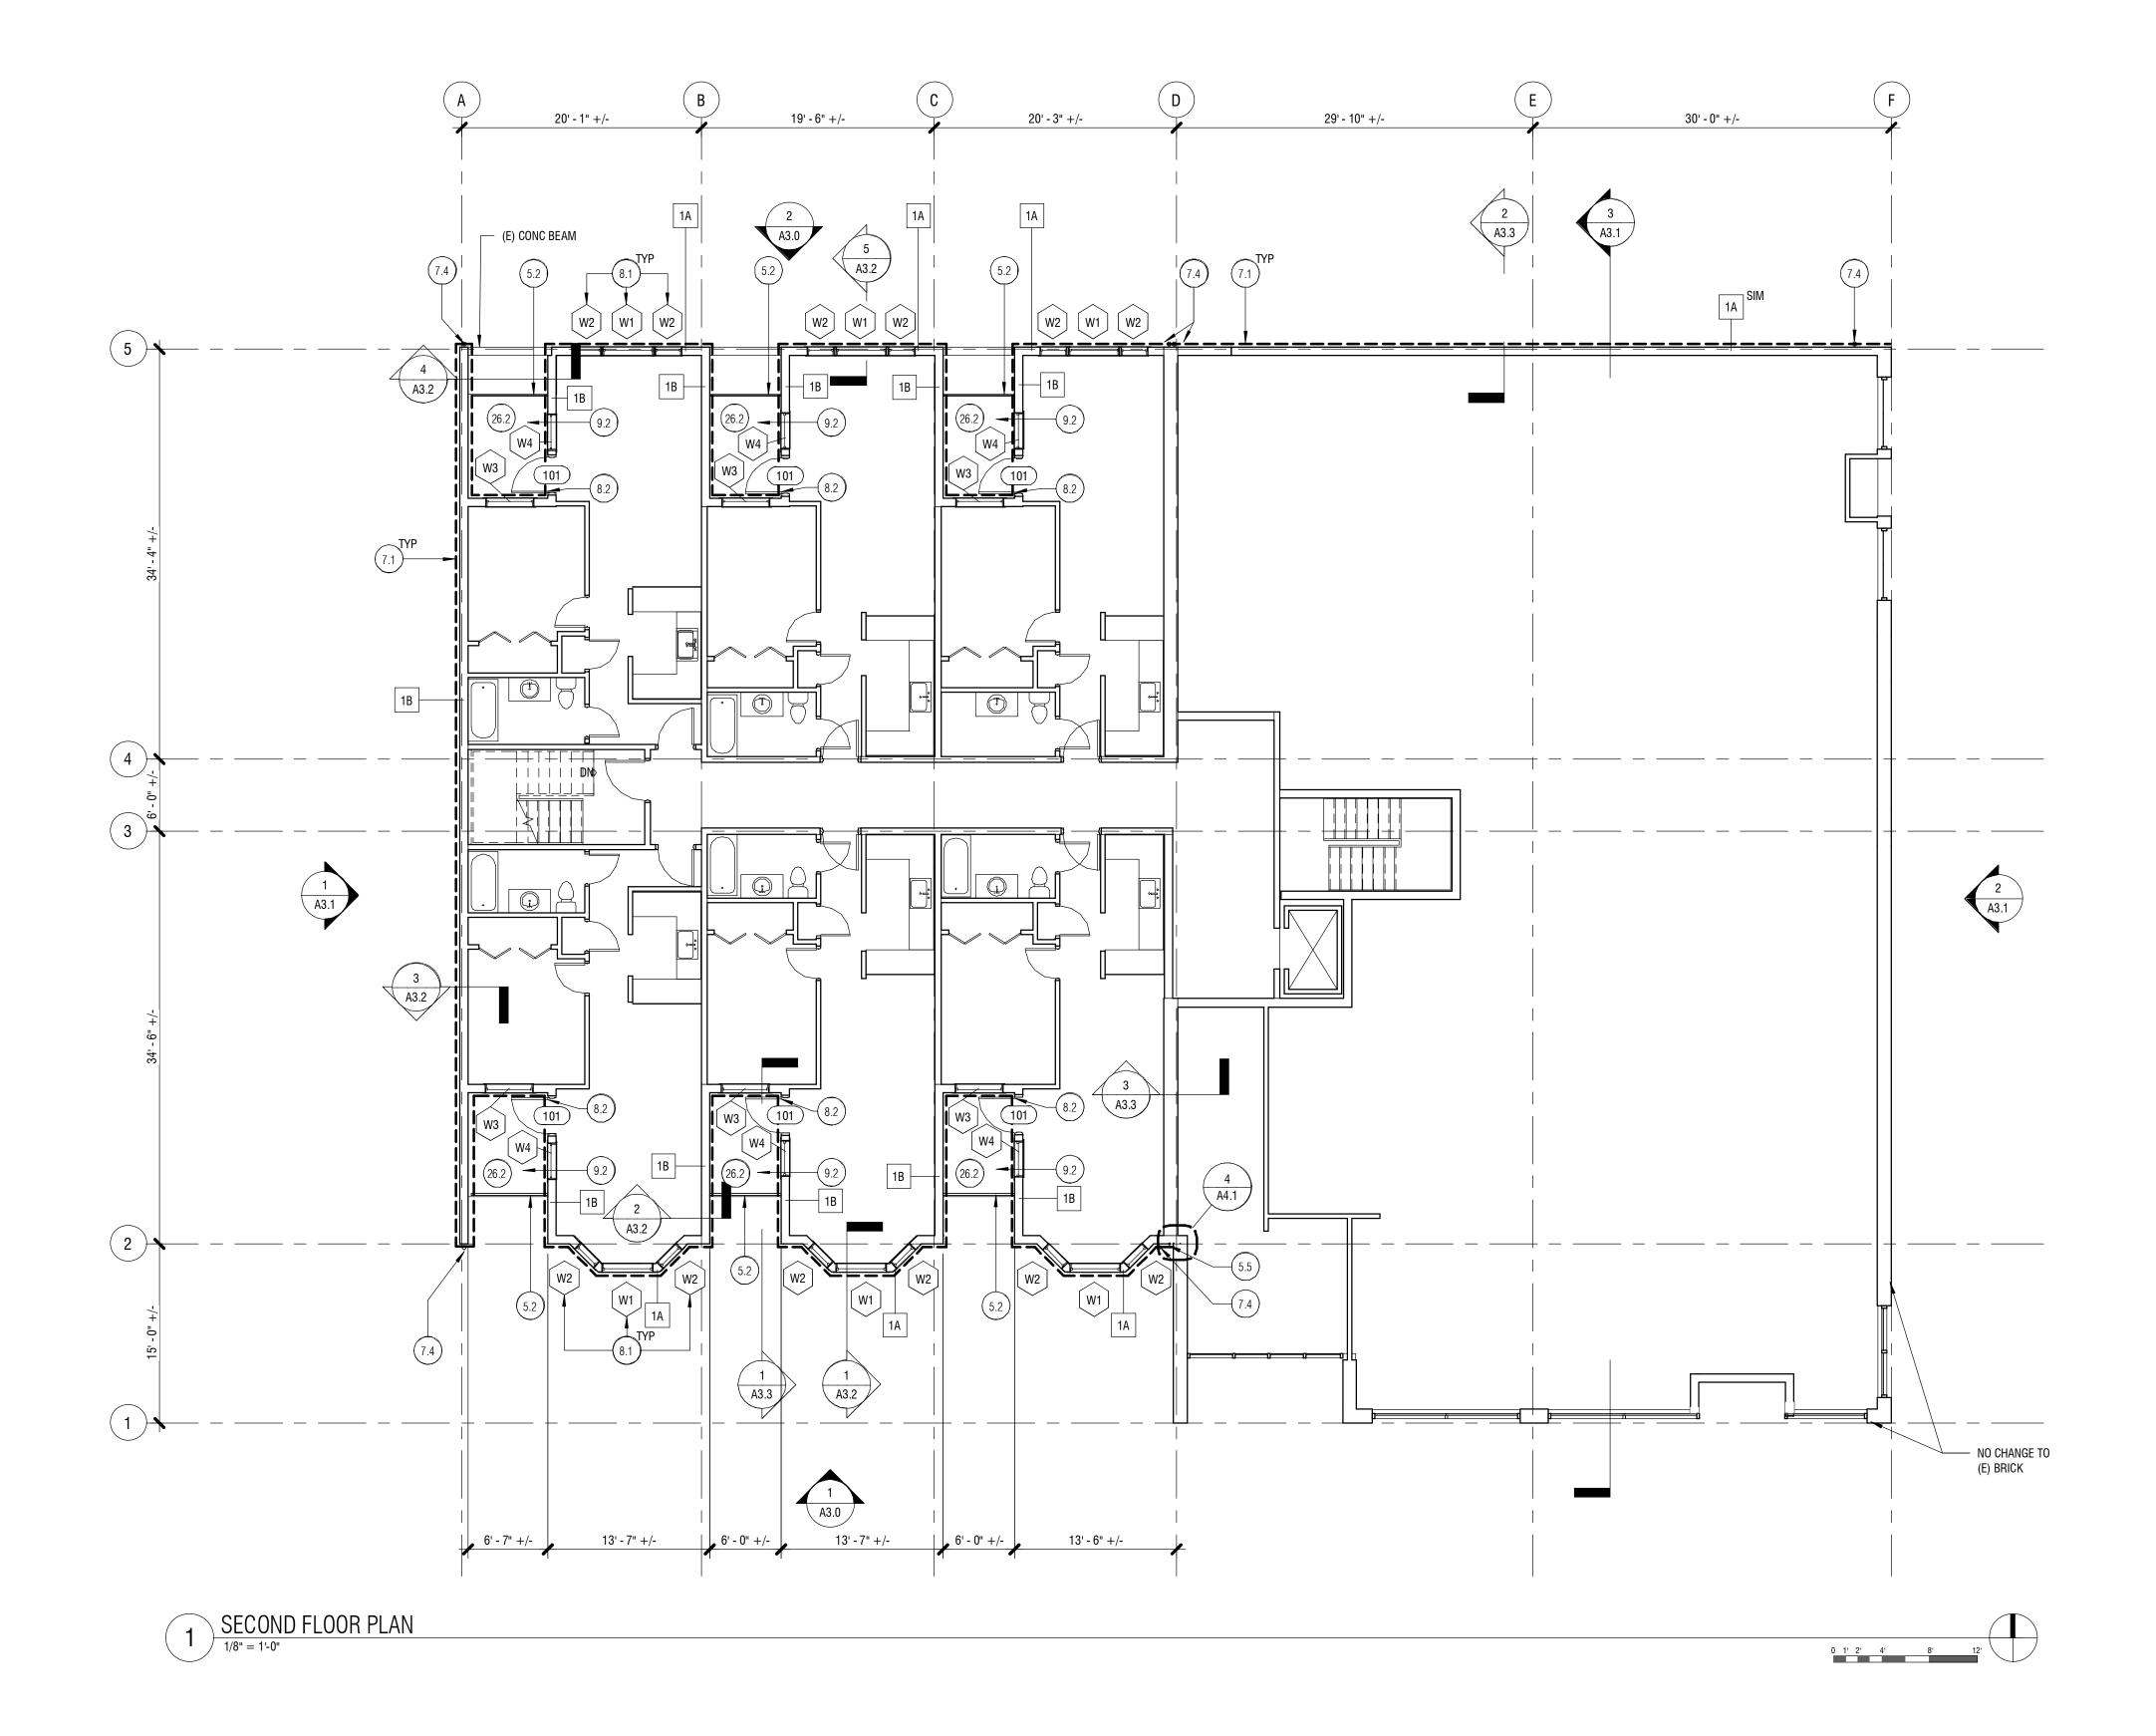


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PLAN LEGEND ______ (E) WALL

WEATHER RESISTANT BARRIER, SIDING AND TRIM PER SIDING ASSEMBLIES ___

GENERAL NOTES: 1. PATCH, REPAIR, AND PAINT INTERIOR GWB DAMAGED DURING CONSTRUCTION.

MARK	KEYNOTE TEXT
5.2	MODIFY & REINSTALL SALVAGED GLASRAIL RAILING IN EXISTING LOCATION AT (E) CONC DECK
5.5	METAL ANGLE TRIM CAP AT SIDING TERMINATION ADJACENT (E) BRICK BUILDING, WELDED AND PAINTED, REF 3/A4.1 AT FIRST FLOOR AND 4/A4.1 AT OTHER FLOORS
7.1	INSTALL WEATHER RESISTANT BARRIER, FURRING, RIGID INSULATION AND FIBER CEMENT SIDING, TYP @ GROUND FLOOR ALCOVES AND ALL UPPER FLOORS, REF WALL ASSEMBLIES 1 / A4.0
7.4	Round Downspout, Tie Into (E) drain system at grade
8.1	VINYL WINDOW IN (E) OPENING, REF WINDOW SCHEDULE A4.5
8.2	UNIT BALCONY DOOR IN (E) OPENING, REF DOOR SCHEDULE A4.5
9.2	FLUID APPLIED DECK COATING AT BALCONY, BUILD UP DECK TO SLOPE TO DRAIN AT EXTERIOR EDGE, MIN 1% SLOPE, CONFIRM THRESHOLD ELEVATION CAN ACCOMODATE INCREASED THICKNESS OF DECK, REF 7 / A4.4
26.2	UNIT LIGHT FIXTURE AT UNDERSIDE OF CONC SLAB ABV, REF ELEC

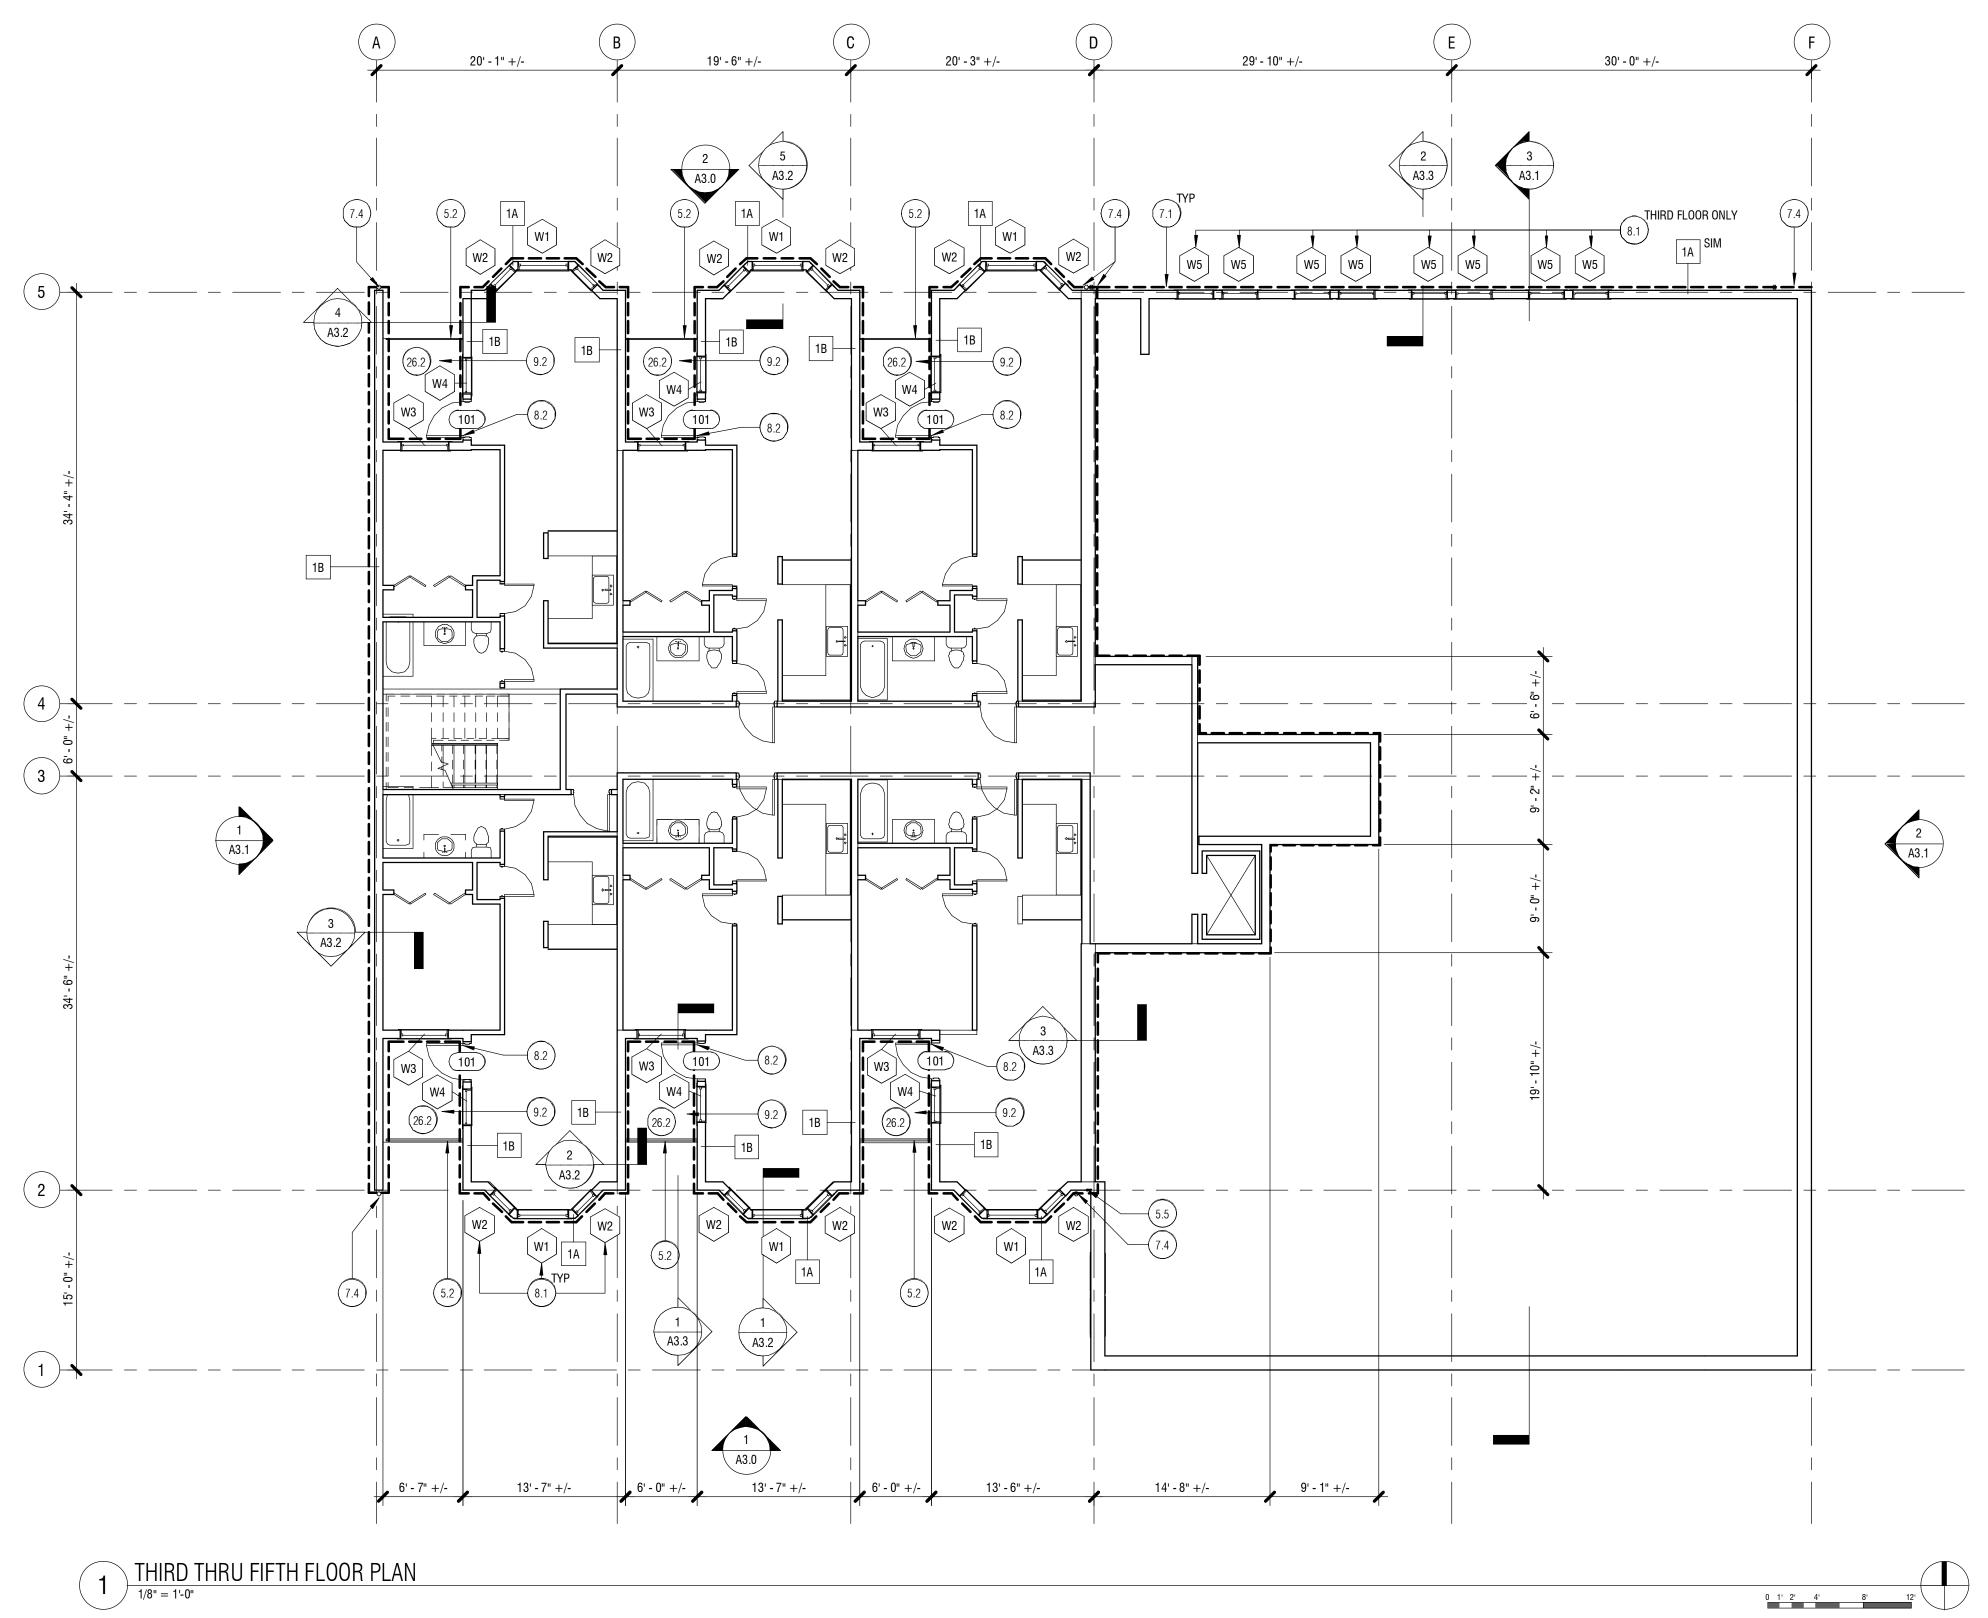

0 1' 2' 4' 8' 12'


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		— AUBURN, WA 98001 —	
		 Drawn by:JI	
		Checked: LJ Date: 03/08/2022	
		Scale: As indicated	
		— Revisions: No. Date Remarks	
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		- THIRD-FIFTH	
		FLOOR PLAN	
		A2.3	

PLAN LEGEND ______ (E) WALL

WEATHER RESISTANT BARRIER, SIDING AND TRIM PER SIDING ASSEMBLIES ____


GENERAL NOTES: 1. PATCH, REPAIR, AND PAINT INTERIOR GWB DAMAGED DURING CONSTRUCTION.

MARK	KEYNOTE TEXT
5.2	MODIFY & REINSTALL SALVAGED GLASRAIL RAILING IN EXISTING LOCATION AT (E) CONC DECK
5.5	METAL ANGLE TRIM CAP AT SIDING TERMINATION ADJACENT (E) BRICK BUILDING, WELDED AND PAINTED, REF 3/A4.1 AT FIRST FLOOR AND 4/A4.1 AT OTHER FLOORS
7.1	INSTALL WEATHER RESISTANT BARRIER, FURRING, RIGID INSULATION AND FIBER CEMENT SIDING, TYP @ GROUND FLOOR ALCOVES AND ALL UPPER FLOORS, REF WALL ASSEMBLIES 1 / A4.0
7.4	Round Downspout, TIE INTO (E) DRAIN SYSTEM AT GRADE
8.1	VINYL WINDOW IN (E) OPENING, REF WINDOW SCHEDULE A4.5
8.2	UNIT BALCONY DOOR IN (E) OPENING, REF DOOR SCHEDULE A4.5
9.2	FLUID APPLIED DECK COATING AT BALCONY, BUILD UP DECK TO SLOPE TO DRAIN AT EXTERIOR EDGE, MIN 1% SLOPE, CONFIRM THRESHOLD ELEVATION CAN ACCOMODATE INCREASED THICKNESS OF DECK, REF 7 / A4.4
26.2	UNIT LIGHT FIXTURE AT UNDERSIDE OF CONC SLAB ABV, REF ELEC

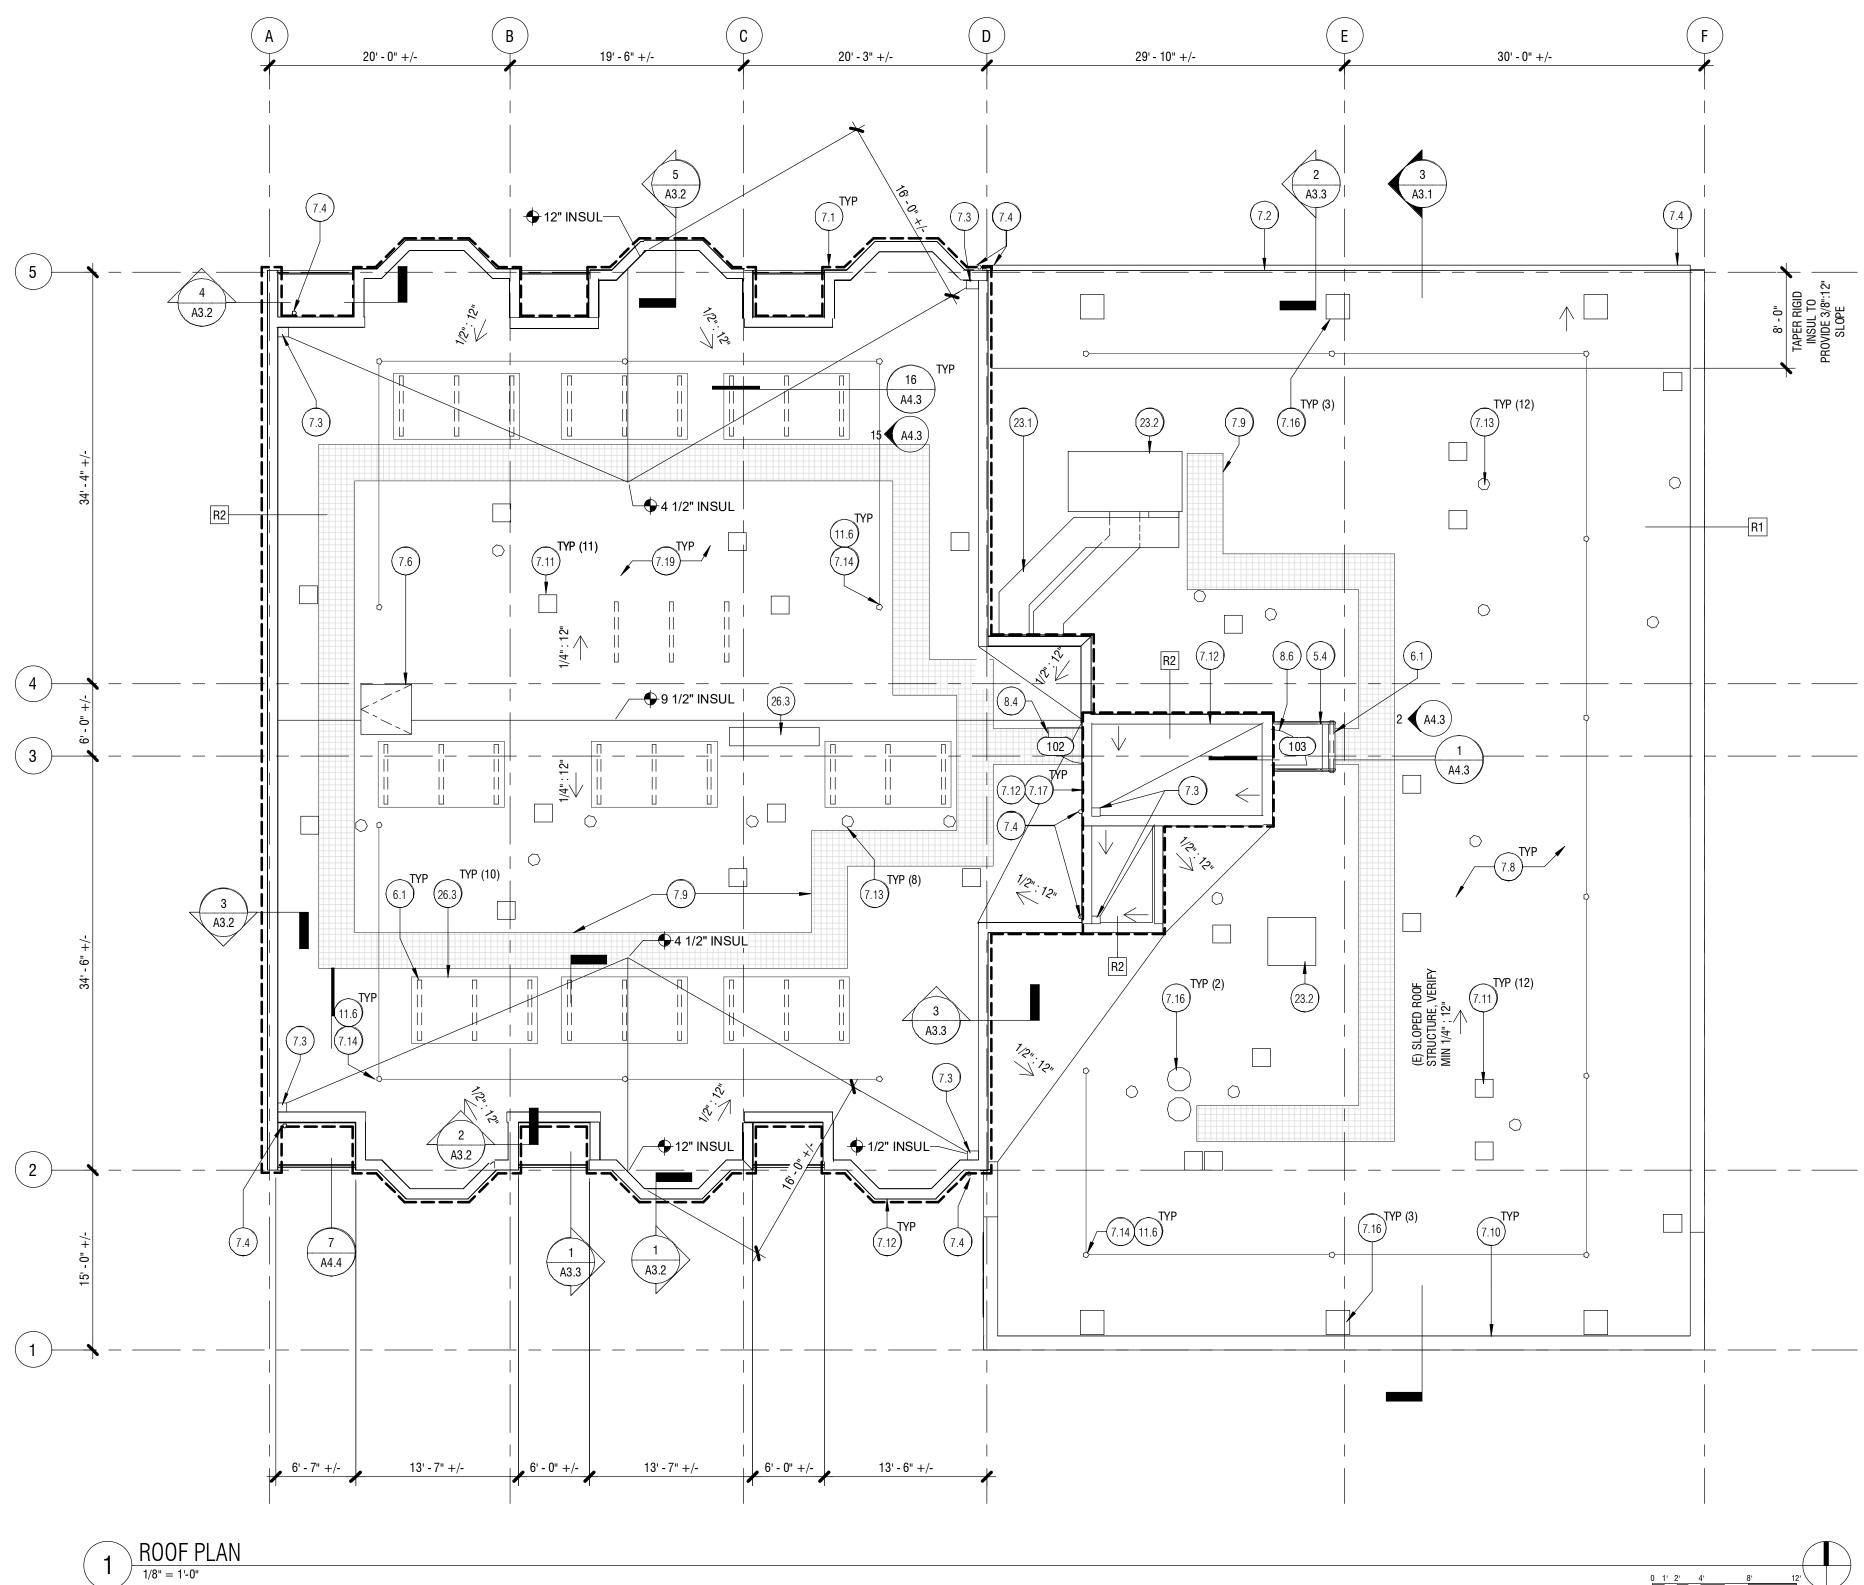

0 1' 2' 4' 8' 12'

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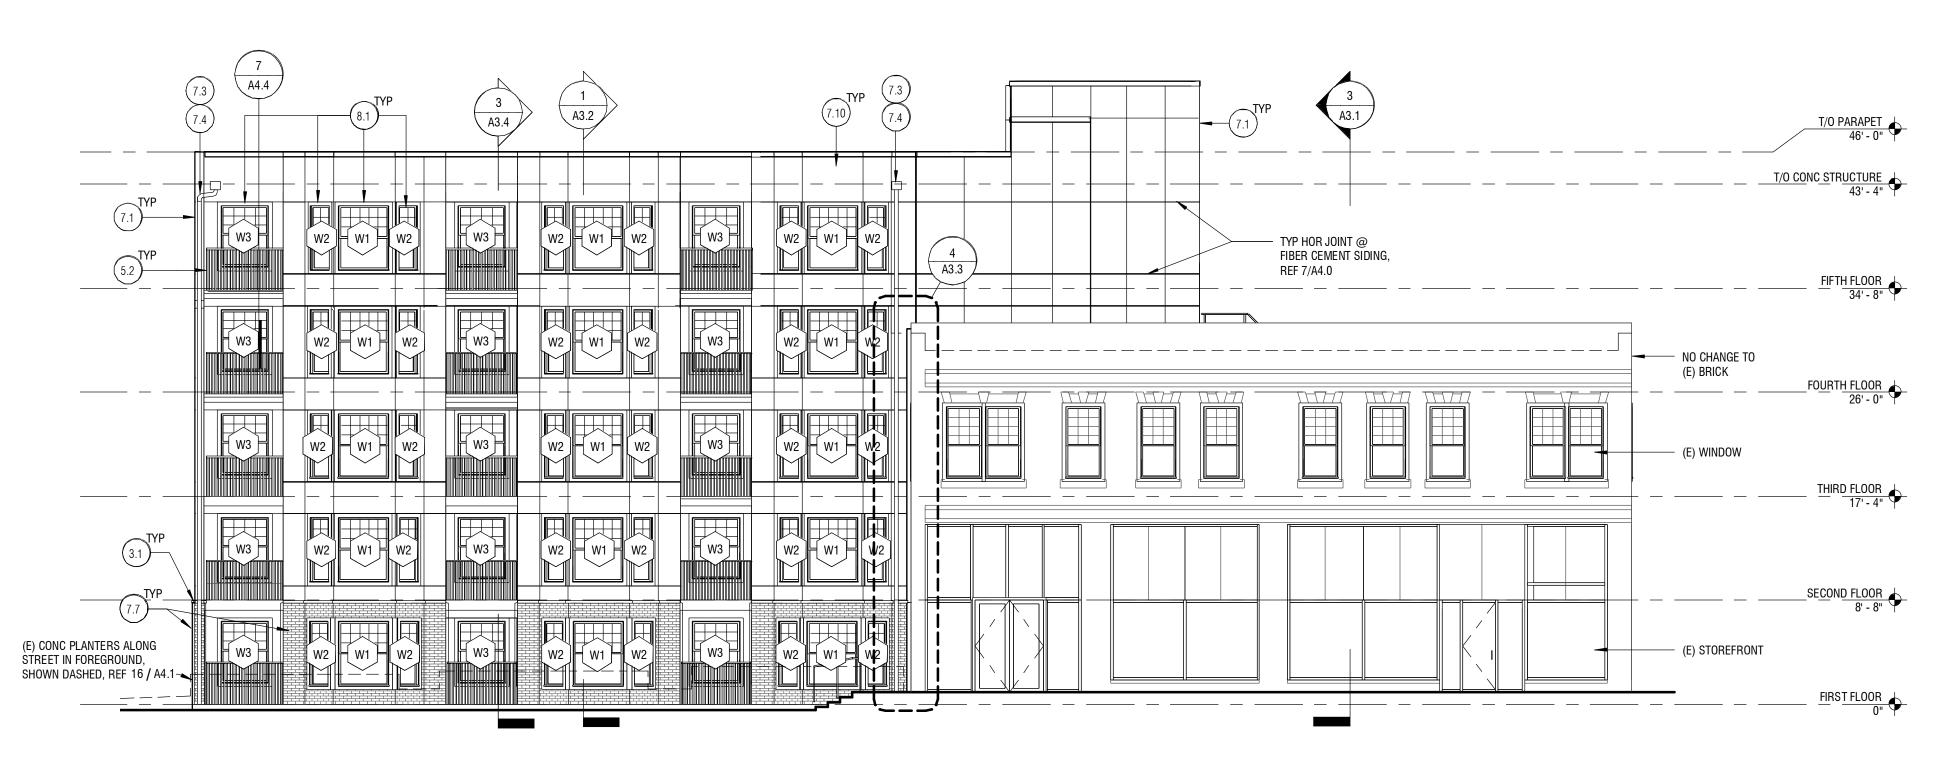


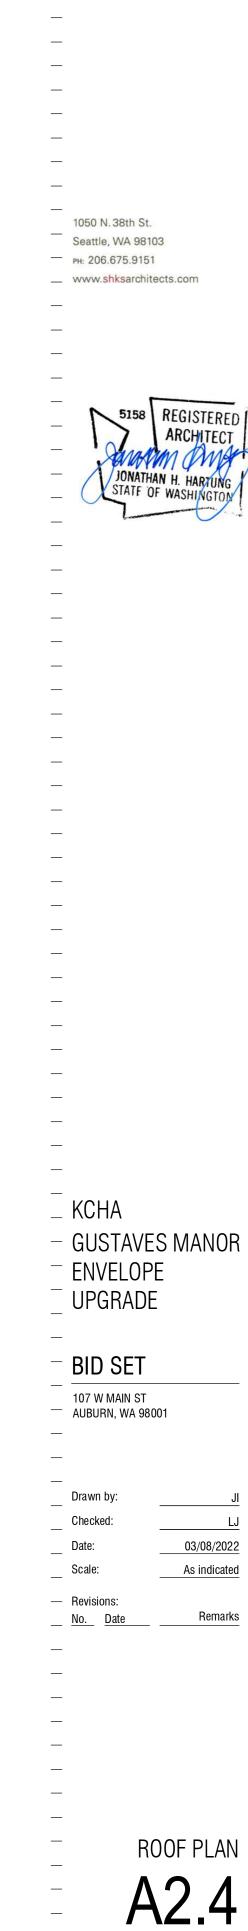PLAN LEGEND ______ (E) WALL


WEATHER RESISTANT BARRIER, SIDING AND TRIM PER SIDING ASSEMBLIES

GENERAL NOTES: 1. PATCH, REPAIR, AND PAINT INTERIOR GWB DAMAGED DURING CONSTRUCTION.

MARK	KEYNOTE TEXT
5.4	PRE-FABRICATED METAL STAIR ASSEMBLY TO COMPLY WITH OSHA STANDARDS, REF 1 & 2 & 3 & 4 / A4.3
6.1	PT WOOD CURB FASTENED TO (E) ROOF STRUCTURE. WRAP ROOF MEMBRANE OVER CURB, COVER W/ MTL COPING, SET ALL FASTENERS TO CURB IN SEALANT
7.1	INSTALL WEATHER RESISTANT BARRIER, FURRING, RIGID INSULATION AND FIBER CEMENT SIDING, TYP @ GROUND FLOOR ALCOVES AND ALL UPPER FLOORS, REF WALL ASSEMBLIES 1 / A4.0
7.2	METAL GUTTER, REF 15 / A4.2
7.3	THROUGH-WALL SCUPPER AND CONDUCTOR IN (E) LOCATION, REF 12 / A4.2
7.4	ROUND DOWNSPOUT, TIE INTO (E) DRAIN SYSTEM AT GRADE
7.6	REINSTALL (E) ROOF HATCH, ADD PT WOOD BLOCKING AT (E) OPENING AS NEEDED TO MAINTAIN MINIMUM 8" CLEARANCE FROM TOP OF ROOF TO TOP OF ROOF HATCH CURB
7.8	LOWER ROOF ASSEMBLY R1, REF 1 / A4.2
7.9	TPO WALKWAY, INSTALL PER MANUFACTURER'S INSTRUCTIONS
7.10	METAL COPING W/ DRIP EDGE @ R1 LOWER ROOF, REF 11 / A4.2
7.11	METAL VENT CAP
7.12	METAL COPING W/ DRIP EDGE @ R2 UPPER ROOF, REF 12 / A4.2
7.13	TPO FLASHING AT (E) PLUMBING VENT, REF 8 / A4.2
7.14	TPO FLASHING AT FALL PROTECTION ANCHOR, REF 4 / A4.2
7.16	INSTALL SALVAGED VENT CAP, REF 7 / A4.2
7.17	METAL FLASHING AT (E) WALL-TO-ROOF BASE, REF 14 / A4.2
7.19	UPPER ROOF ASSEMBLY R2, REF 1 / A4.2
8.4	INSTALL METAL THRESHOLD AND METAL DOOR WITH HARDWARE IN (E) DOOR FRAME
8.6	INSTALL METAL THRESHOLD, CUT SALVAGED METAL DOOR TO FIT REVISED OPENING AND INSTALL W/ HARDWARE IN (E) DOOR FRAME
11.6	FALL ARREST SYSTEM INSTALLED PER MANUFACTURER, REF 4 / A4.2
23.1	BIDDER-DESIGNED INSULATED DUCTWORK FROM SALVAGED UNIT TO (E) DUCT PENETRATIONS. PROVIDE ADEQUATE CLEARANCE AROUND (E) PLUMBING VENTS AND (E) ROOF PENETRATIONS
23.2	INSTALL SALVAGED MECH UNIT, CONDUIT, AND WIRING
26.3	WORK PERFORMED BY OTHERS: INSTALL SALVAGED PHOTOVOLTAIC PANELS, ASSOCIATED ELECTRICAL PANELS, CONDUIT AND WIRING, REF 13 / A4.3




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							 7/0 CONC STRUCTURE 43' - 4"
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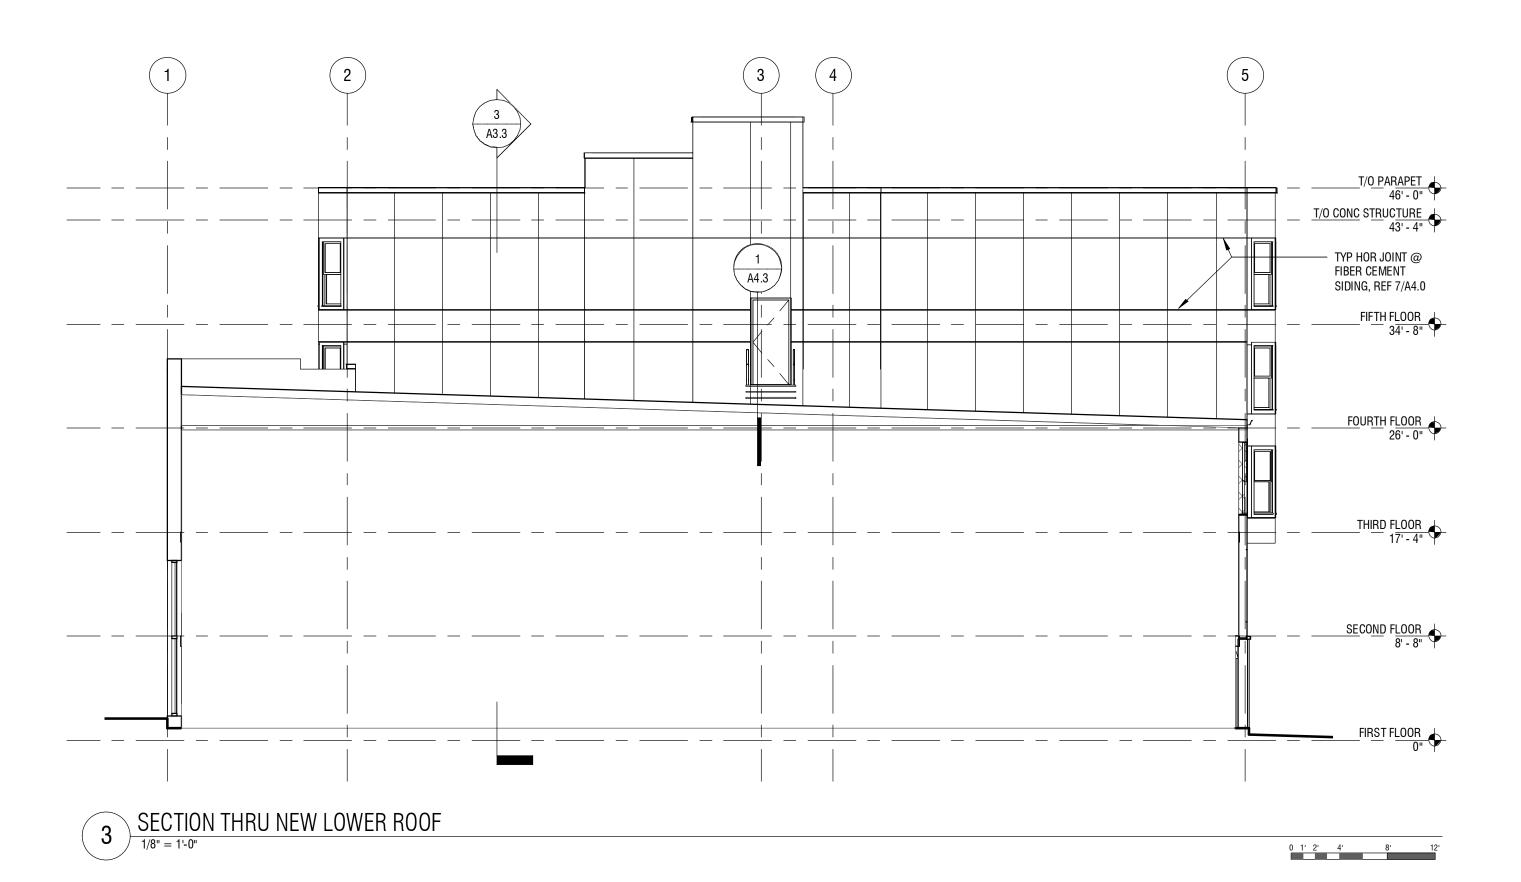
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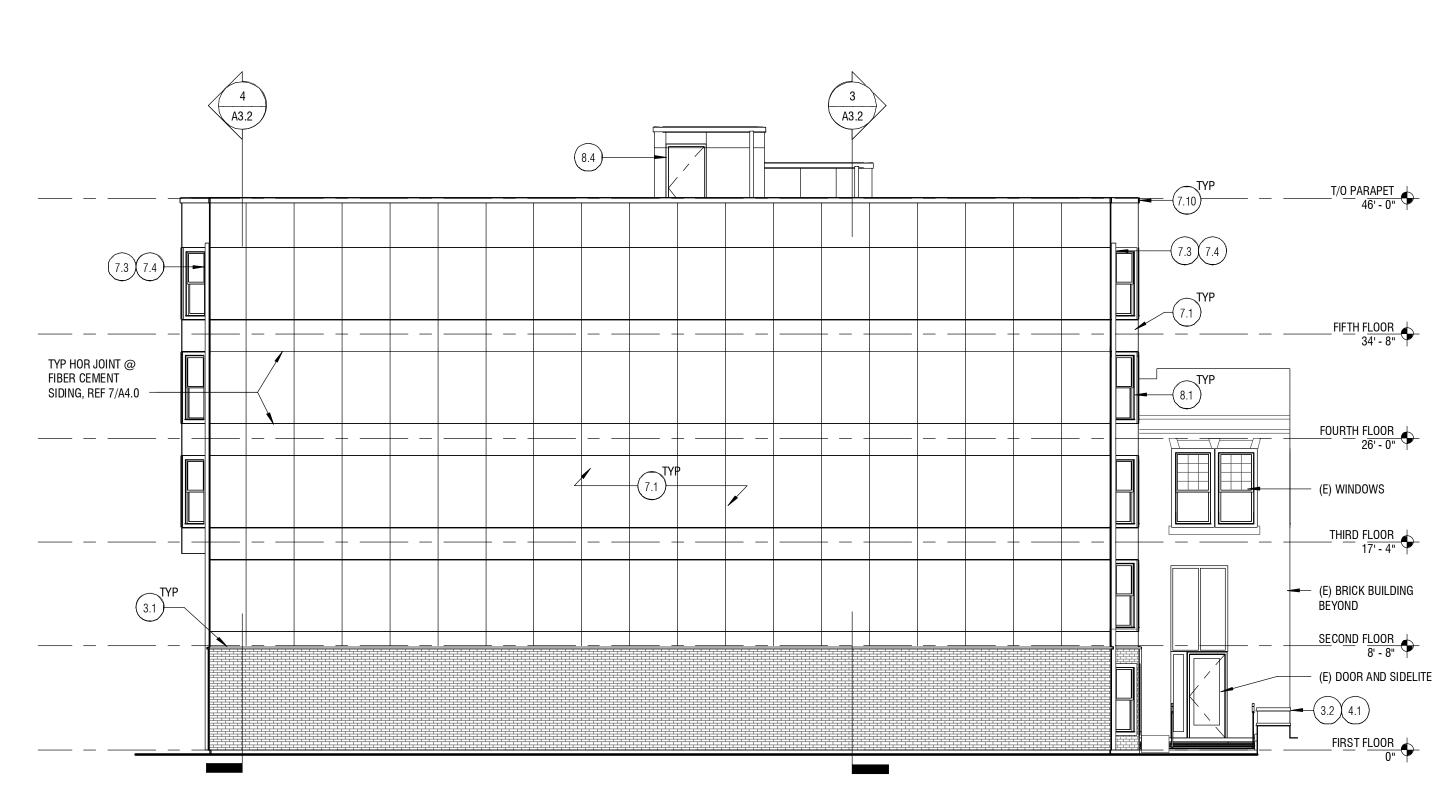

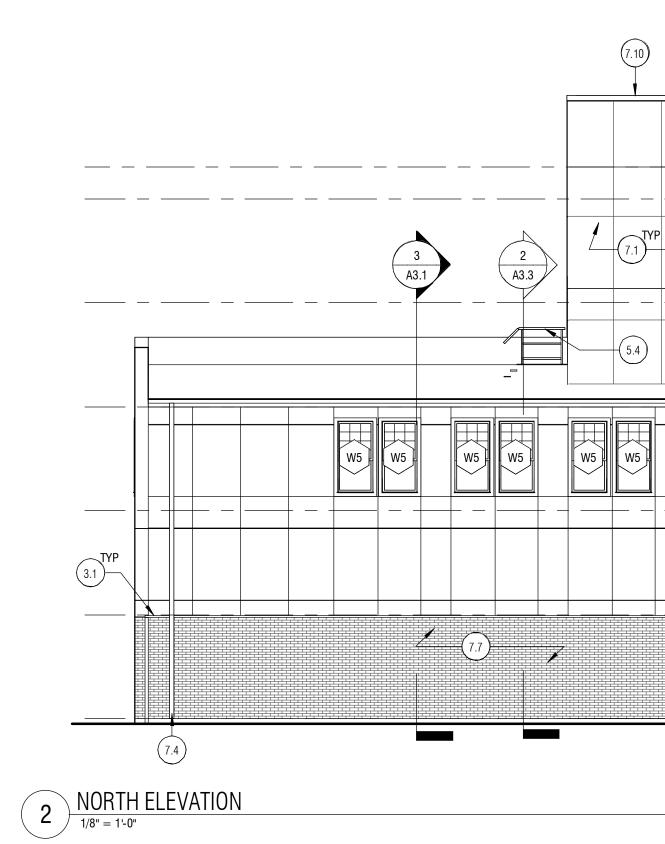
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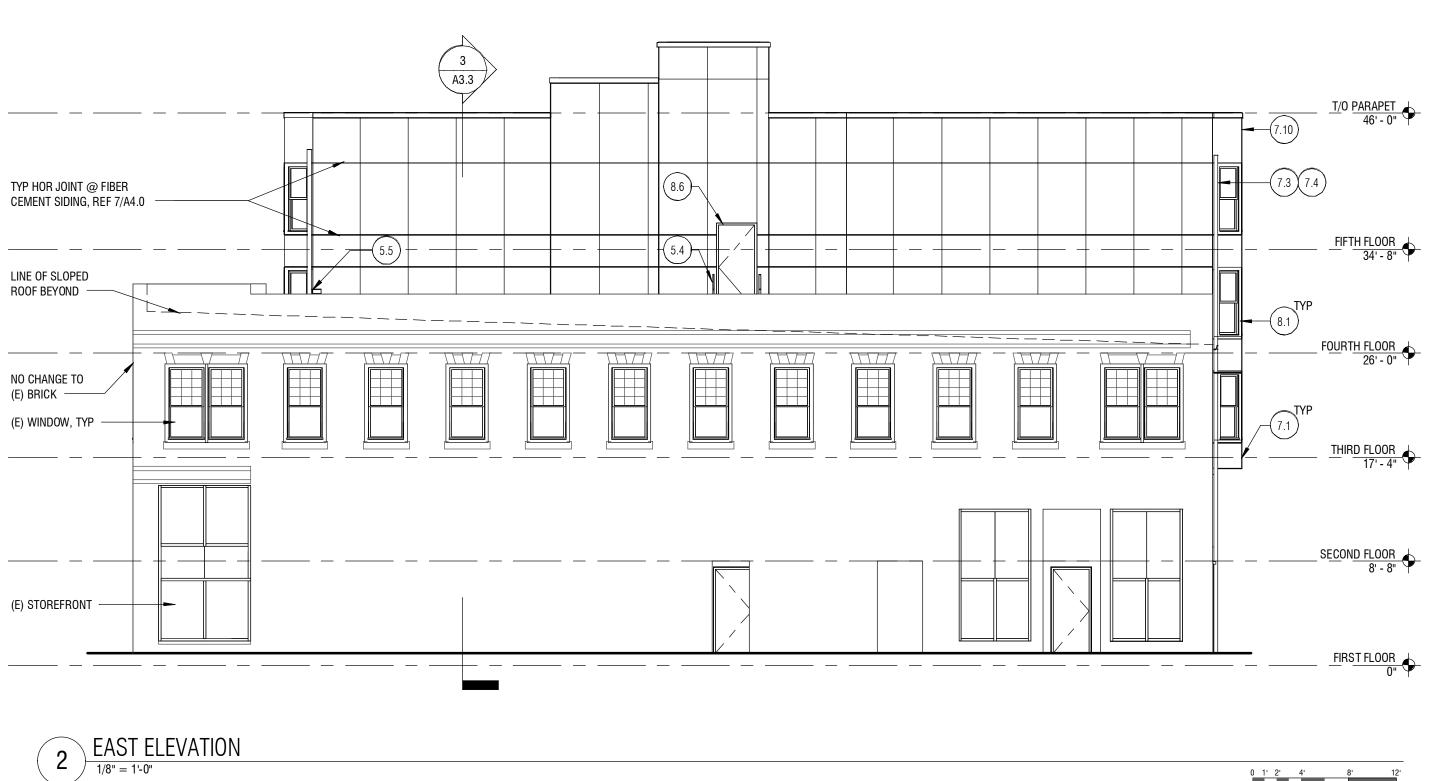
A3.0

MARK	KEYNOTE TEXT
3.1	PRECAST CONCRETE SILL AT TRANSITION BETWEEN FIBER CEMENT PANEL AND BRIC VENEER, REF 11 / A4.0
5.2	MODIFY & REINSTALL SALVAGED GLASRAIL RAILING IN EXISTING LOCATION AT (E) CONC DECK
5.4	PRE-FABRICATED METAL STAIR ASSEMBLY TO COMPLY WITH OSHA STANDARDS, RE 1 & 2 & 3 & 4 / A4.3
5.6	METAL ANGLE TRIM AT DOOR JAMB AND HEADER OF (E) ROLL-UP DOOR OPENING, WELDED AND PAINTED TO MATCH WINDOW TRIM
7.1	INSTALL WEATHER RESISTANT BARRIER, FURRING, RIGID INSULATION AND FIBER CEMENT SIDING, TYP @ GROUND FLOOR ALCOVES AND ALL UPPER FLOORS, REF WALL ASSEMBLIES 1 / A4.0
7.3	THROUGH-WALL SCUPPER AND CONDUCTOR IN (E) LOCATION, REF 12 / A4.2
7.4	ROUND DOWNSPOUT, TIE INTO (E) DRAIN SYSTEM AT GRADE
7.7	INSTALL WEATHER RESISTANT BARRIER, FURRING, RIGID INSULATION AND BRICK VENEER WITH A PRECAST CONC CAP, TYP AT MAIN GROUND FLOOR FACADE, REF WALL ASSEMBLIES $1\/$ A4.0
7.10	Metal Coping W/ Drip Edge @ R1 Lower Roof, Ref 11 / A4.2
8.1	VINYL WINDOW IN (E) OPENING, REF WINDOW SCHEDULE A4.5
8.3	PAINT (E) DOOR AND REINSTALL IN (E) LOCATION WITH (E) HARDWARE
22.1	REINSTALL SALVAGED SPRINKLER HEAD, REF 7/A4.1
26.1	BUILDING ENTRY LIGHT FIXTURE AT CLG ABV, REF ELEC
28.1	INSTALL SALVAGED SECURITY DEVICE





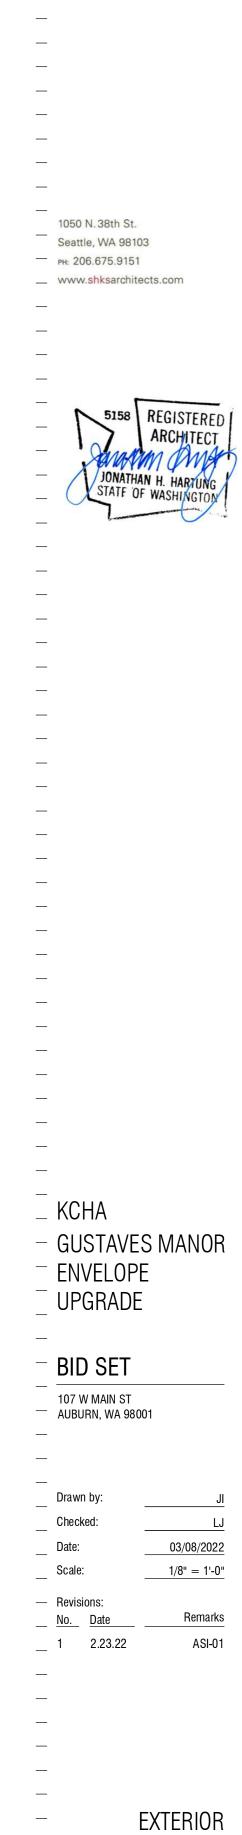



0 1' 2' 4' 8' 12'



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Seattle, WA 98103

www.shksarchitects.com

рн: 206.675.9151



0 1' 2' 4' 8'

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_ KCHA

⁻ ENVELOPE

UPGRADE

- BID SET

___ Drawn by:

Date:

Scale:

Revisions:

<u>No.</u>

Date

Checked:

107 W MAIN ST — AUBURN, WA 98001

- GUSTAVES MANOR

LJ

03/08/2022

1/8" = 1'-0"

EXTERIOR


ELEVATIONS &


BLDG SECTION

A3.'

Remarks

MARK	KEYNOTE TEXT
3.1	PRECAST CONCRETE SILL AT TRANSITION BETWEEN FIBER CEMENT PANEL AND BRICK VENEER, REF 11 / A4.0
3.2	PRECAST CONCRETE CAP AT TOP OF (E) CONCRETE PLANTER, REF 16 / A4.1
4.1	BRICK VENEER AT (E) PLANTER EAST, SOUTH, AND WEST FACES. REF 16 / A4.1
5.4	PRE-FABRICATED METAL STAIR ASSEMBLY TO COMPLY WITH OSHA STANDARDS, REF 1 & 2 & 3 & 4 / A4.3
5.5	METAL ANGLE TRIM CAP AT SIDING TERMINATION ADJACENT (E) BRICK BUILDING, WELDED AND PAINTED, REF 3/A4.1 AT FIRST FLOOR AND 4/A4.1 AT OTHER FLOORS
7.1	INSTALL WEATHER RESISTANT BARRIER, FURRING, RIGID INSULATION AND FIBER CEMENT SIDING, TYP @ GROUND FLOOR ALCOVES AND ALL UPPER FLOORS, REF WALL ASSEMBLIES 1 / A4.0
7.3	Through-Wall Scupper and conductor in (E) location, Ref 12 / A4.2
7.4	ROUND DOWNSPOUT, TIE INTO (E) DRAIN SYSTEM AT GRADE
7.10	METAL COPING W/ DRIP EDGE @ R1 LOWER ROOF, REF 11 / A4.2
8.1	VINYL WINDOW IN (E) OPENING, REF WINDOW SCHEDULE A4.5
8.4	INSTALL METAL THRESHOLD AND METAL DOOR WITH HARDWARE IN (E) DOOR FRAME
8.6	INSTALL METAL THRESHOLD, CUT SALVAGED METAL DOOR TO FIT REVISED OPENING AND INSTALL W/ HARDWARE IN (E) DOOR FRAME

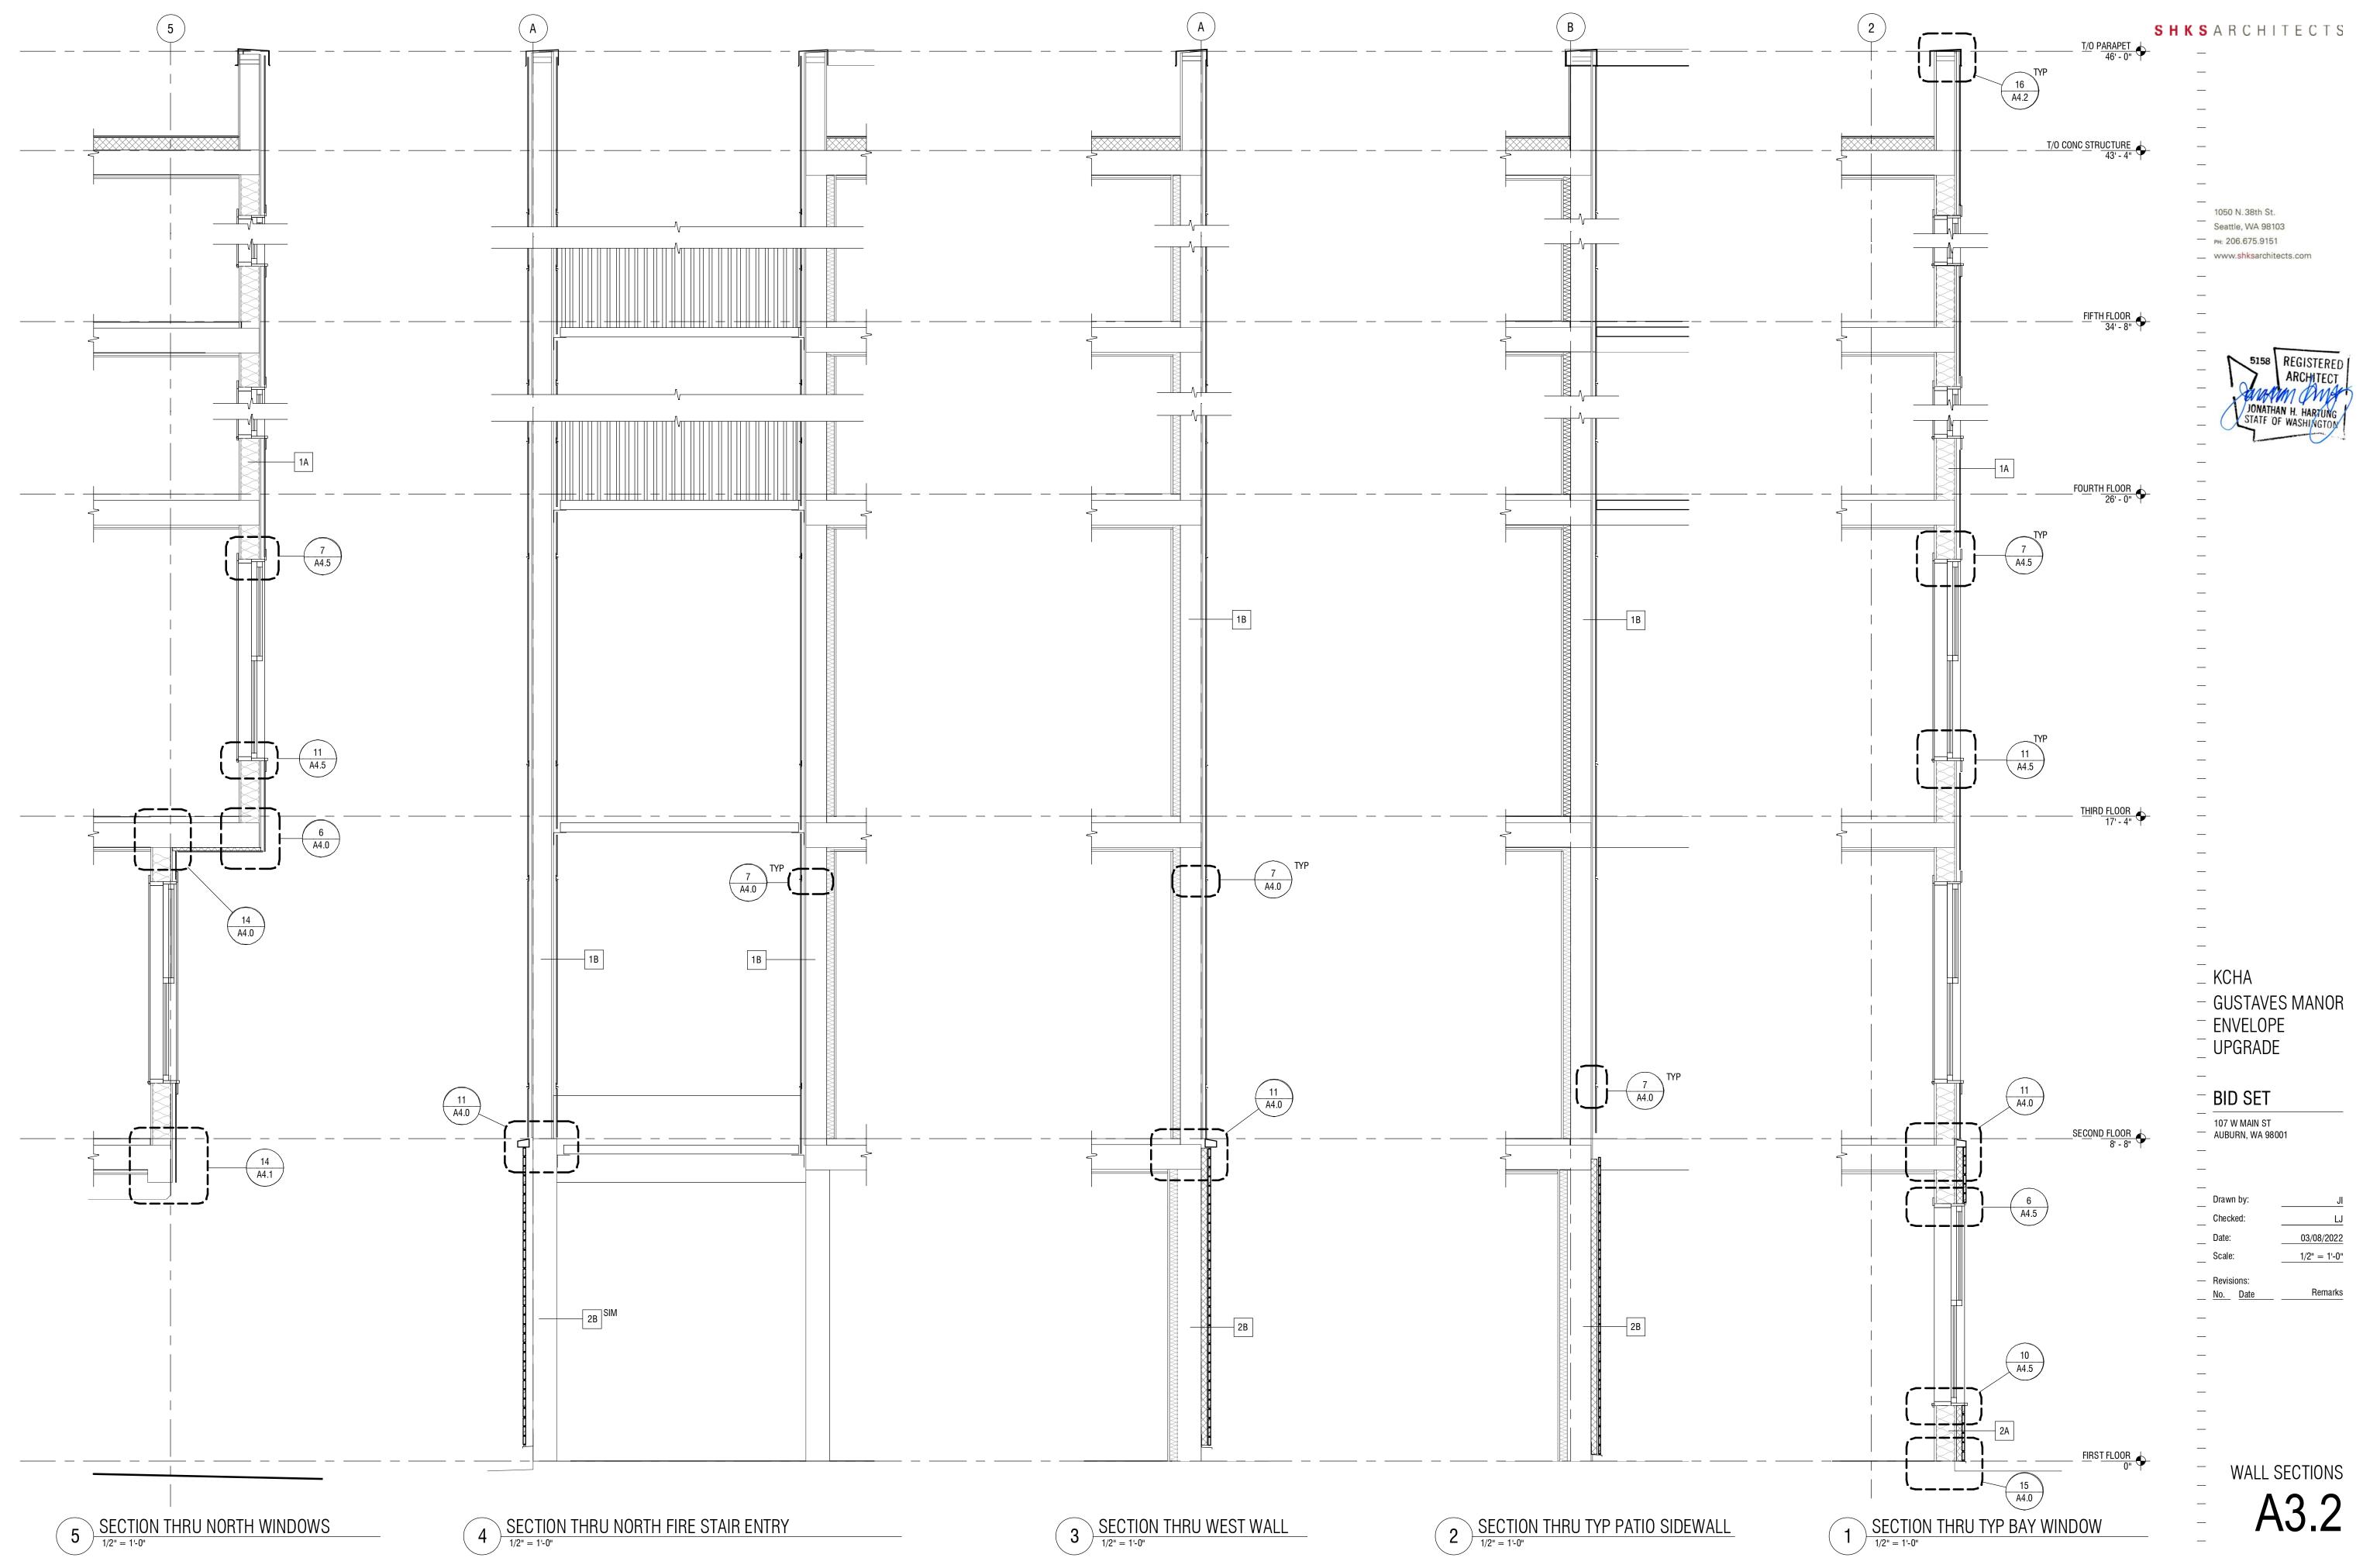

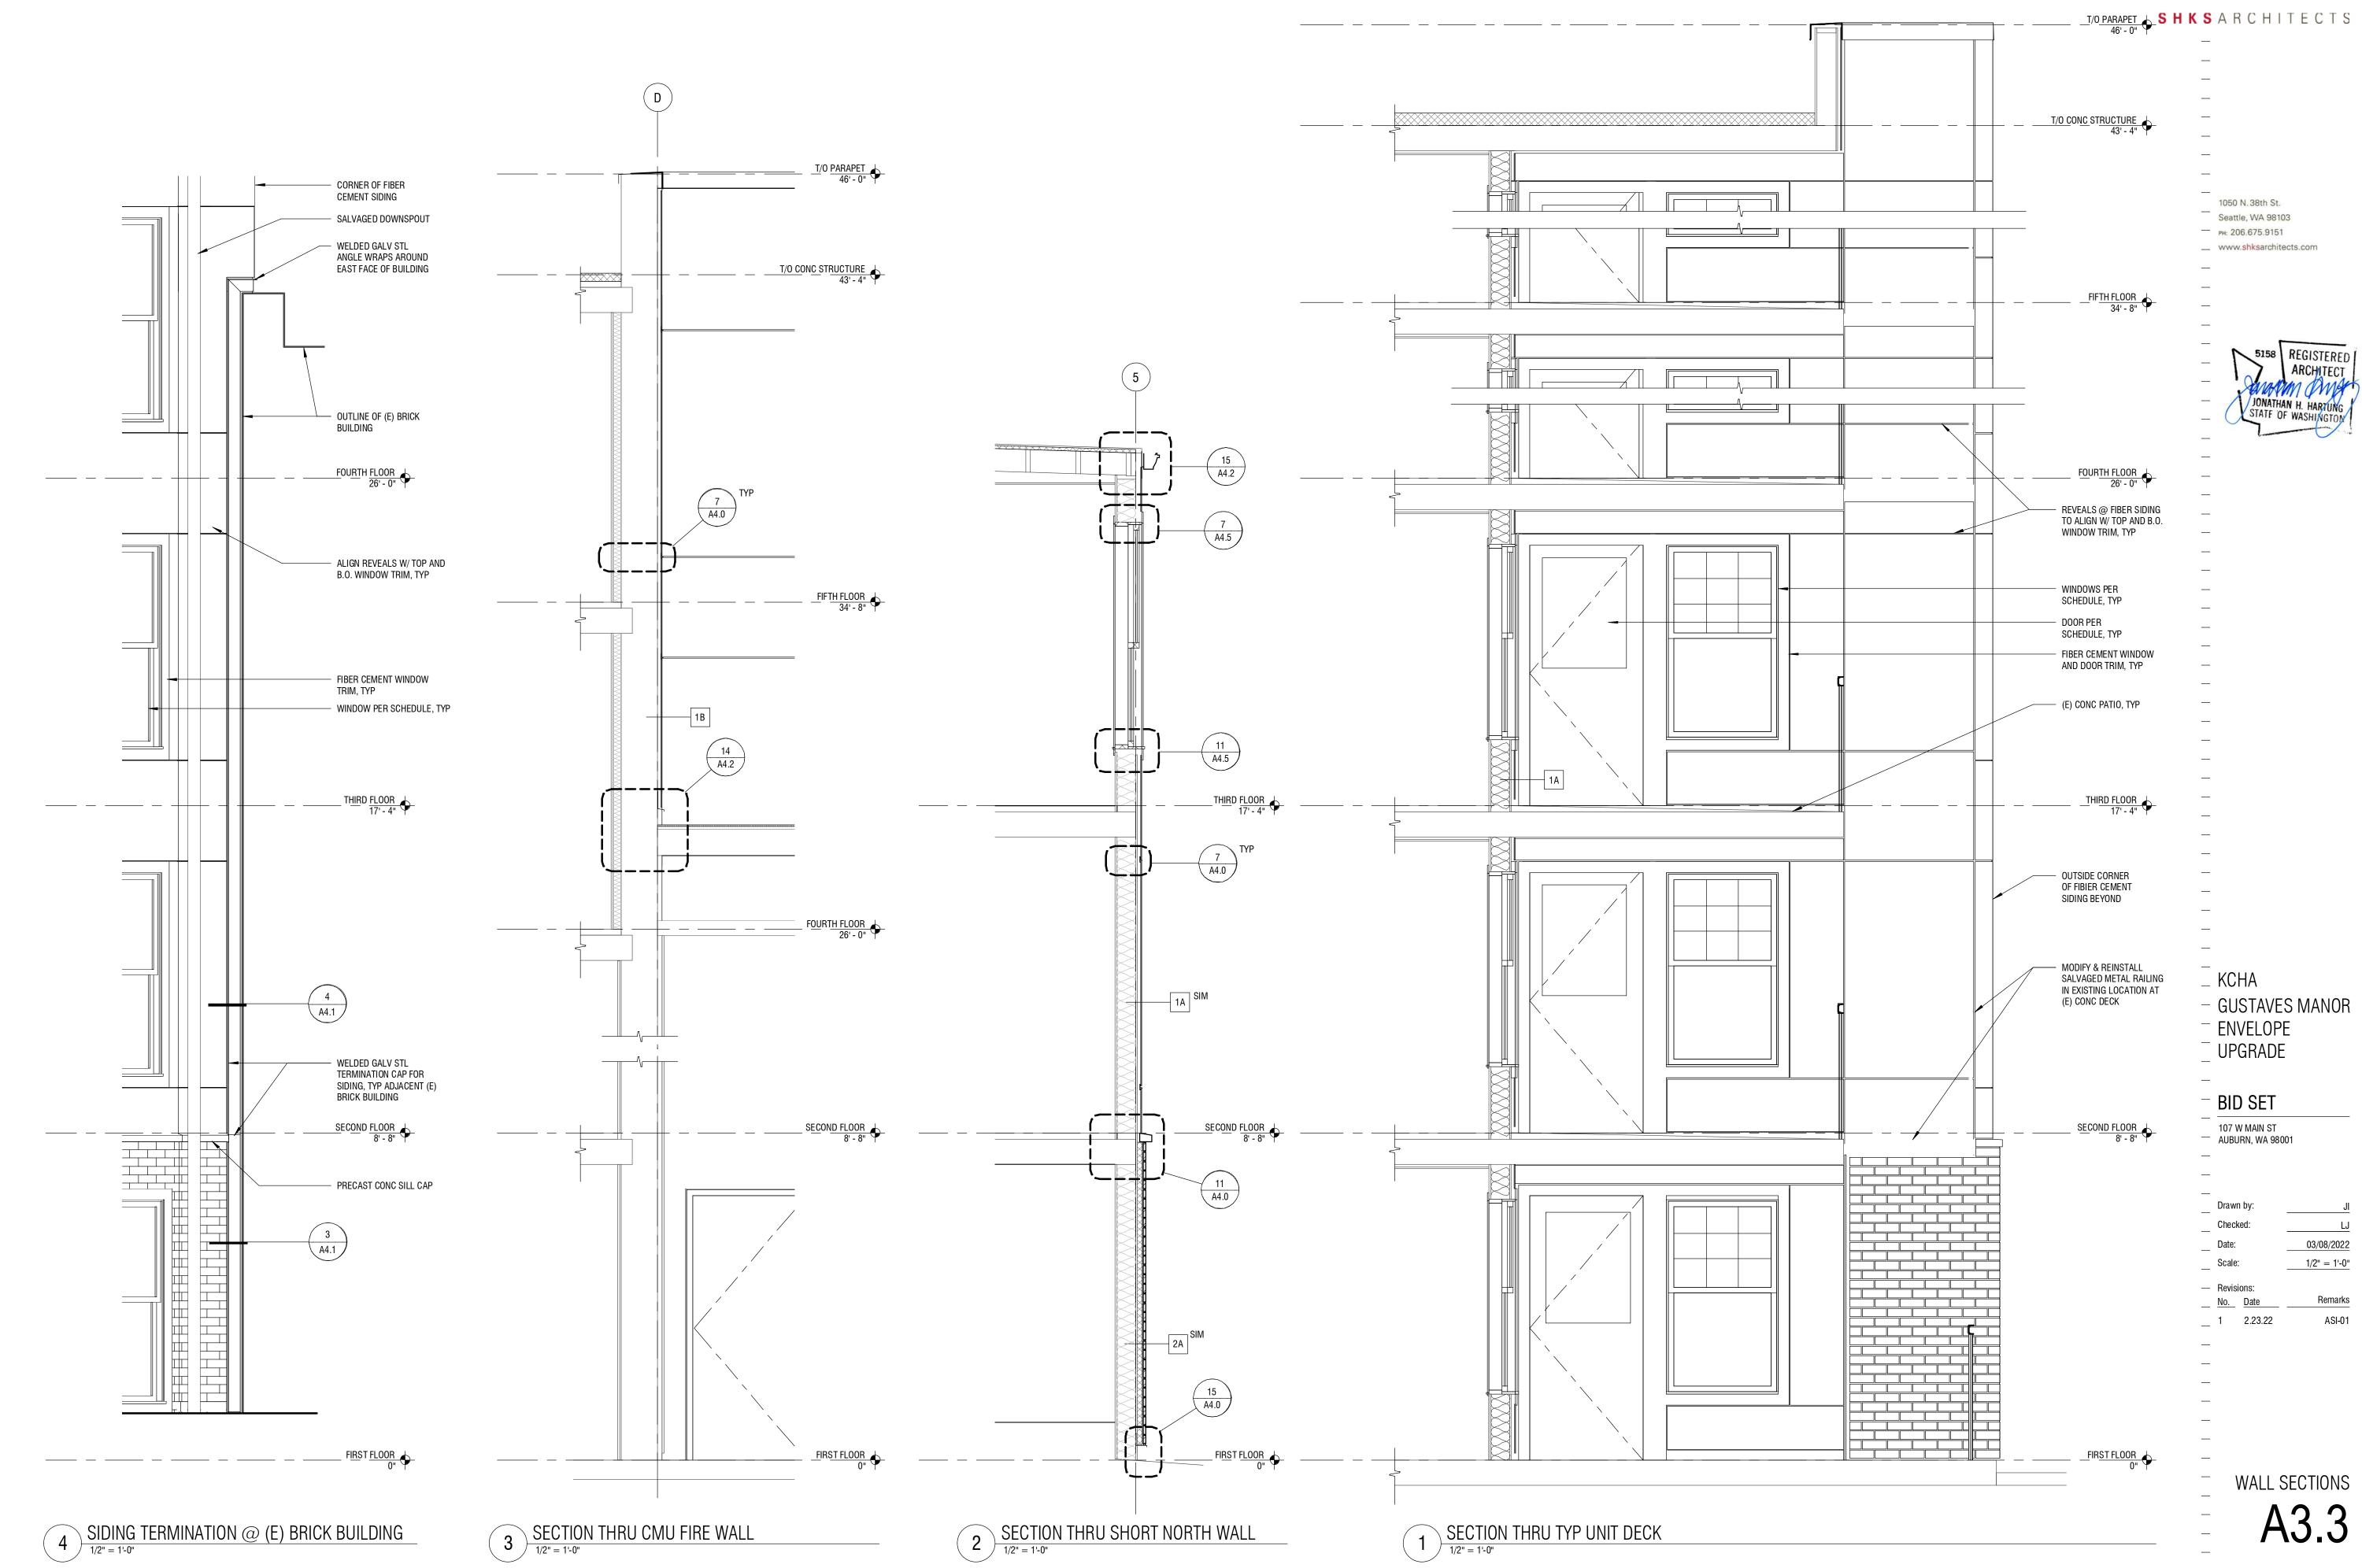

IJ

ASI-01









	T/O PARAPET 46' - 0"
 	<u>T/0 CONC STRUCTURE</u>
	FIFTH FLOOR 34' - 8"
	<u>F</u> OU <u>RTH</u> <u>FLOOR</u> 26' - 0"
	<u>SECOND FLOOR</u> 8' - 8"
	F <u>IRST FLOOR</u>

0 1' 2' 4' 8' 12'

		T/O PARAPET 46' - 0"
	<u></u>	ONC STRUCTURE 43' - 4"
		FIFTH FLOOR 🔺
		<u>FIFTH FLOOR</u> 34' - 8" +
	— (E) BRICK 	FOURTH_FLOOR
	— (E) WINDOW	
		<u>THIRD FLOOR</u> 17' - 4"
		_SE <u>COND FLOOR</u> 8' - 8''
	— (E) STOREFRONT	
		U I




$(3) \frac{\text{FINISH ELEVATION @ PATIOS}}{\frac{1}{8"} = 1^{1} \cdot 0^{"}}$

FINISH LEGEND


2
BENJAMIN MOORE 055 "PUMPKIN PATCH"
BENJAMIN MOORE 056 "MONTANA AGATE"
BENJAMIN MOORE 1128 "ADOBE BEIGE"
BENJAMIN MOORE 2061-10 "DEEP ROYAL"
BRICK VENEER, BASIS OF DESIGN: MUTUAL MATERIALS FACE BRICK "COAL CREEK"


- <u>GENERAL NOTES:</u>
 PAINT EXHAUST VENTS, PIPES, EXPOSED CONDUIT, AND EXPOSED ELECTRICAL BOXES TO MATCH ADJACENT WALL COLOR.
 PAINT FLASHING OVER TRIM TO MATCH ADJACENT TRIM COLOR. PAINT FLASHING
- PAINT PLASHING OVER TRIM TO MATCH ADJACENT TRIM COLOR. PAINT PLASHING OVER PANELS TO MATCH ADJACENT PANEL COLOR.
 PAINT INTERIOR WALLS AND TRIM AFFECTED BY WORK OF THIS CONTRACT TO MATCH EXISTING INTERIOR PAINT COLOR.
 HOSEBIBS AND LIGHT FIXTURES TO REMAIN UNPAINTED.

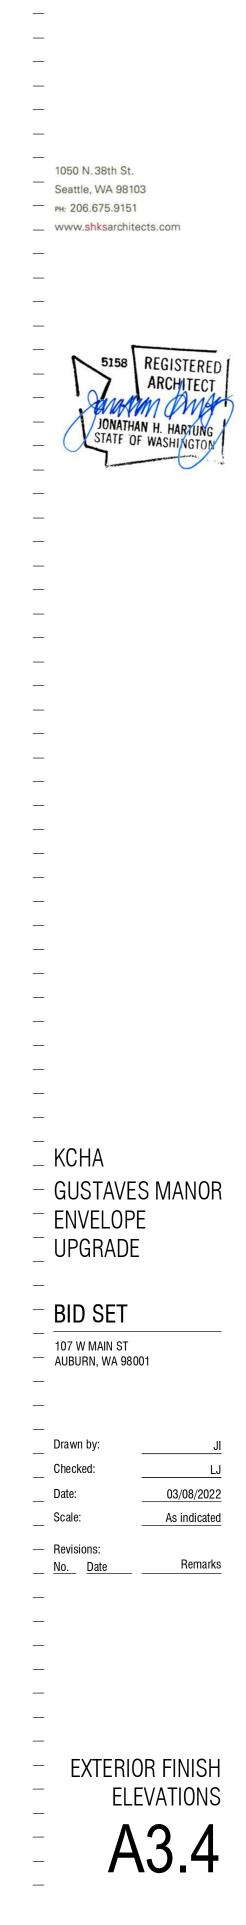

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_

ARCHITEC JONATHAN H. HARTUN ____ — _ KCHA – GUSTAVES MANOR ⁻ ENVELOPE $_$ UPGRADE ____ $^-$ BID SET 107 W MAIN ST — Auburn, wa 98001 _ ___ Drawn by: Checked: LJ 03/08/2022 Date: Scale: As indicated Revisions: Remarks <u>No.</u> Date ____

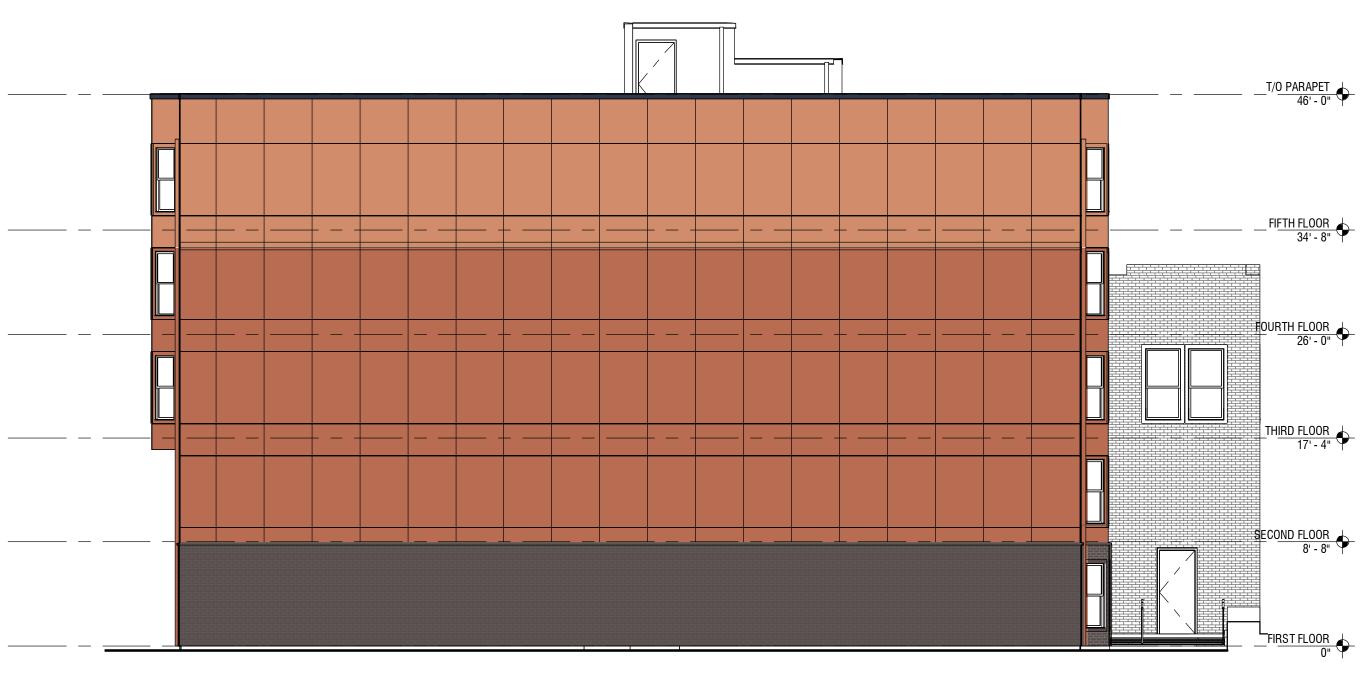0 1' 2' 4' 8' 12

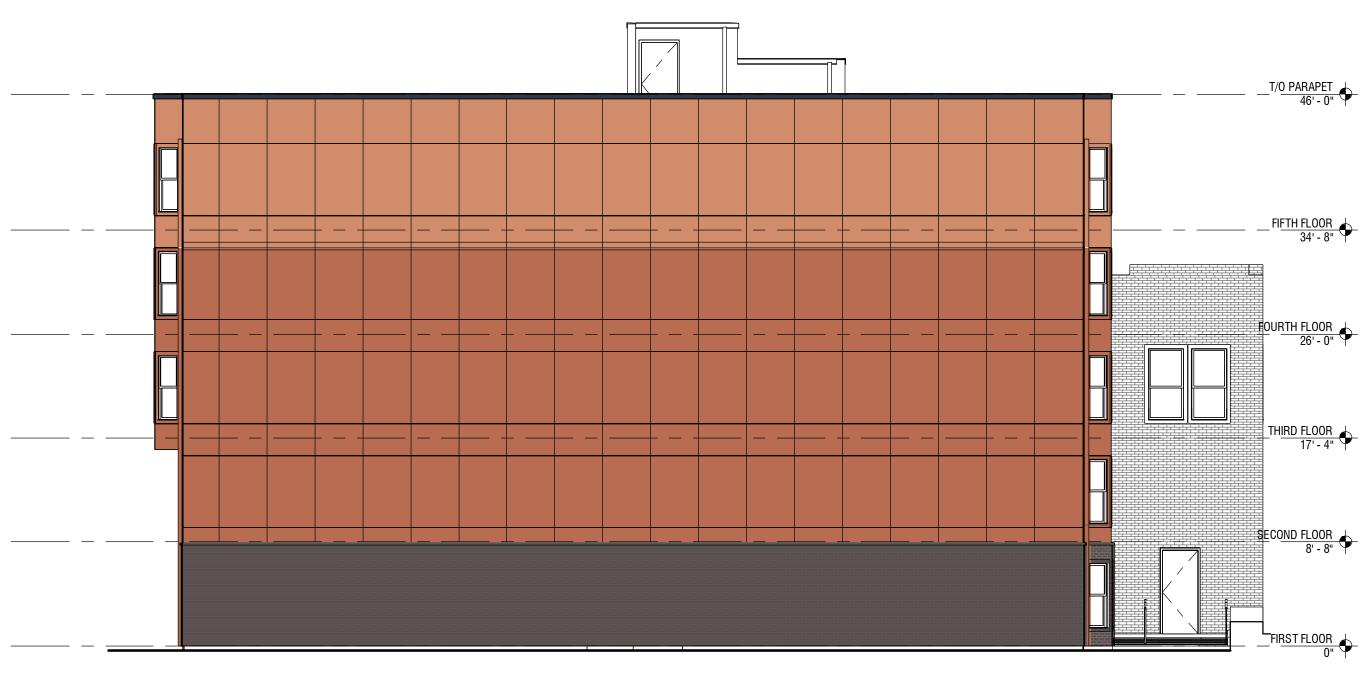FINISH LEGEND


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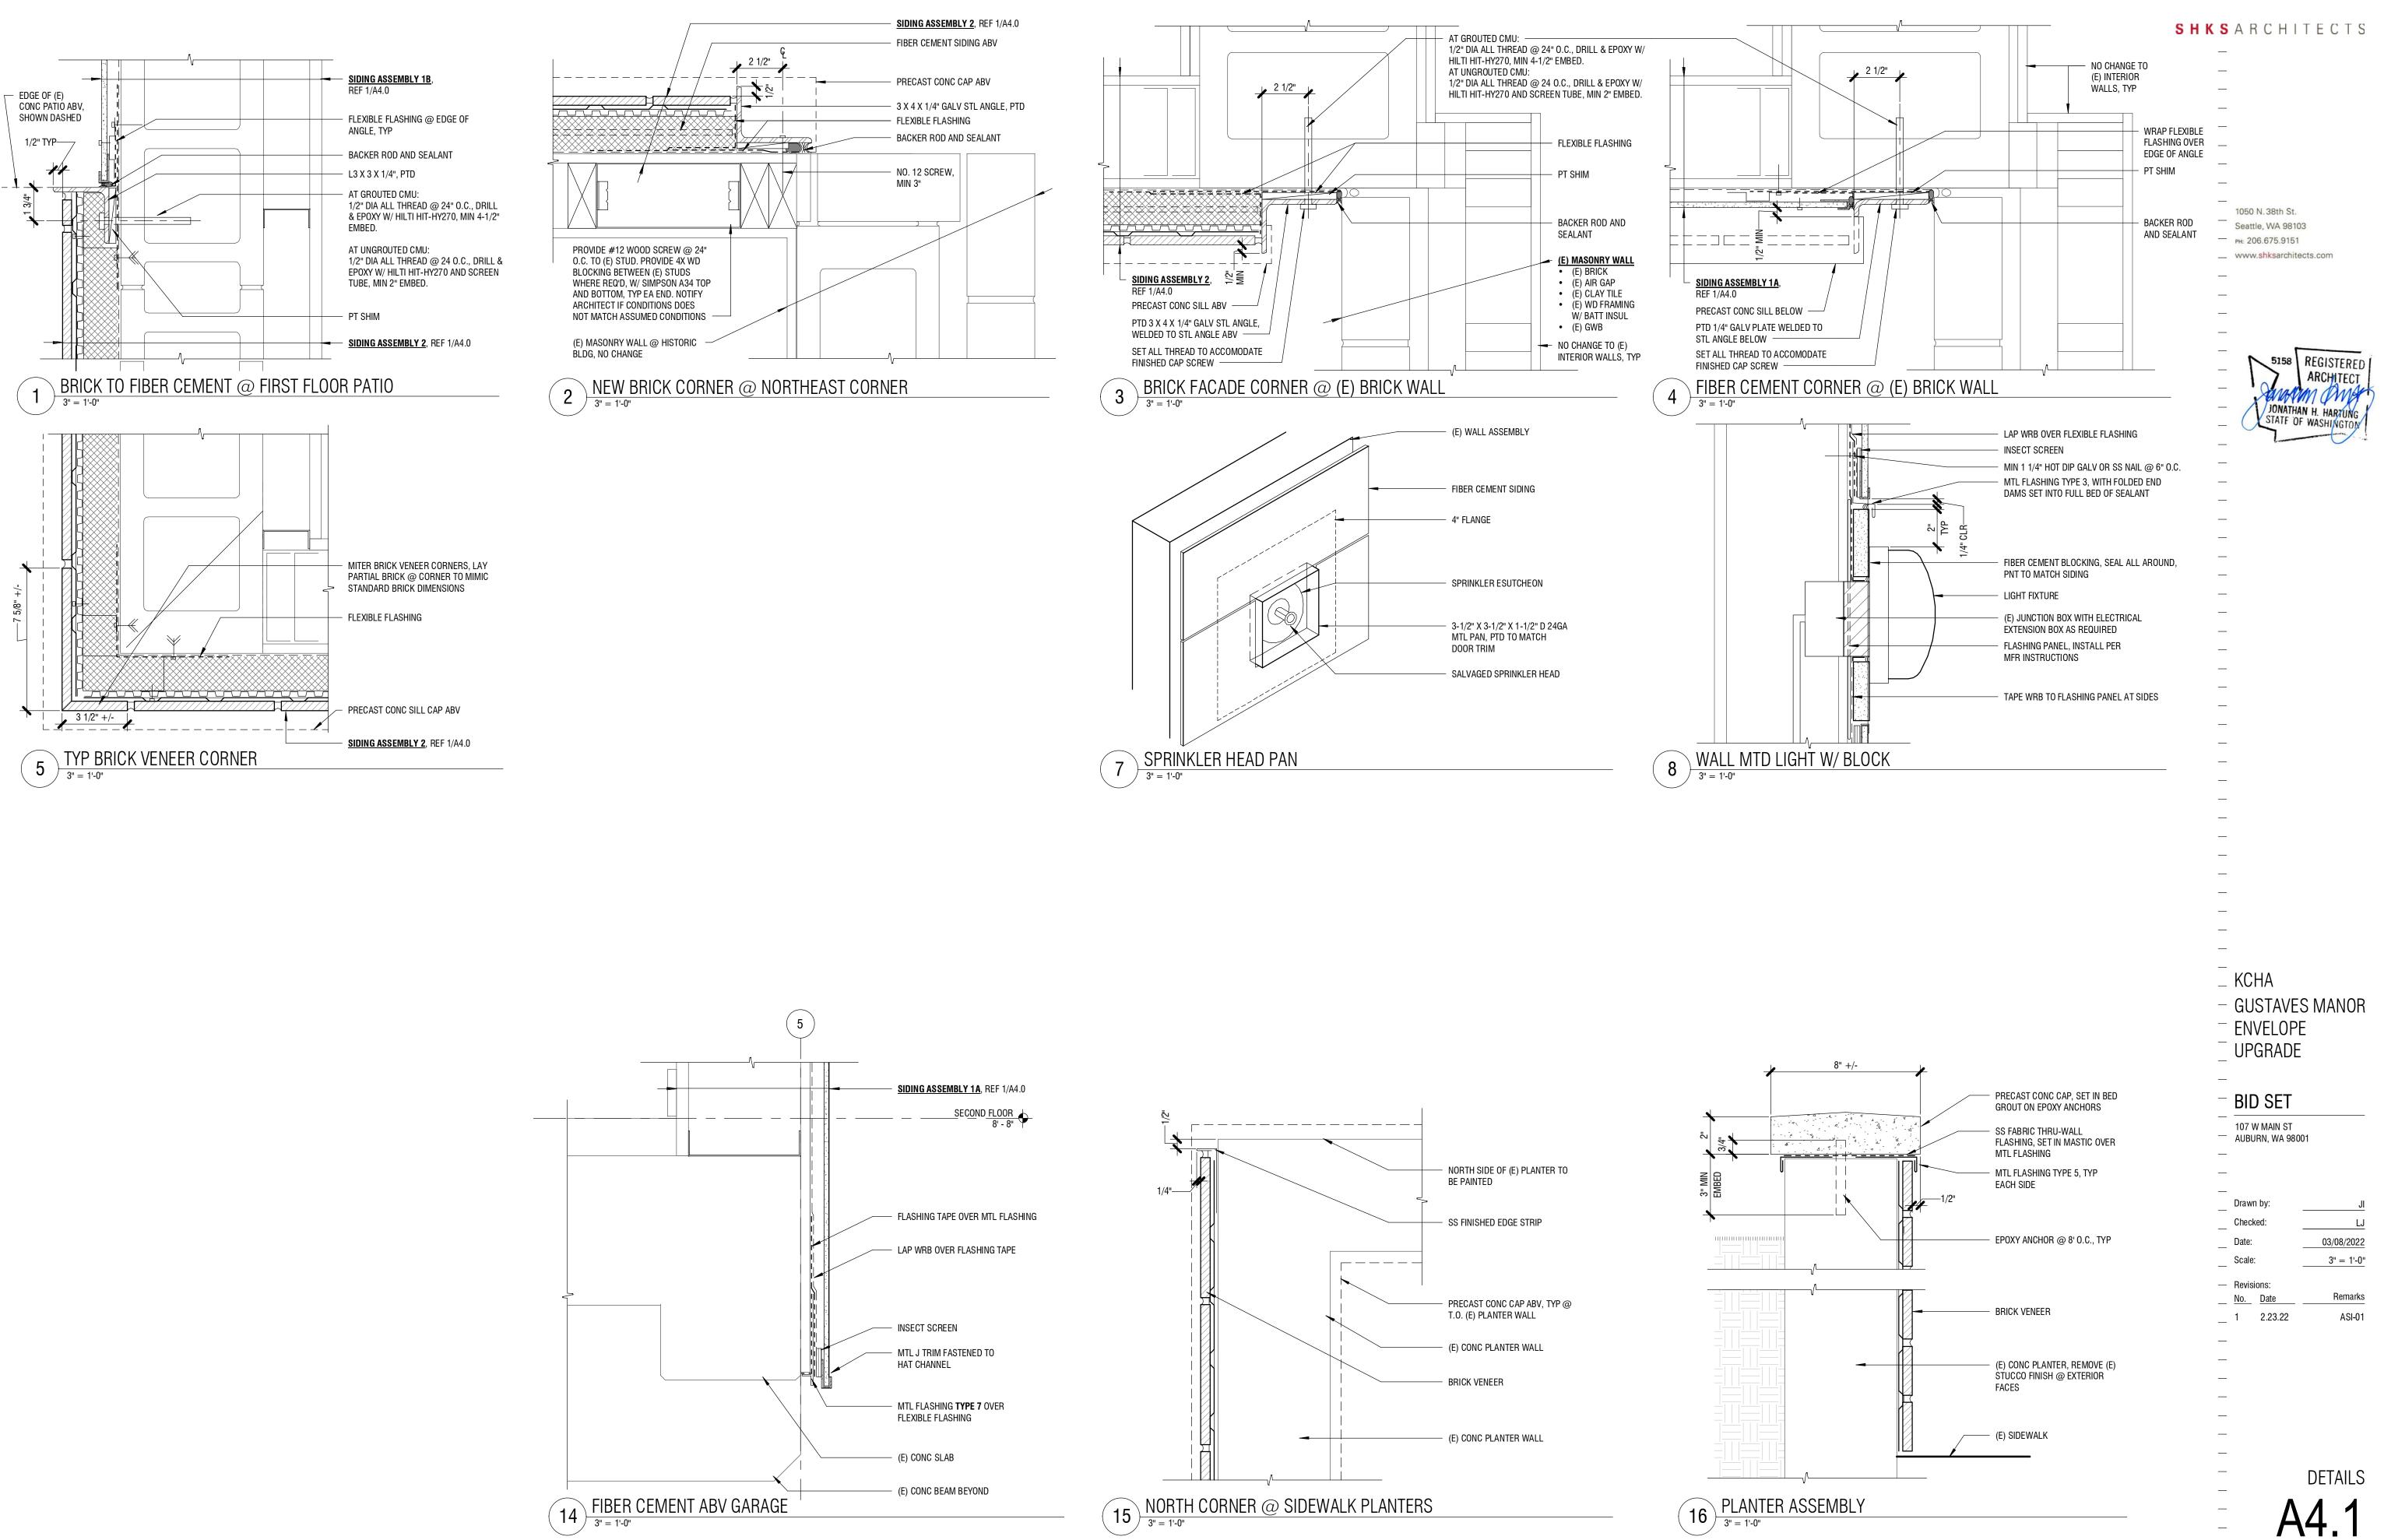
ELEVATIONS A3.5


EXTERIOR FINISH


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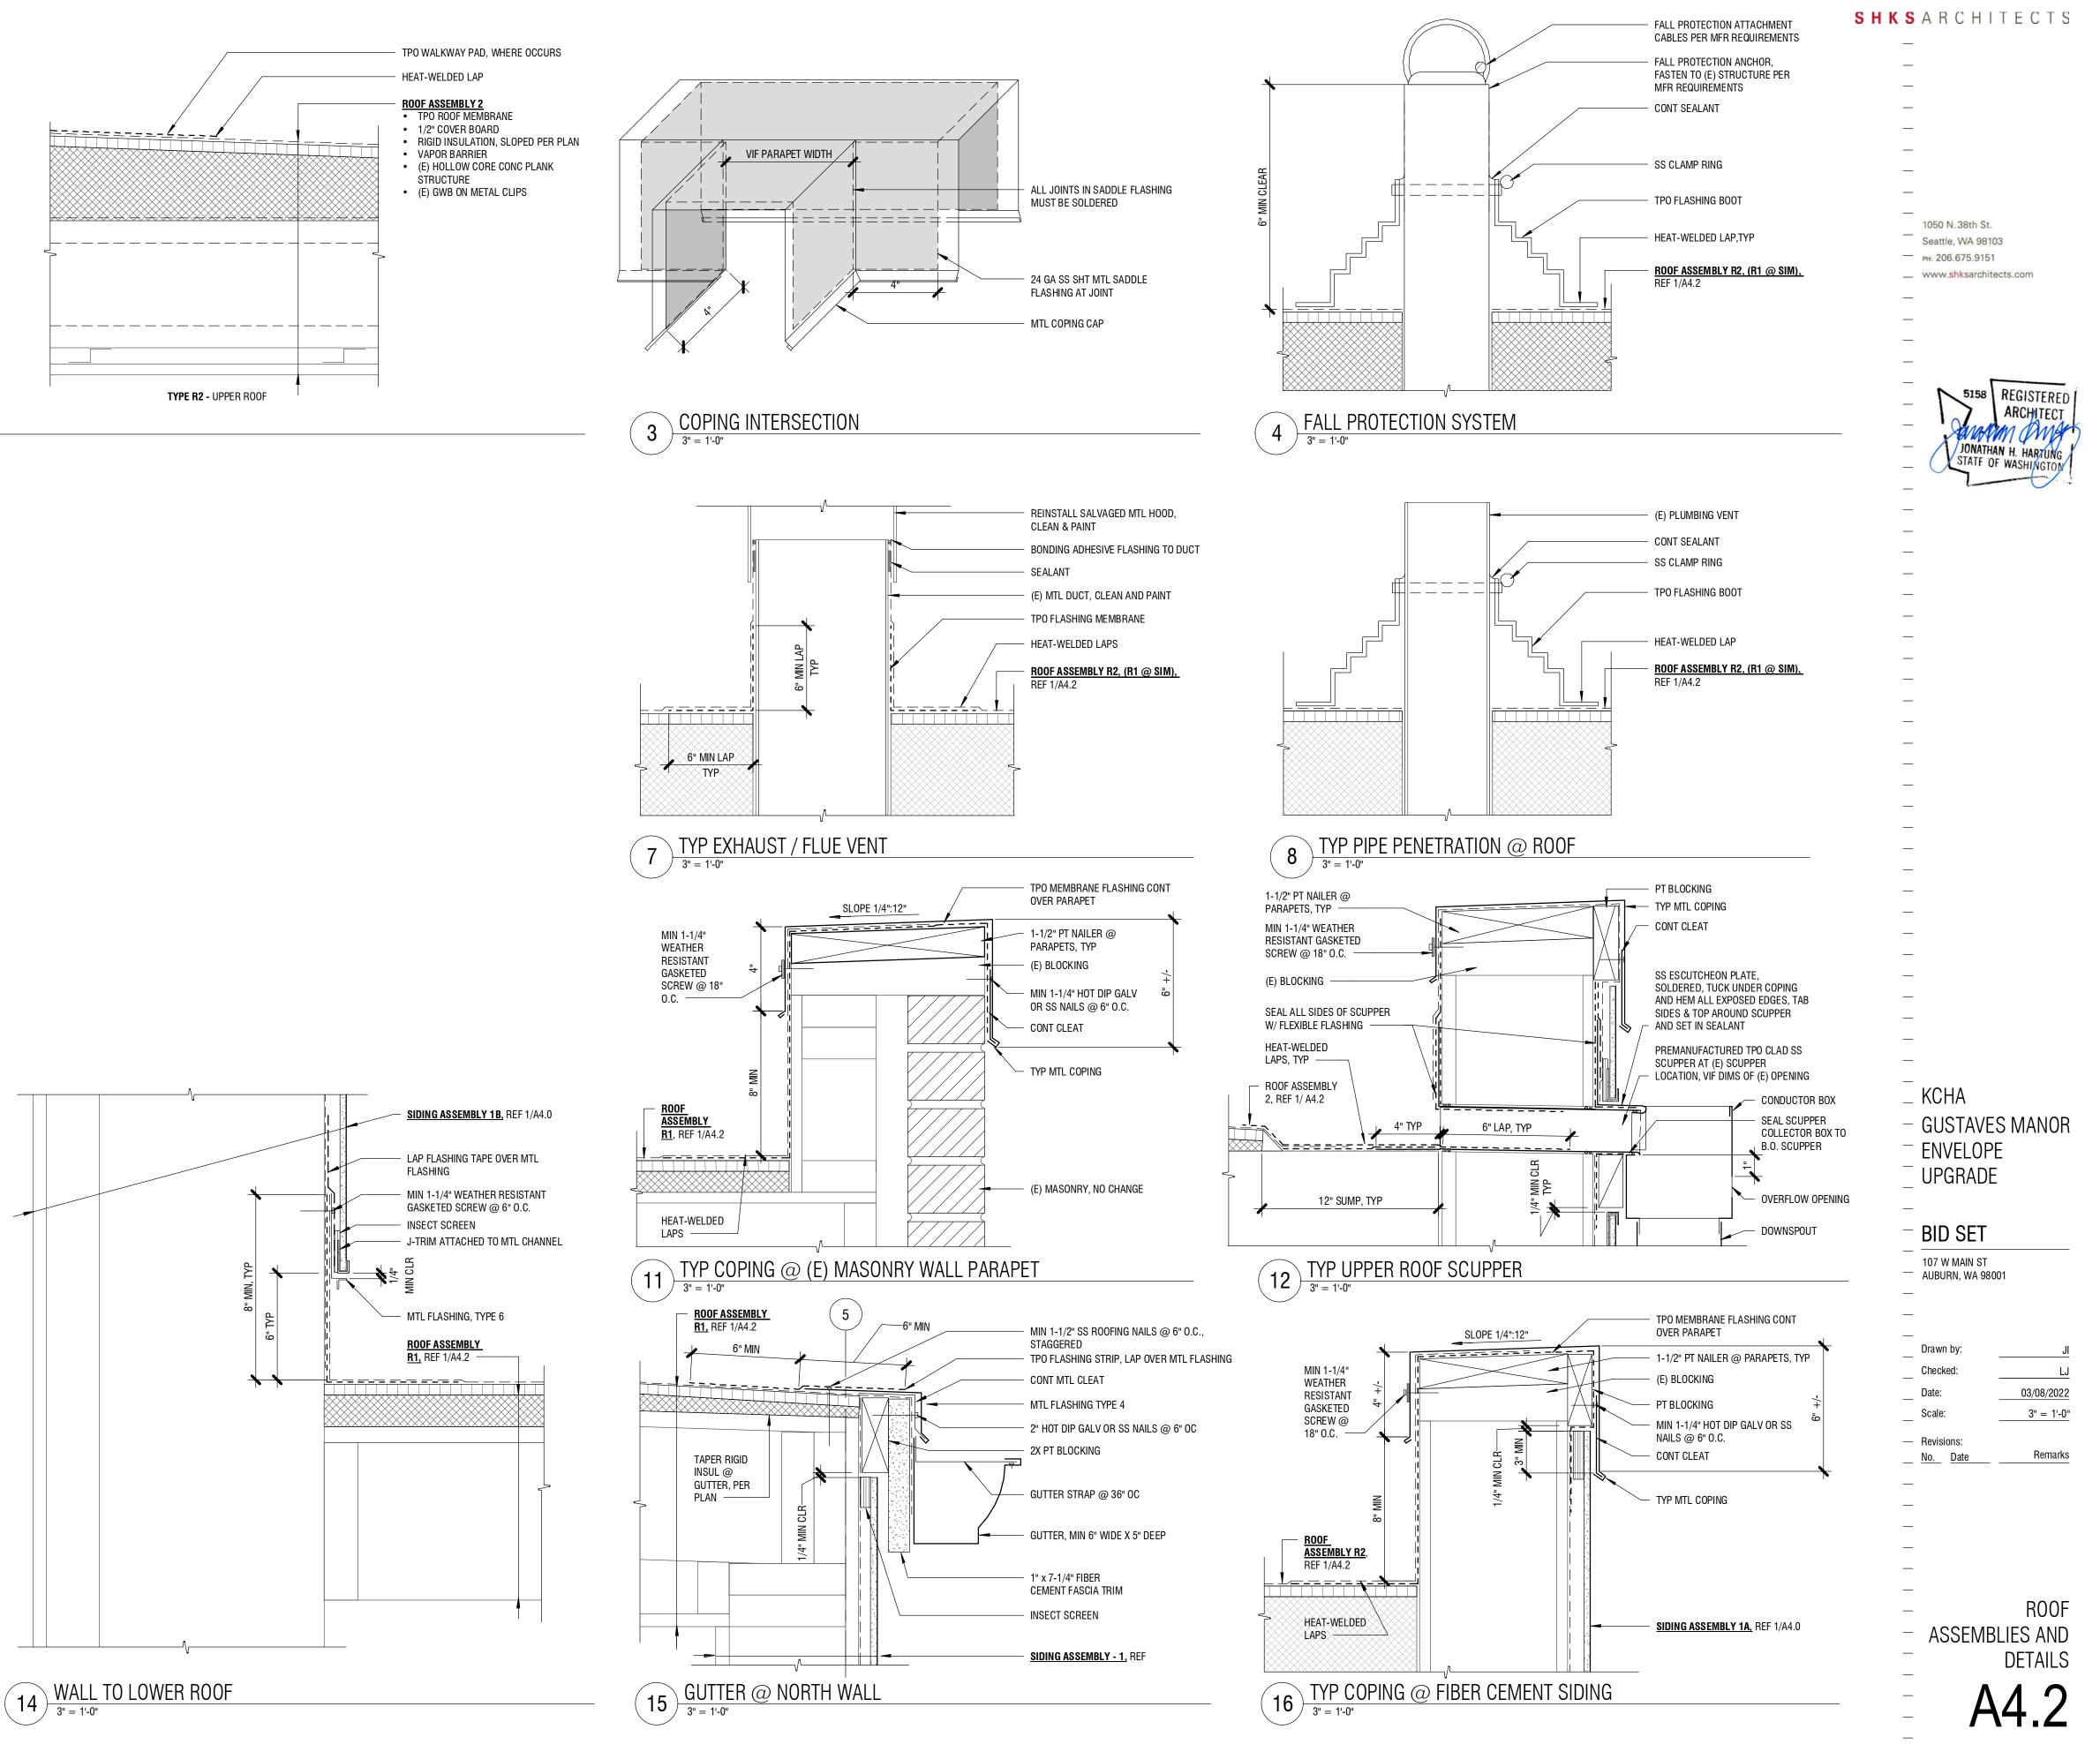



(16) <u>117 FIC</u> <u>3" = 1'-0"</u>




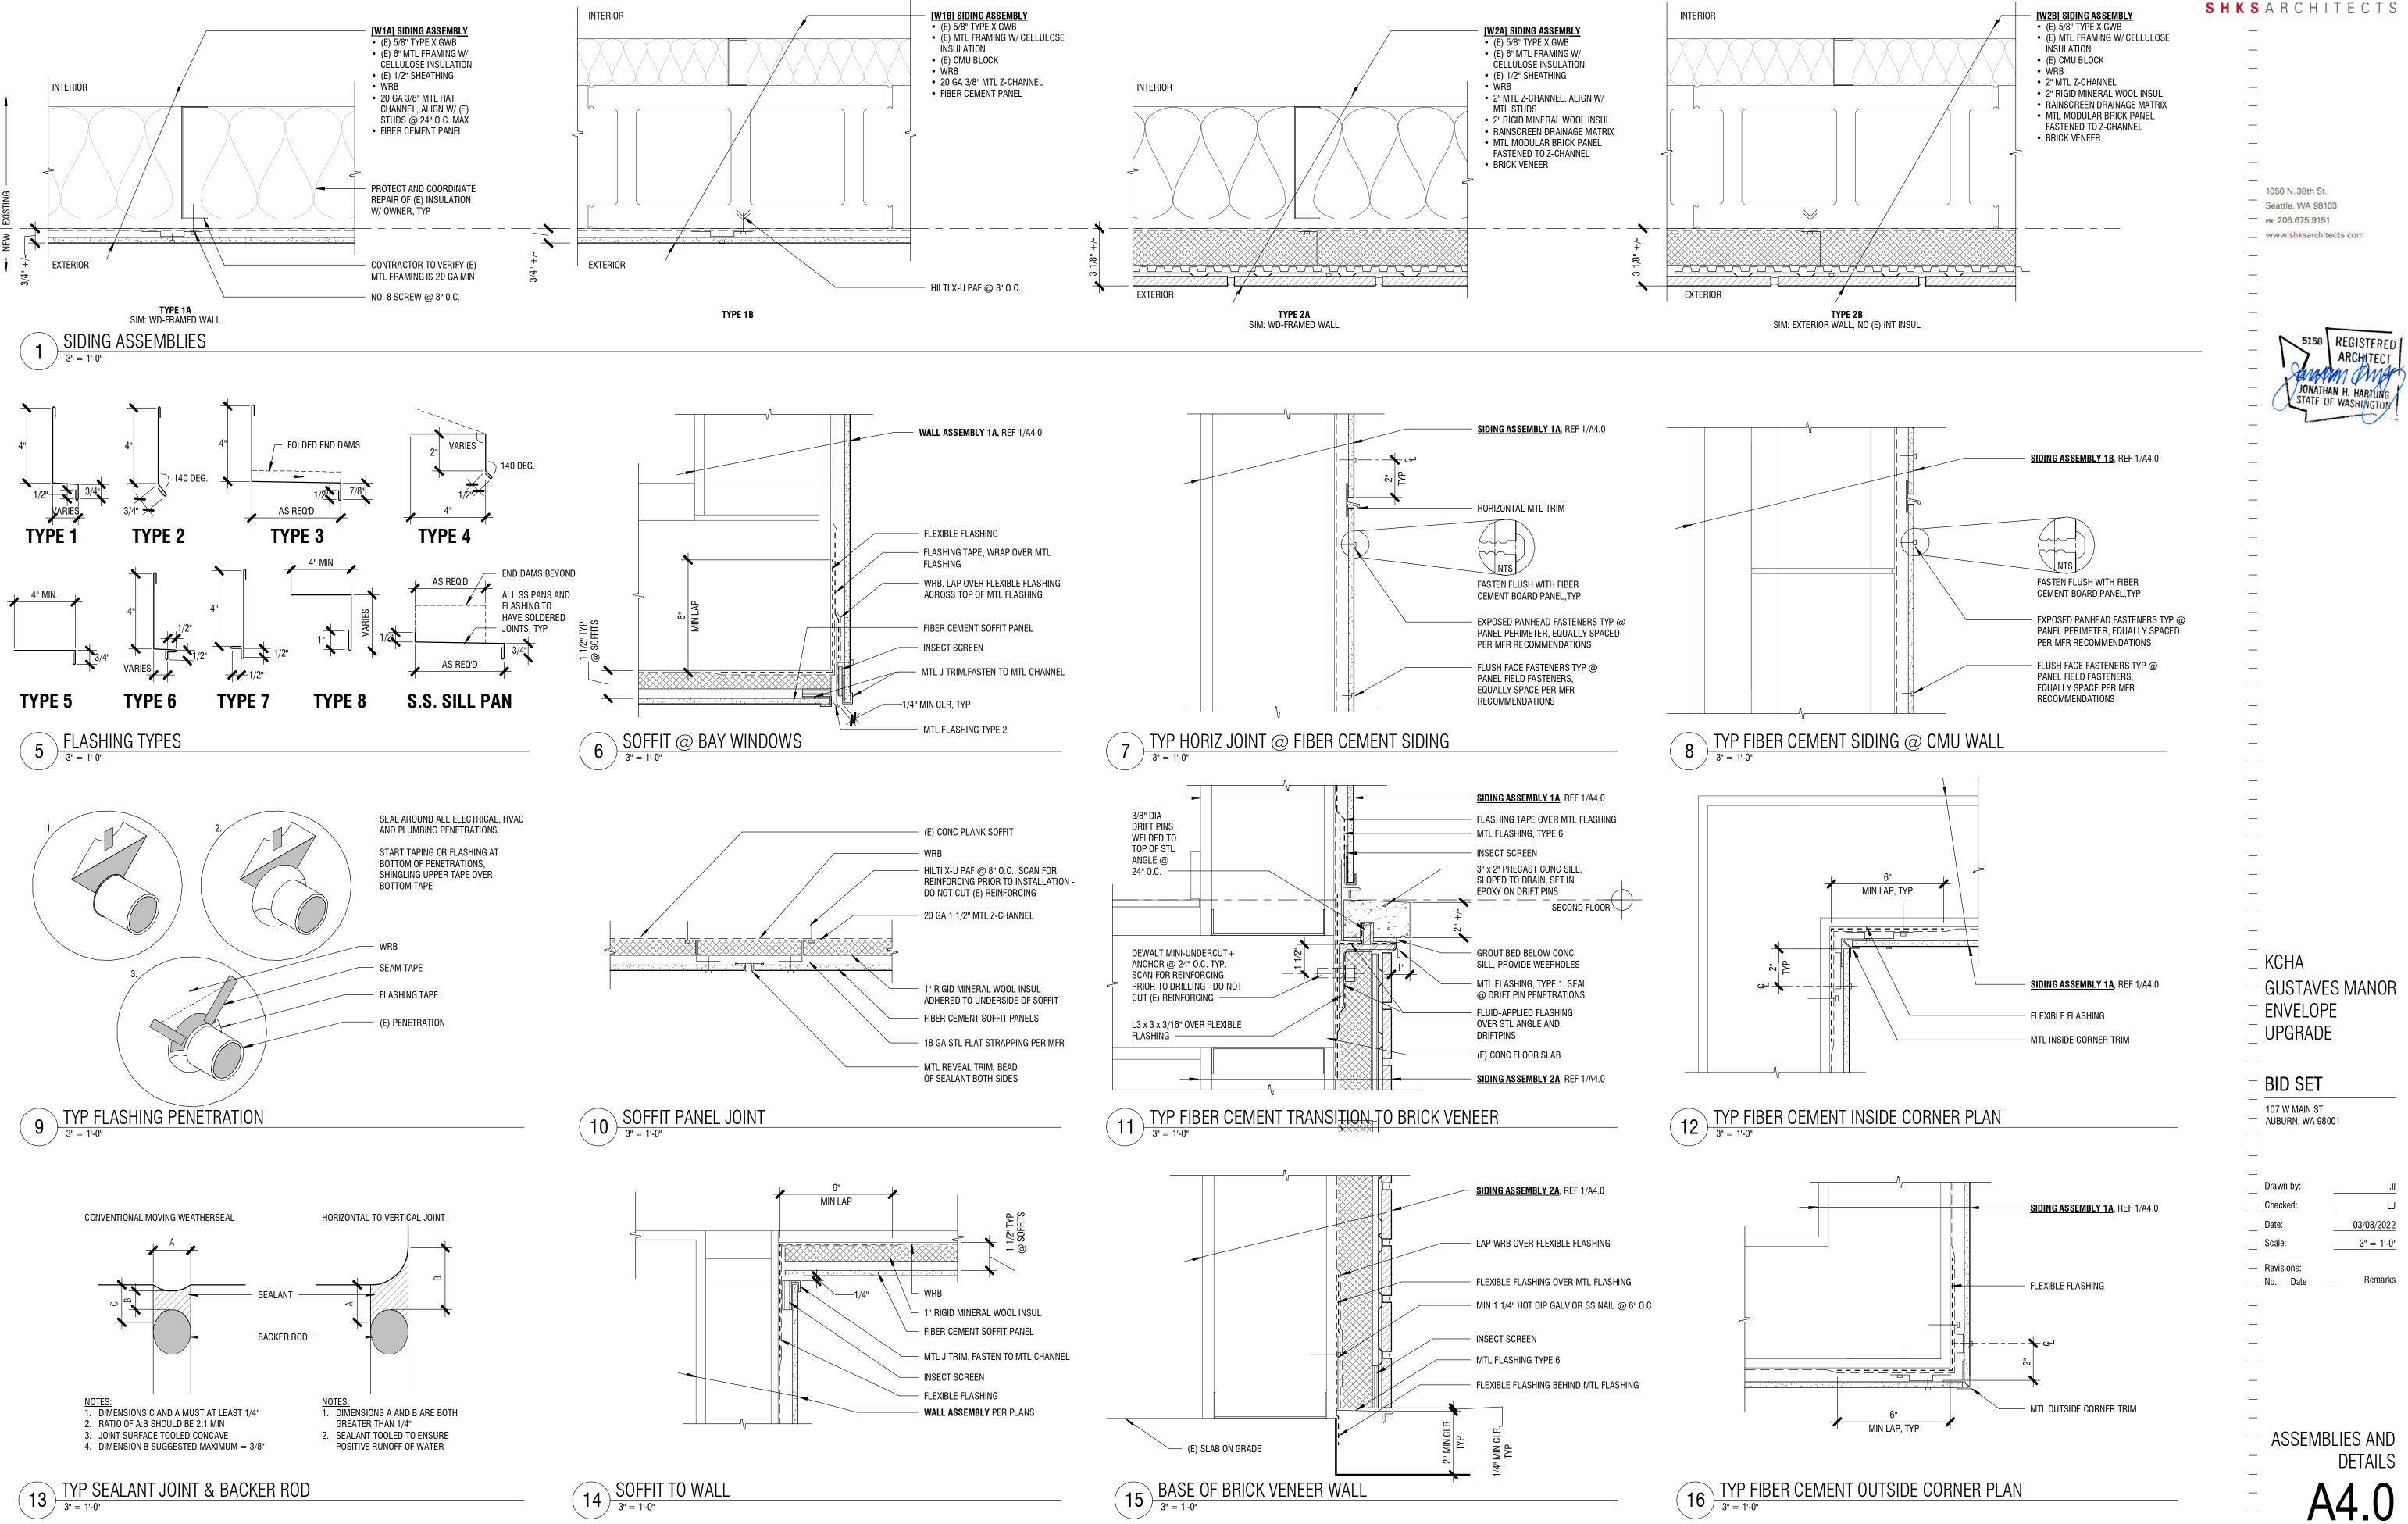

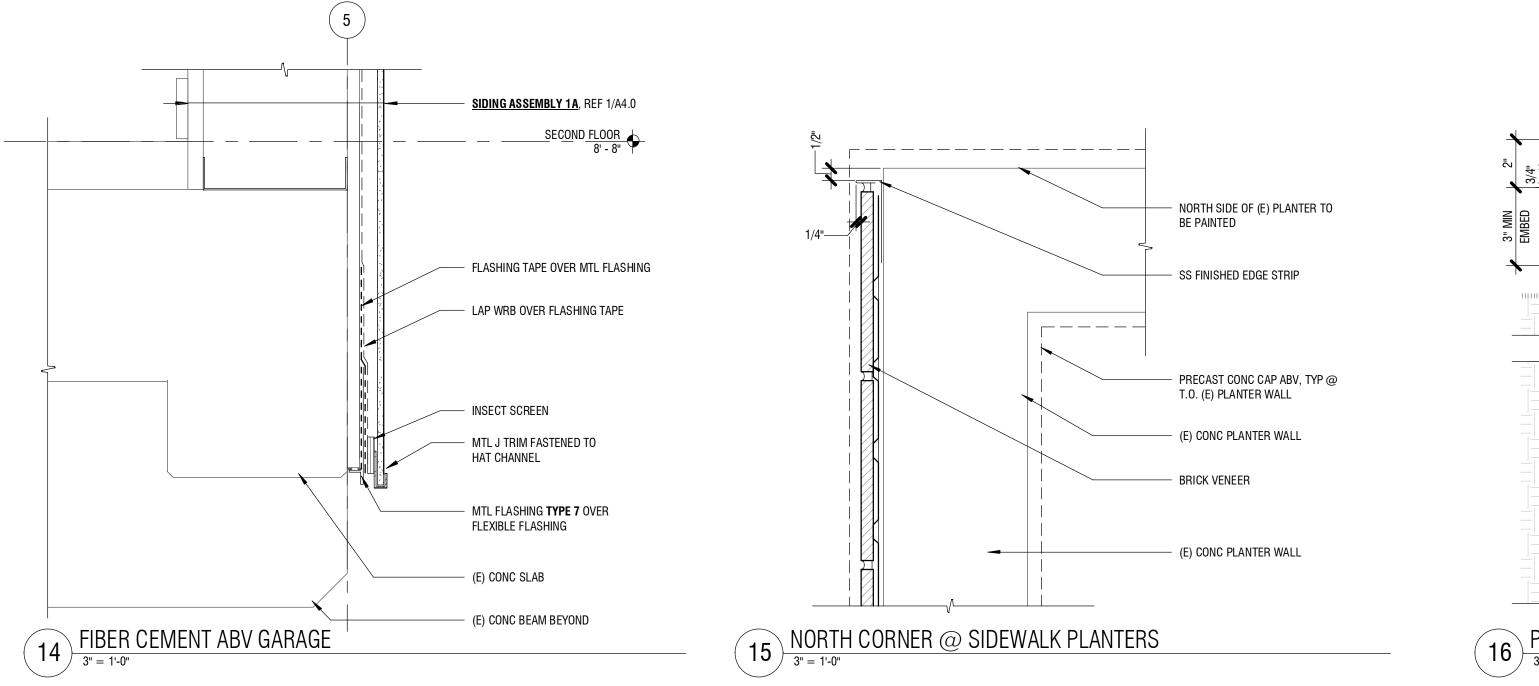


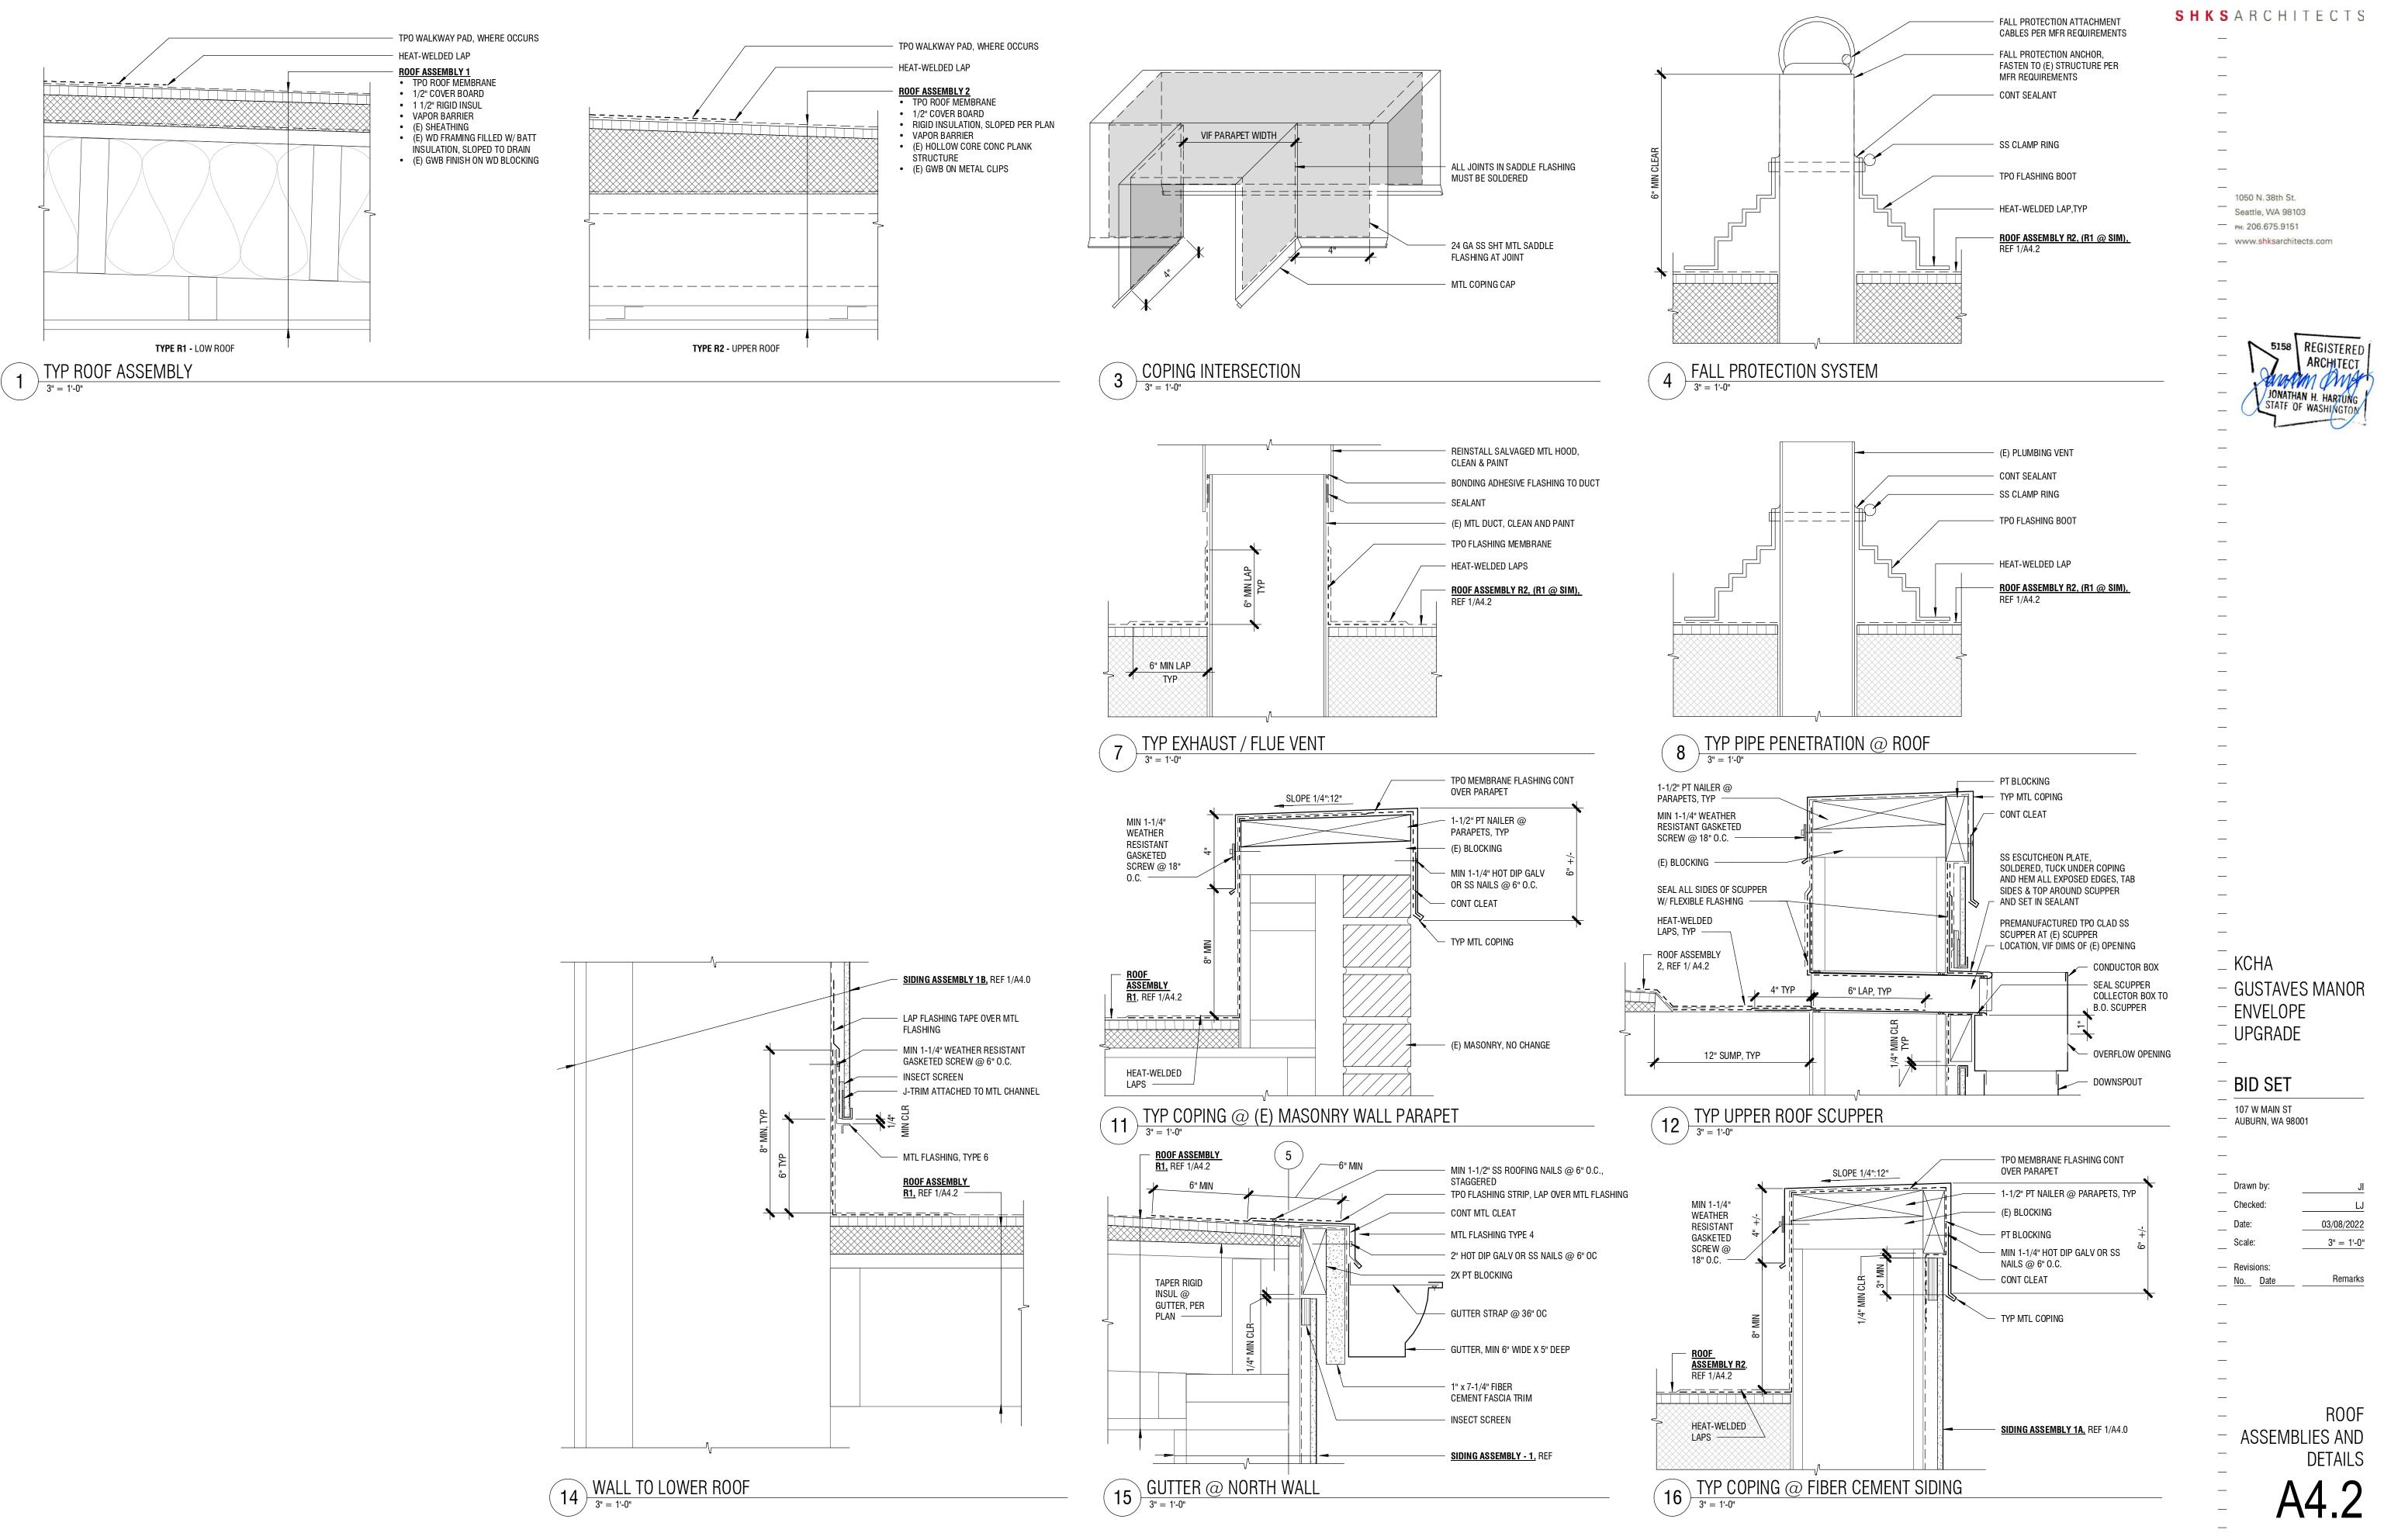

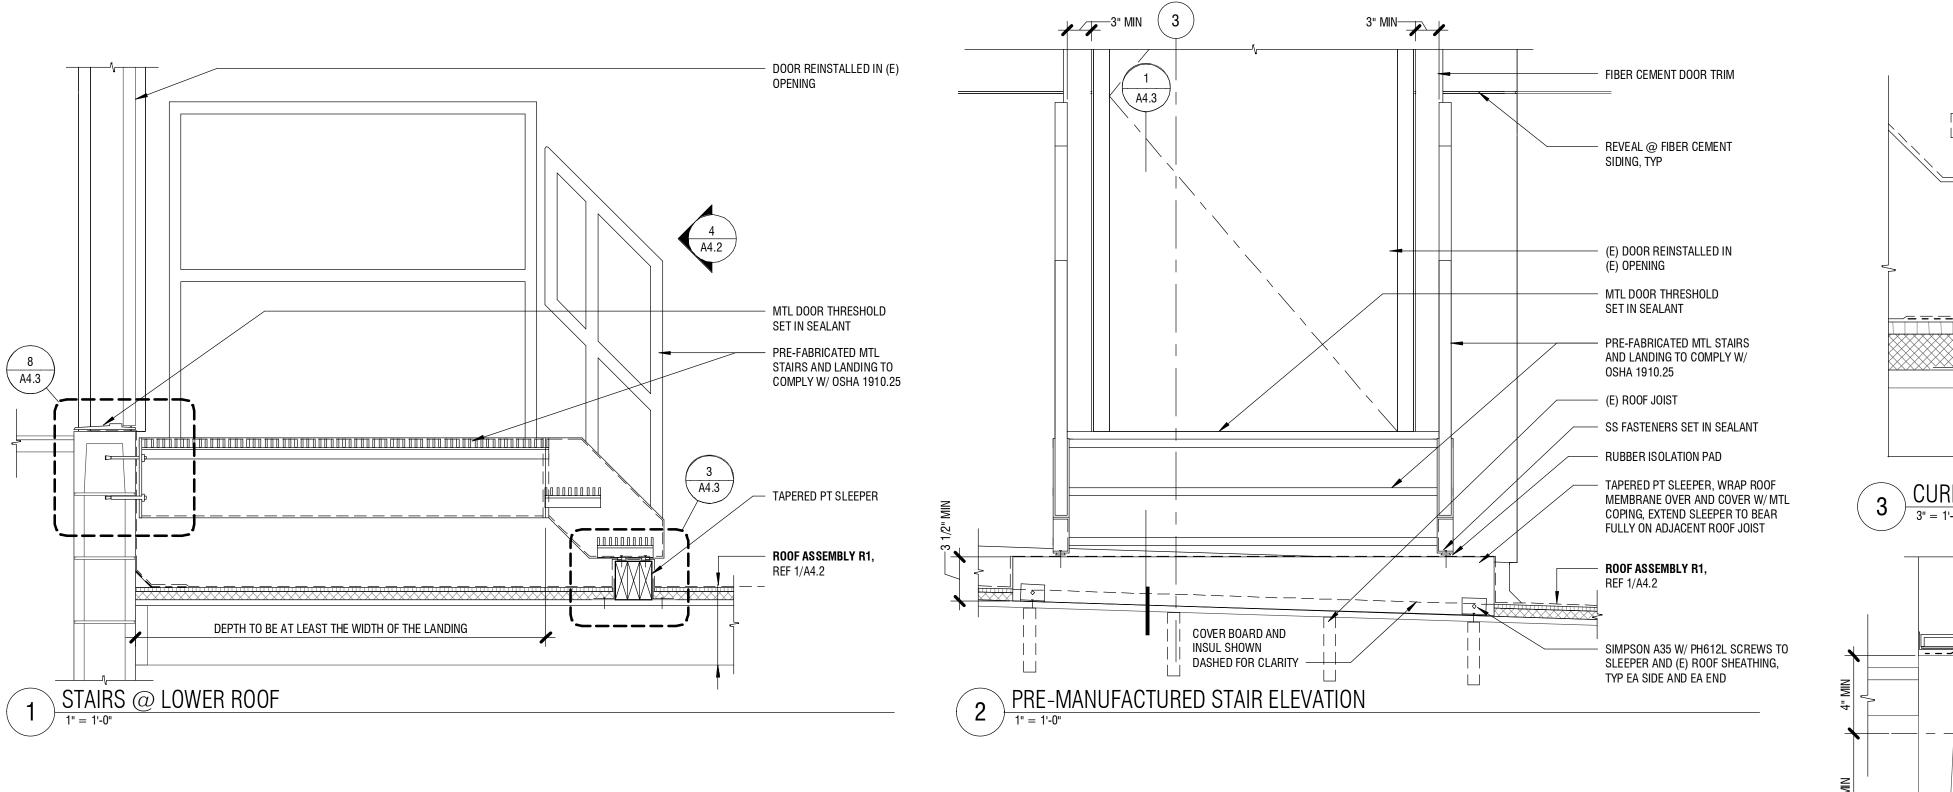

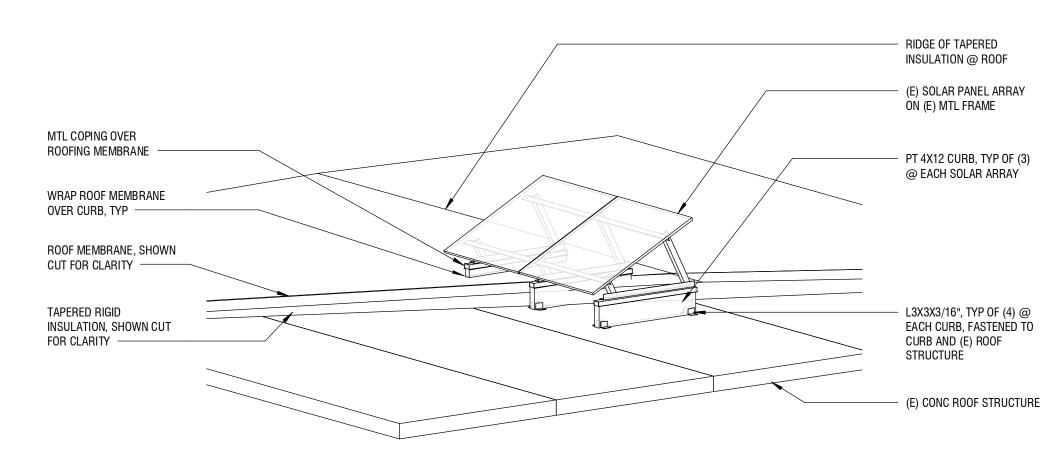


(13) SOLAR PANEL CURB 3D DIAGRAM

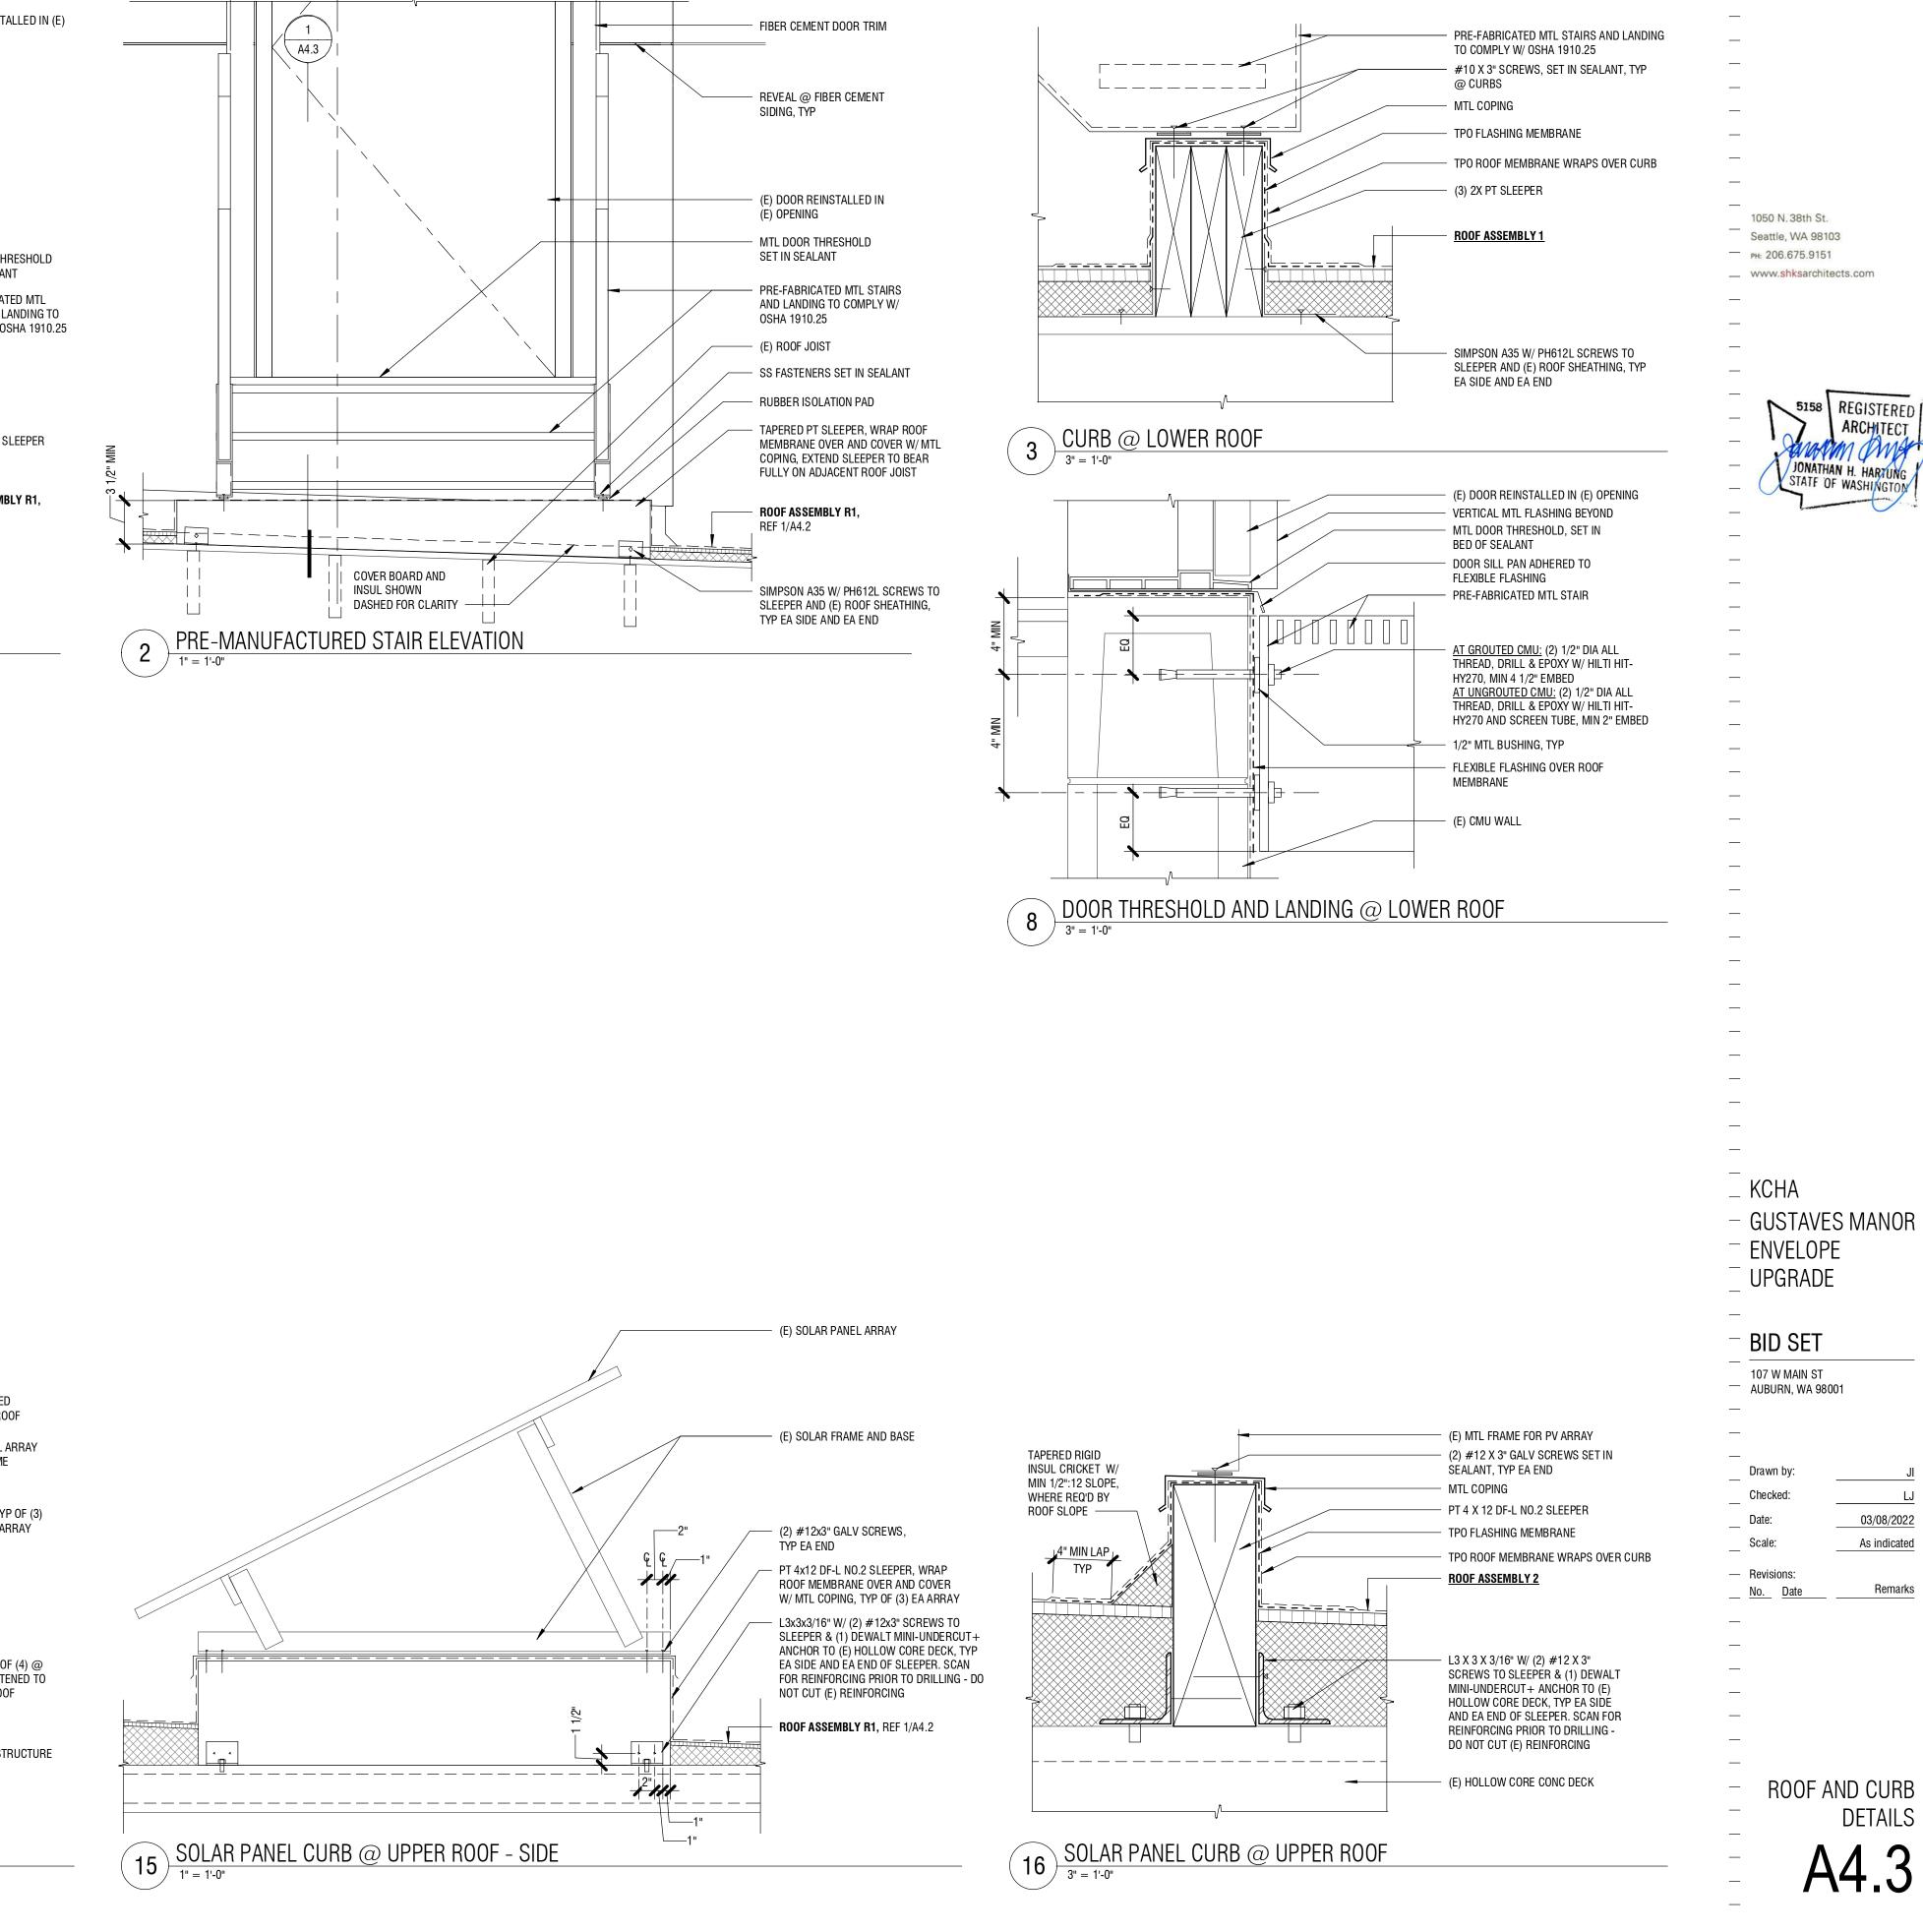





1.1

Remarks

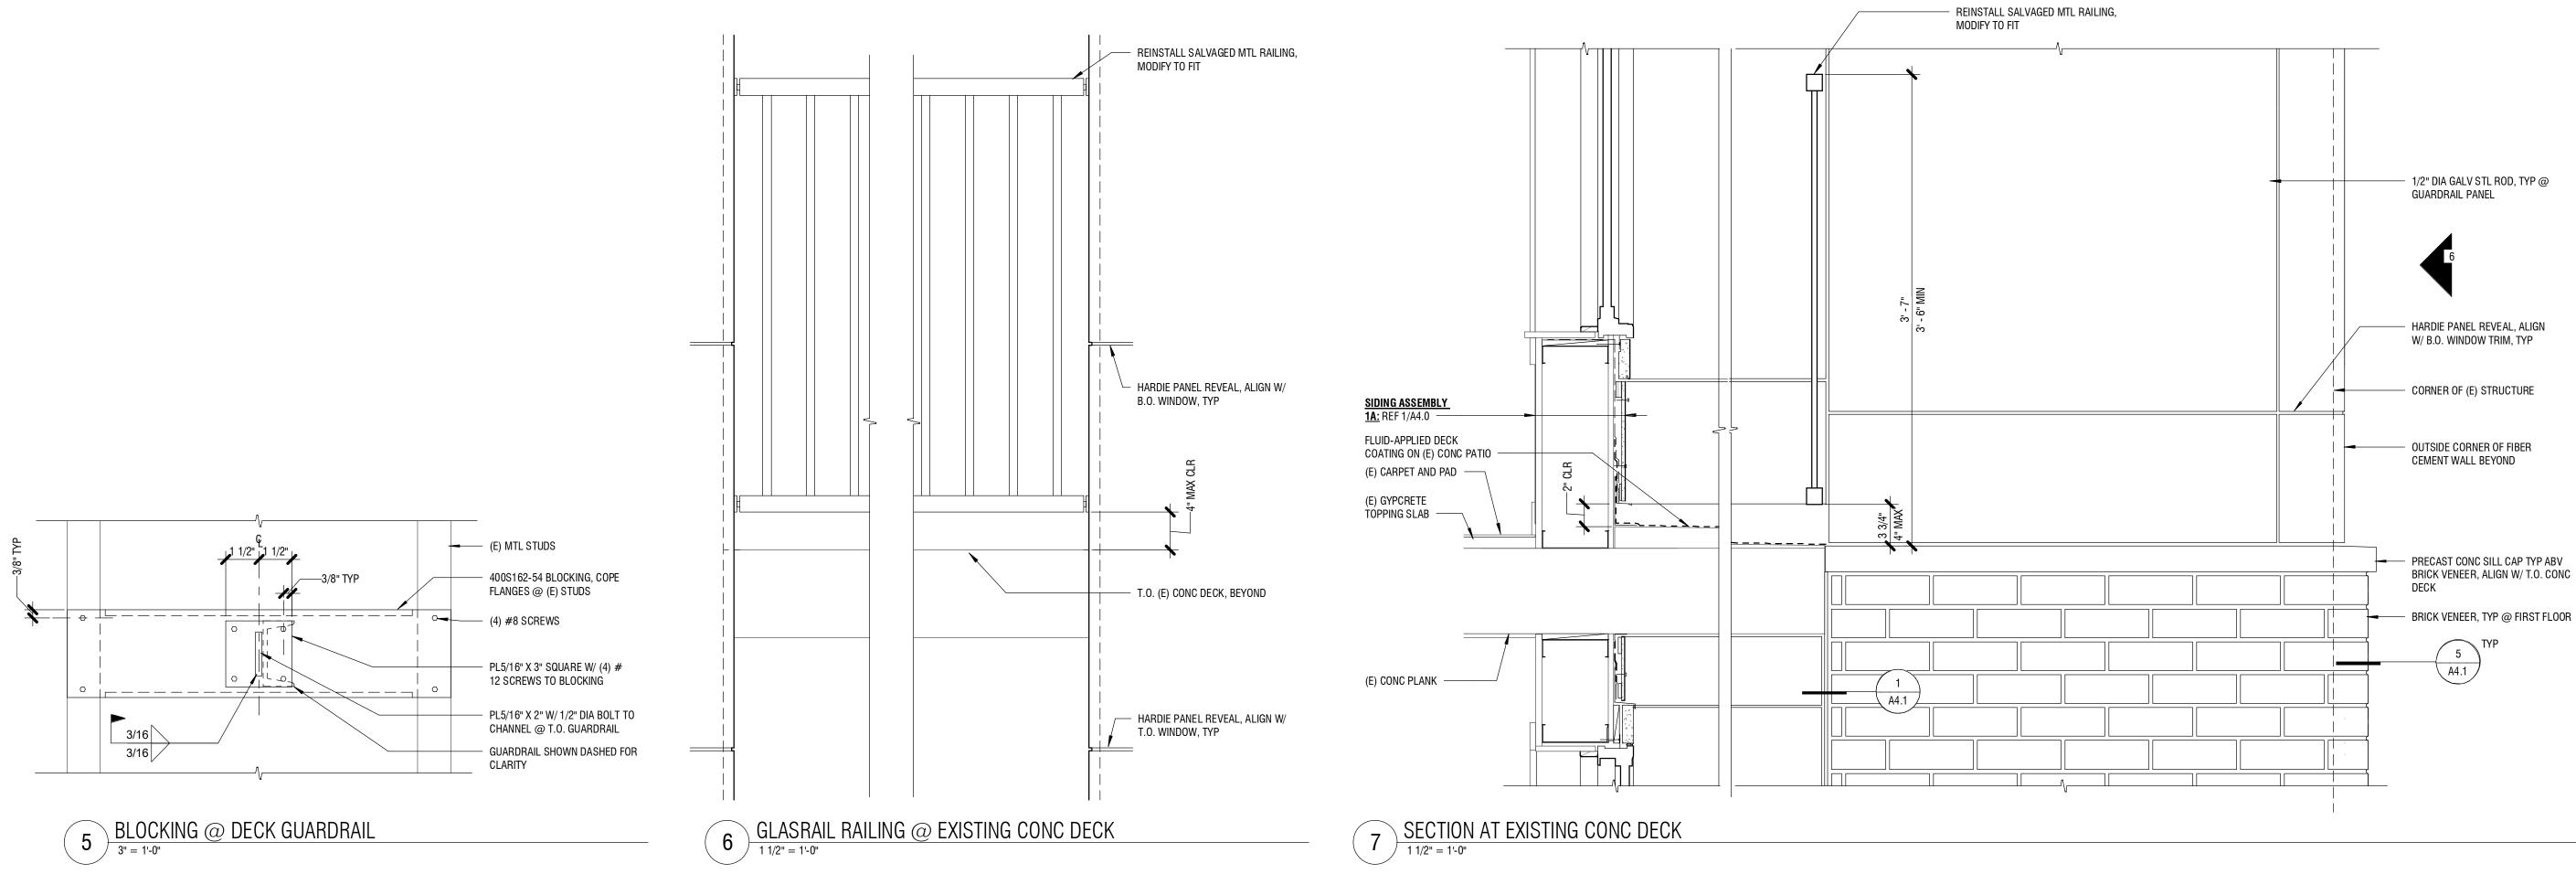

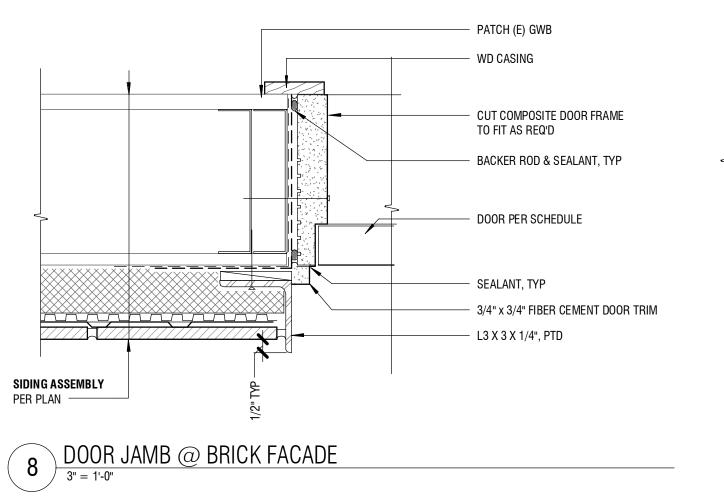

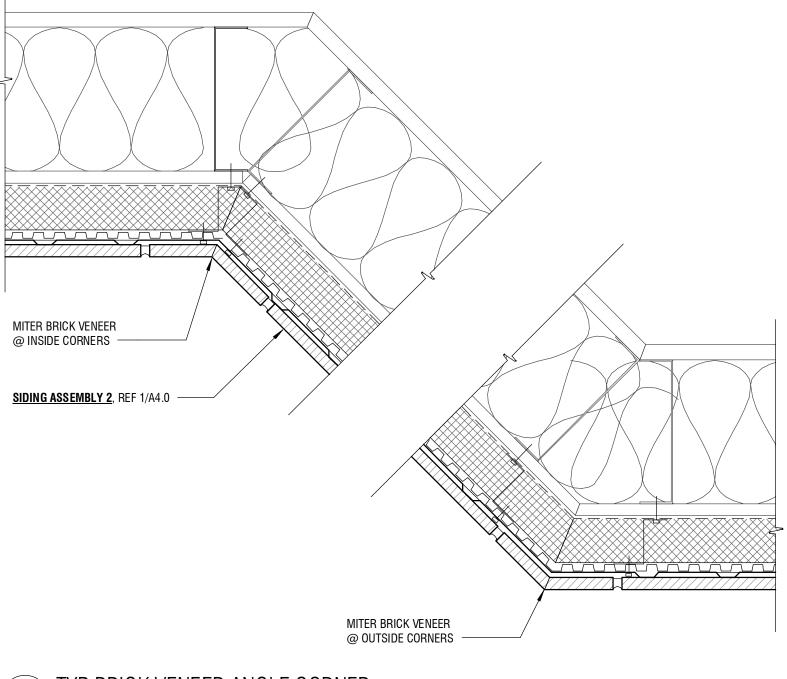


9 TYP BRICK VENEER ANGLE CORNER 3" = 1'-0"


SHKSARCHITECTS

1050 N. 38th St. Seattle, WA 98103 рн: 206.675.9151 www.shksarchitects.com 5158 REGISTERED ARCHITECT JONATHAN H. HARTUNG STATE OF WASHINGTON — _ KCHA - GUSTAVES MANOR ⁻ ENVELOPE UPGRADE - BID SET 107 W MAIN ST — Auburn, wa 98001 Drawn by: Checked: LJ _____ 03/08/2022 Date: As indicated Scale: Revisions: Remarks <u>No.</u> Date ___ 1 2.23.22 ASI-01 ____ DETAILS

A4.4




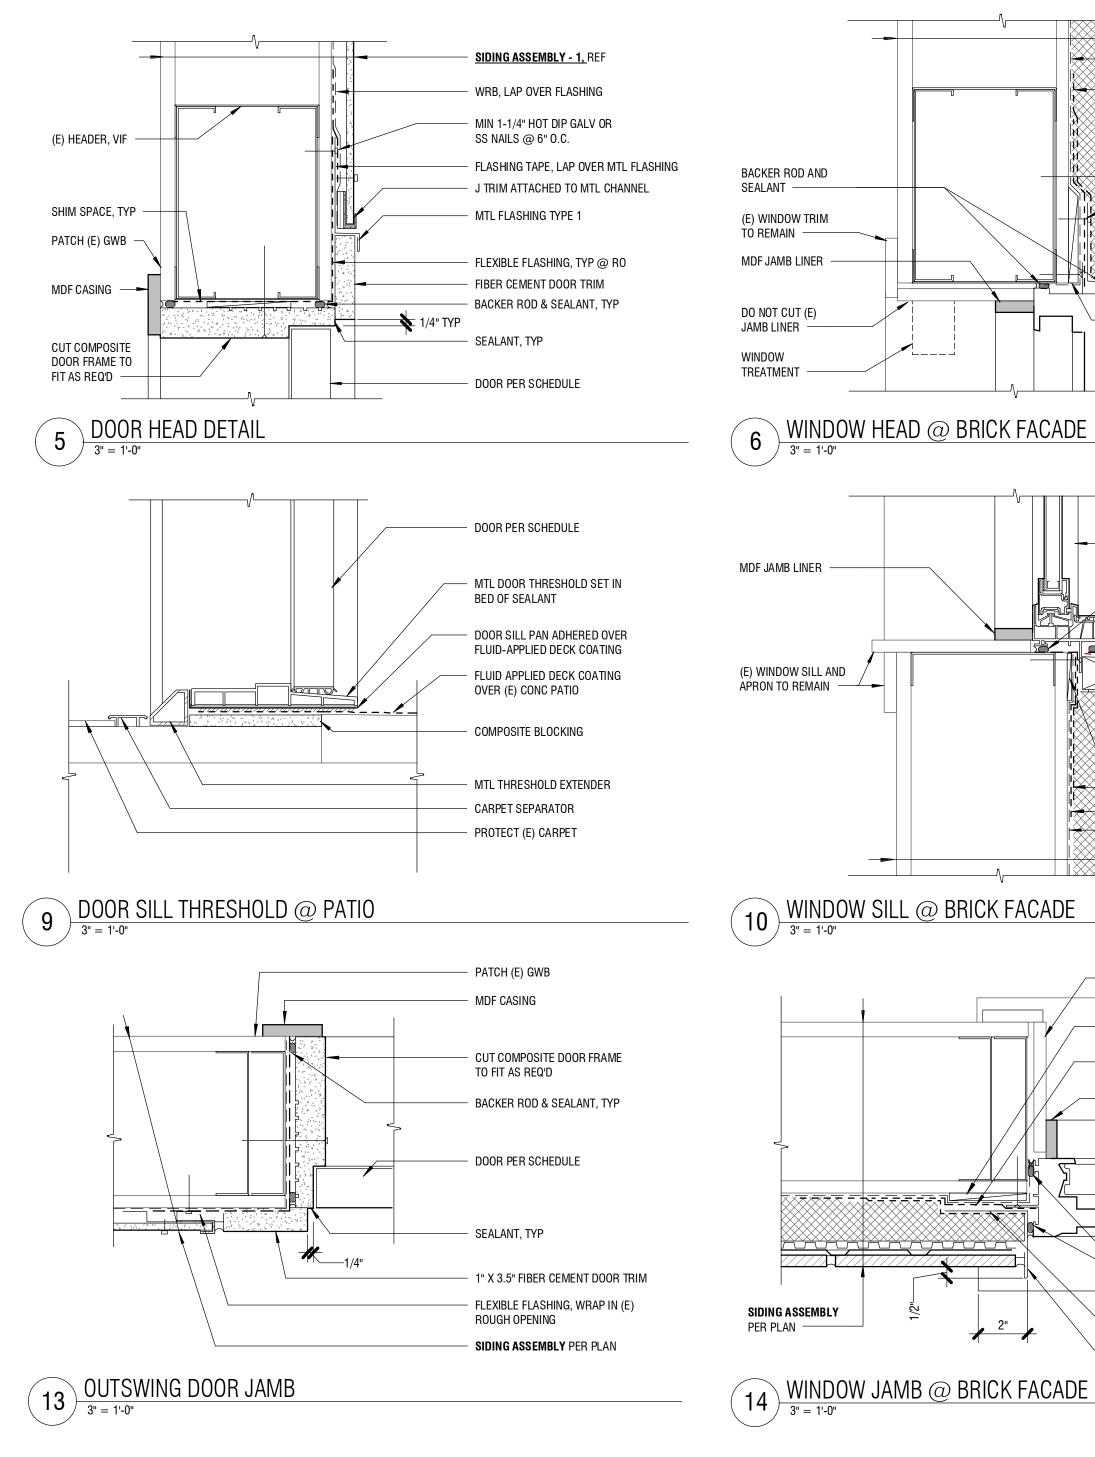

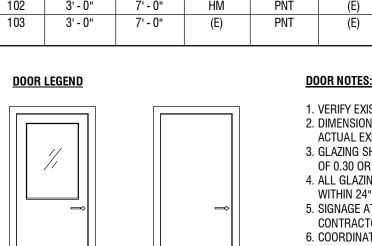

TYPE 102

TYPE 101

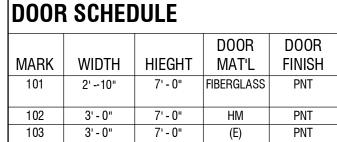



2"



- DO NOT CUT (E) JAMB LINER

BLOCKING AT NAIL FLANGE TO ALIGN

WINDOW TO (E) JAMB LINER DEPTH

WINDOW ASSEMBLY PER SCHEDULE

SOLDERED MTL FLASHING SILL BELOW

FLASHING TAPE OVER MTL FLASHING


BACKER ROD & SEALANT

MTL FLASHING TYPE 8

FLEXIBLE FLASHING, LAP OVER

NAILING FIN

WD JAMB LINER

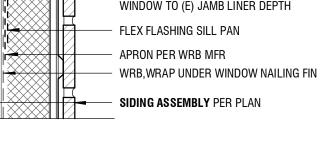

SLOPED TO DRAIN ∕¥-¥ -1/2" BLOCKING AT NAIL FLANGE TO ALIGN WINDOW TO (E) JAMB LINER DEPTH

WINDOW ASSEMBLY PER SCHEDULE - BACKER ROD & SEALANT – 2X WD SILL SOLDERED MTL FLASHING SILL,

MTL FLASHING TYPE 1

- MIN 1-1/4" HOT DIP GALV OR SS NAILS @ 6" O.C. —1/2'

BLOCKING AT NAIL FLANGE TO ALIGN

WINDOW TO (E) JAMB LINER DEPTH

WINDOW ASSEMBLY PER SCHEDULE

(E) HEADER

SEALANT -

REMAIN -

LINER -

11

BACKER ROD AND

(E) WINDOW TRIM TO

DO NOT CUT (E) JAMB

WINDOW TREATMENT

WINDOW HEAD

3" = 1'-0"

WD JAMB LINER

 FLASHING TAPE, LAP OVER MTL FLASHING

SIDING ASSEMBLY PER PLAN WRB, WRAP INTO (E) ROUGH OPENING

7. PROVIDE CONTINUOUS AIR SEAL AT ALL WINDOWS, DOORS, WALL AND ROOF PENETRATIONS. 8. SALVAGE EXISTING DOOR LOCKSET CORES, RETURN TO OWNER.

6. COORDINATE HARDWARE GROUPS WITH OWNER. REPLACE NECESSARY EGRESS HARDWARE.

1. VERIFY EXISTING OPERABLE DIRECTIONS AND PROVIDE NEW DOORS TO MATCH. 2. DIMENSIONS SHOWN ARE FOR REFERENCE ONLY. CONTRACTOR TO FIELD VERIFY ACTUAL EXISTING OPENING DIMENSIONS AFTER OPENING MODIFICATIONS. 3. GLAZING SHALL BE LABELED & NFRC CERTIFIED PER MFR, AND HAVE A U-VALUE OF 0.30 OR BETTER, PER MFR, TYP. DOORS TO BE R-5 OR BETTER. 4. ALL GLAZING WITHIN 18" OF INTERIOR FLOOR, EXTERIOR WALKING SURFACE, OR WITHIN 24" OF A DOOR IN ANY POSITION TO BE SAFETY/TEMPERED GLASS. 5. SIGNAGE AT ENTRY DOOR(S) TO BE FURNISHED BY OWNER, INSTALLED BY CONTRACTOR (FOIC).

FRAME	FRAME	
MATL	FINISH	COMMENTS
FIBER CEMENT	PNT	HALF-LITE, TYP UNIT DOOR @ PATIOS
(E)	PNT	
(E)	PNT	REPLACE THRESHOLD AND HARDWARE ONLY, CUT (E) DOOR TO FIT


6" MIN LAP SIDING ASSEMBLY PER PLAN -----FLEXIBLE FLASHING, LAP OVER NAILING FIN 15 WINDOW JAMB 3" = 1'-0"

WINDOW ASSEMBLY PER SCHEDULE BLOCKING AT NAIL FLANGE TO ALIGN WINDOW TO (E) JAMB LINER DEPTH WINDOW TRIM, ROUTE FOR NAIL FLANGE

- DO NOT CUT (E) JAMB LINER

BACKER ROD & SEALANT

WD JAMB LINER

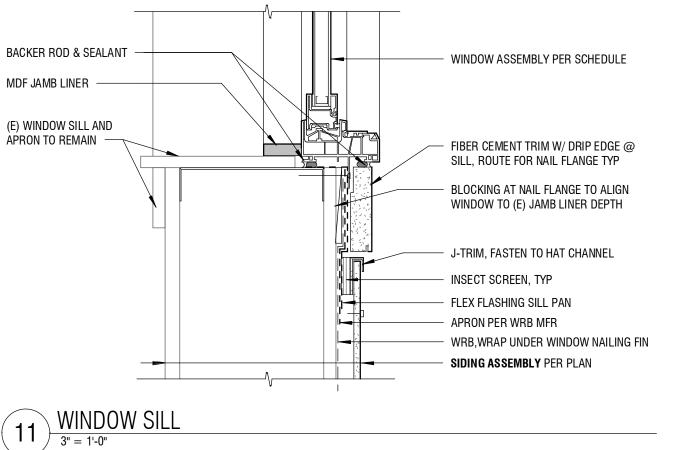

//II |===

ALIGN

WINDOW TO (E) JAMB LINER DEPTH WINDOW ASSEMBLY PER SCHEDULE

SIDING ASSEMBLY PER PLAN

MIN 1-1/4" HOT DIP GALV OR

TRIM W/ FACE OF WINDOW

MTL FLASHING TYPE 1

SS NAILS @ 6" 0.C.

INSECT SCREEN

WRB WRAPS INTO (E) ROUGH OPENING

FLASHING TAPE, LAP OVER MTL FLASHING

SHIM AS NEEDED TO ALIGN FACE HEADER


FIBER CEMENT WINDOW HEADER TRIM

BLOCKING AT NAIL FLANGE TO ALIGN

WINDOW LEGEND

WINDOW SC

MARK OPERATION W1 SINGLE HUNG W2 SINGLE HUNG W3 SINGLE HUNG W4 SINGLE HUNG W5 SINGLE HUNG

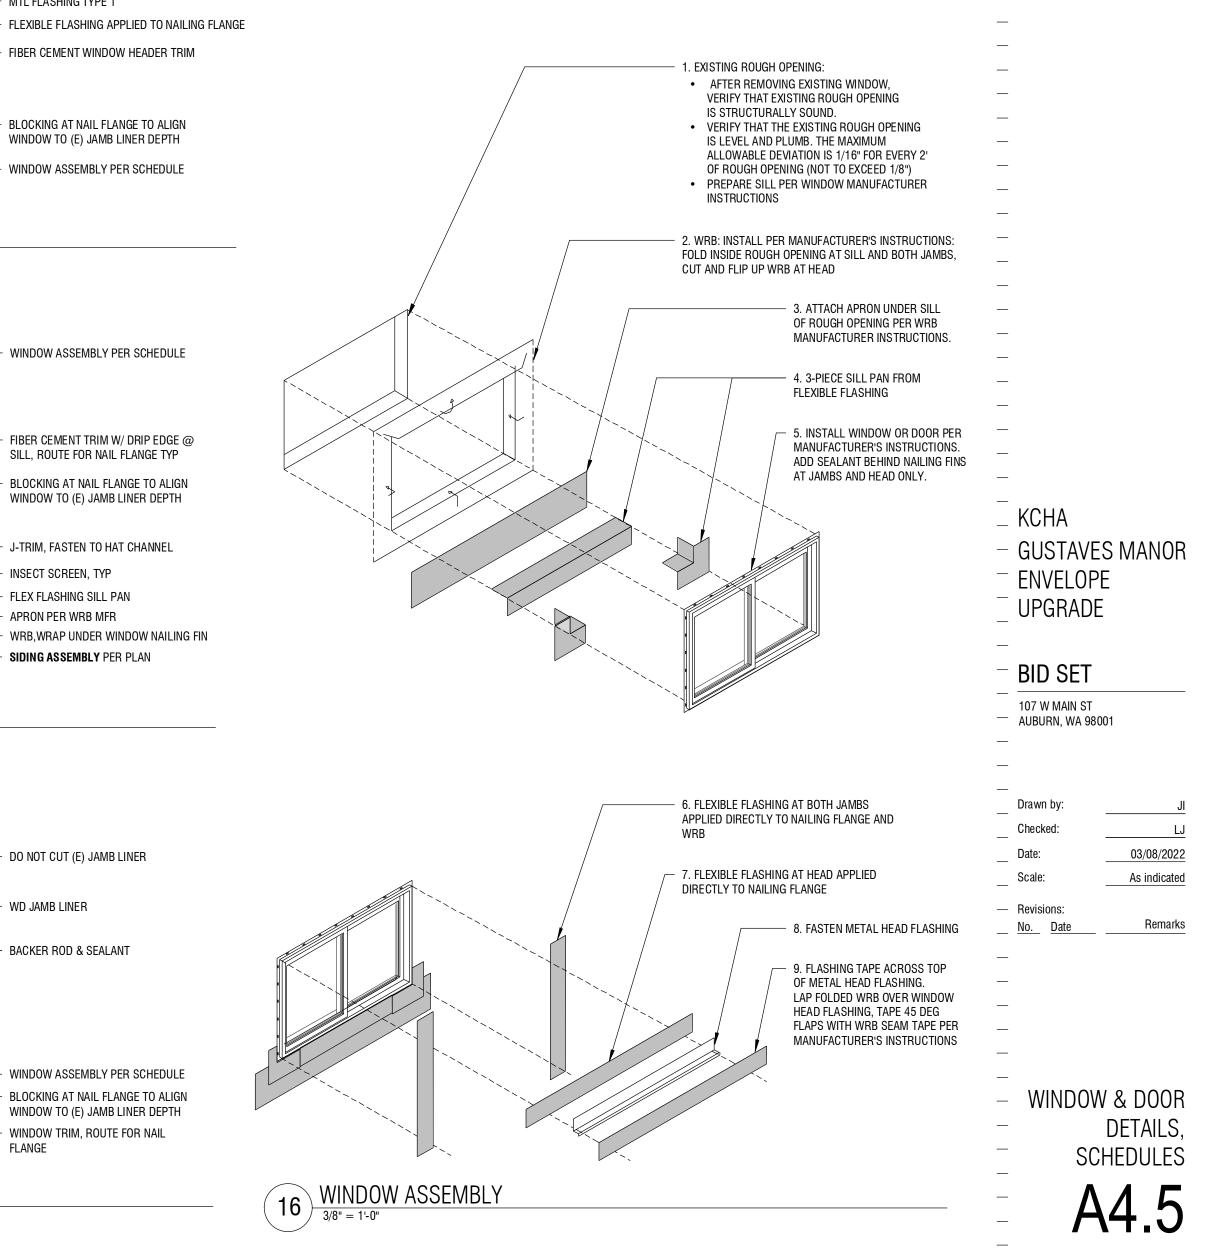

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Seattle, WA 98103

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REGISTEREI

ARCHITEC

JONATHAN H. HARTUNC

STATE OF WASHINGTO

CHEDULE					
			U-VALUE		
N	WIDTH	HEIGHT	(MIN)	COMMENTS	MARK
	5' - 3"	5' - 6"	0.30	NEW WINDOW TO FIT WITHIN (E) OPENING	W1
	2' - 3"	5' - 6"	0.30	NEW WINDOW TO FIT WITHIN (E) OPENING	W2
	4' - 0"	5' - 2"	0.30	SAFETY GLAZING, NEW WINDOW TO FIT WITHIN (E) OPENING	W3
	3' - 0"	5' - 2"	0.30	SAFETY GLAZING, NEW WINDOW TO FIT WITHIN (E) OPENING	W4
	3' - 0"	6' - 0"	0.30	NEW WINDOW TO FIT WITHIN (E) OPENING	W5


WINDOW NOTES:

1. DIMENSIONS SHOWN ARE FOR REFERENCE ONLY. CONTRACTOR TO FIELD VERIFY ACTUAL


- DIMENSIONS. 2. ALL SINGLE-HUNG WINDOWS TO HAVE SIMULATED DIVIDED LITES AT UPPER SASH. MATCH GRID STYLE OF EXISTING WINDOWS TO REMAIN AT MASONRY BUILDING.
- 3. AT OPERABLE WINDOWS, OPERABLE SASH TO MATCH EXISTING WINDOWS.
- 4. ALL GLAZING SHALL BE LABELED & NFRC CERTIFIED PER MFR. ALL GLAZING WITHIN 18" OF INTERIOR FLOOR/ EXTERIOR WALKING SURFACE OR WITHIN 24" OF A DOOR IN ANY POSITION TO BE TEMPERED. 5. ALL GLAZING SHALL HAVE A U-VALUE OF 0.30 OR BETTER, PER MFR, TYP.
- 6. PROVIDE CONTINUOUS AIR SEAL AT ALL WINDOWS, DOORS, WALL AND ROOF PENETRATIONS. 7. SCREENS TO BE PROVIDED WITH ALL OPERABLE WINDOWS.
- 8. PROVIDE PASSIVE FRESH AIR VENTILATION SYSTEM AT ALL WINDOWS MEETING WASHINGTON STATE ENERGY CODE FOR FRESH AIR VENTILATION.
- 9. HORIZONTAL BLINDS TO BE PROVIDED AT ALL WINDOWS.

EGRESS NOTE:

ORIGINAL WINDOW INSTALLATIONS COMPLIED WITH APPLICABLE EGRESS CODES UPON COMPLETION. AS SUCH, REPLACEMENT WINDOWS WILL BE SET AS LOW AS POSSIBLE IN EXISTING OPENINGS, WHICH ARE NOT REQUIRED TO BE RE-FRAMED TO MEET CURRENT EGRESS HEIGHT.

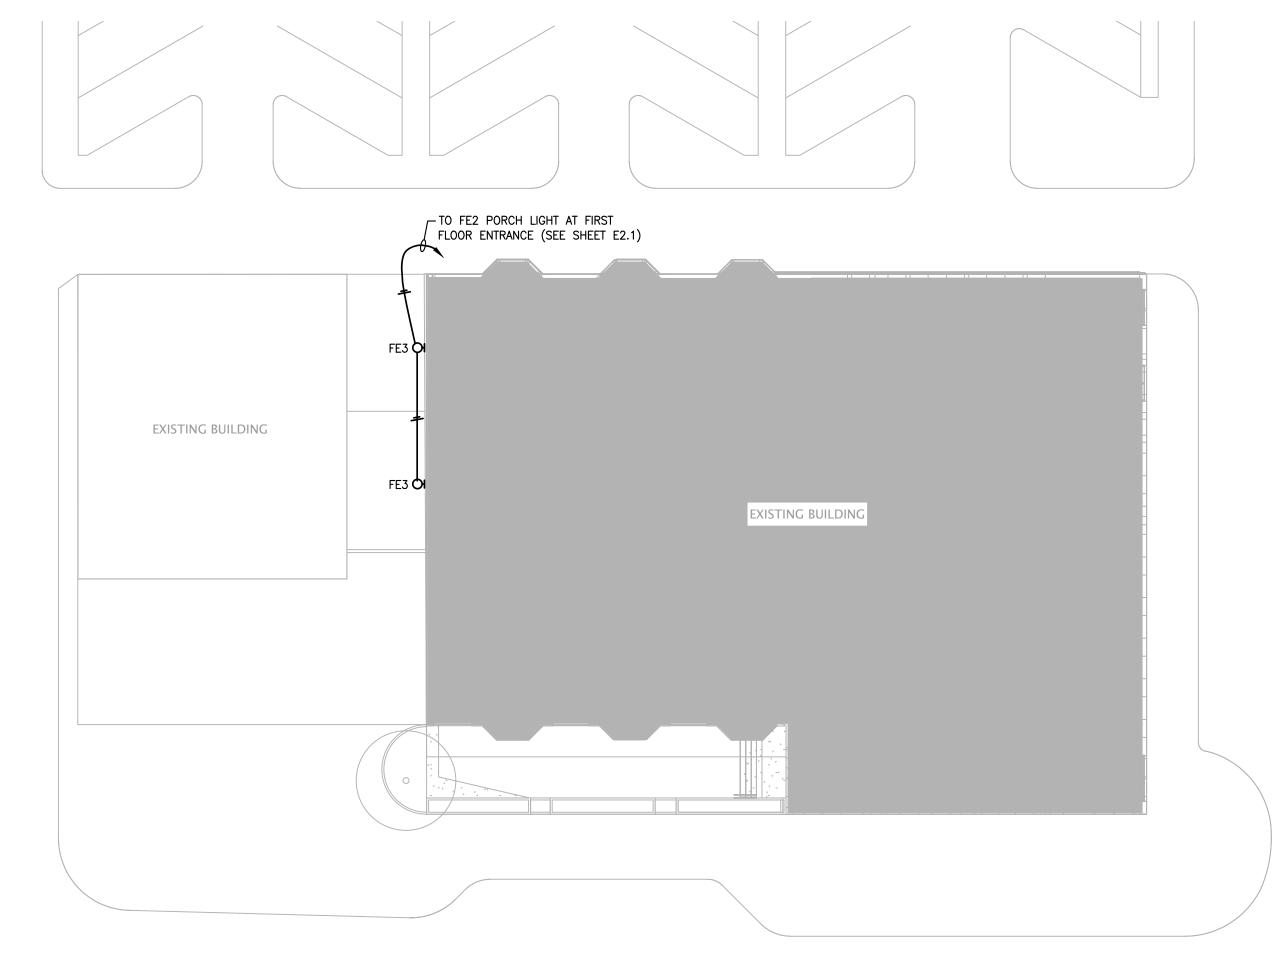


WEST MAIN STREET

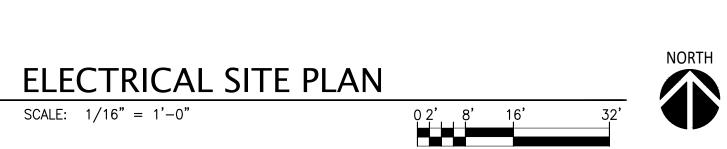

ROOFTOP PV SYSTEM REMOVAL

DE-ENERGIZE, SALVAGE AND DE-CONSTRUCT EXISTING ROOFTOP SOLAR ARRAY, RACKS AND ELECTRICAL CONNECTIONS BY QUALIFIED PERSONS. PROTECT AND STAGE MATERIAL FOR RE-INSTALLATION AFTER NEW ROOF INSTALLATION. CONTRACTOR TO RESTORE SOLAR ARRAY TO EXISTING OPERABLE CONDITION. CONTRACTOR TO PROVIDE PARTS AND PROVISIONS NEEDED FOR RESTORATION. CONTRACTOR TO PROVIDE REQUIRED PERMITTING BY AREA HAVING JURISDICTION AND FOR ELECTRICAL UTILITY INTERCONNECTION STANDARDS.



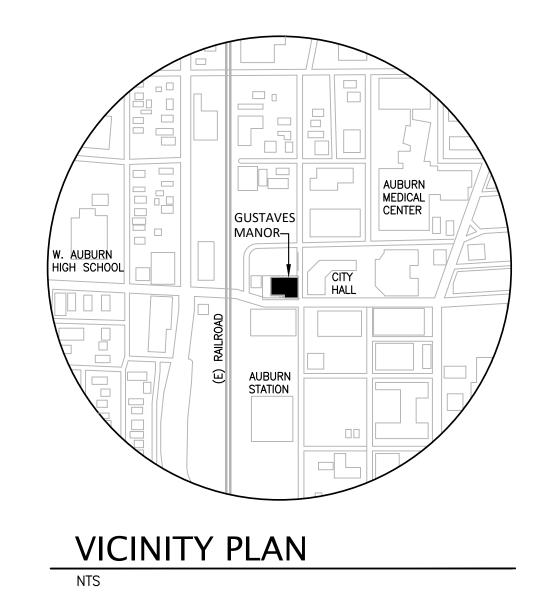

32' 	

L	&	INS	TAL	LAT	ION
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LIGHTING FIXTURE SCHEDULE

TYPE	DESCRIPTION	LAMP	WATTS/ FIXT
	EXTERIOR		
FE1	CEILING SURFACE MOUNTED PORCH LIGHT, RECTANGULAR, NOMINALLY 11" x 7" x 4" DEEP, WITH OPAL LENS, 596 LUMENS, 3500K, 80 CRI WITH BACKBOX SUITABLE FOR SIDE CONDUIT ENTRY. LUMINAIRE LED SWP610 CAB	LED	8
FE2	WALL MOUNTED MAN DOOR LIGHT, SIMILAR TO FE1 EXCEPT WITH EYELID VISOR AND EMERGENCY BACK UP. OPAL LENS, 506 LUMENS, 3500K, 80 CRI LUMINAIRE LED YWP610	LED	14
FE3	WALL MOUNTED SECURITY LIGHT, TYPE II DISTRIUBTION, 4759 LUMENS, 4000K 80 CRI, WITH INTERGRAL MOTION SENSOR AND DIMMING DRIVER. MOTION SENSOR TO DIM TO 50 PECENT WHEN NOT SENSING MOTION. COOPER MCGRAW EDISON GWC SA1 B800mA 740 T2 MS/DIM	LED	44
FE4	WALL MOUNTED MAN DOOR LIGHT, SIMILAR TO FE1 EXCEPT WITH EYELID VISOR AND EMERGENCY BACK UP. OPAL LENS, 506 LUMENS, 3500K, 80 CRI WITH EMERGENCY BATTERY BACK UP. LUMINAIRE LED YWP610	LED	14
FE5	SURFACE MOUNTED VAPORTIGHT LINEAR LED, OPAL LENS, 2971 LUMENS PER 4' LINEAR LENGTH, 3500K, 80 CRI WITH HOUSING FINISH AS SELECTED BY ARCHITECT. LUMINAIRE VPF8L16 SERIES	LED PER 8'	50
	NOTE: ALL EXTERIOR LIGHTING VIA EXISITNG TIMECLOCK		

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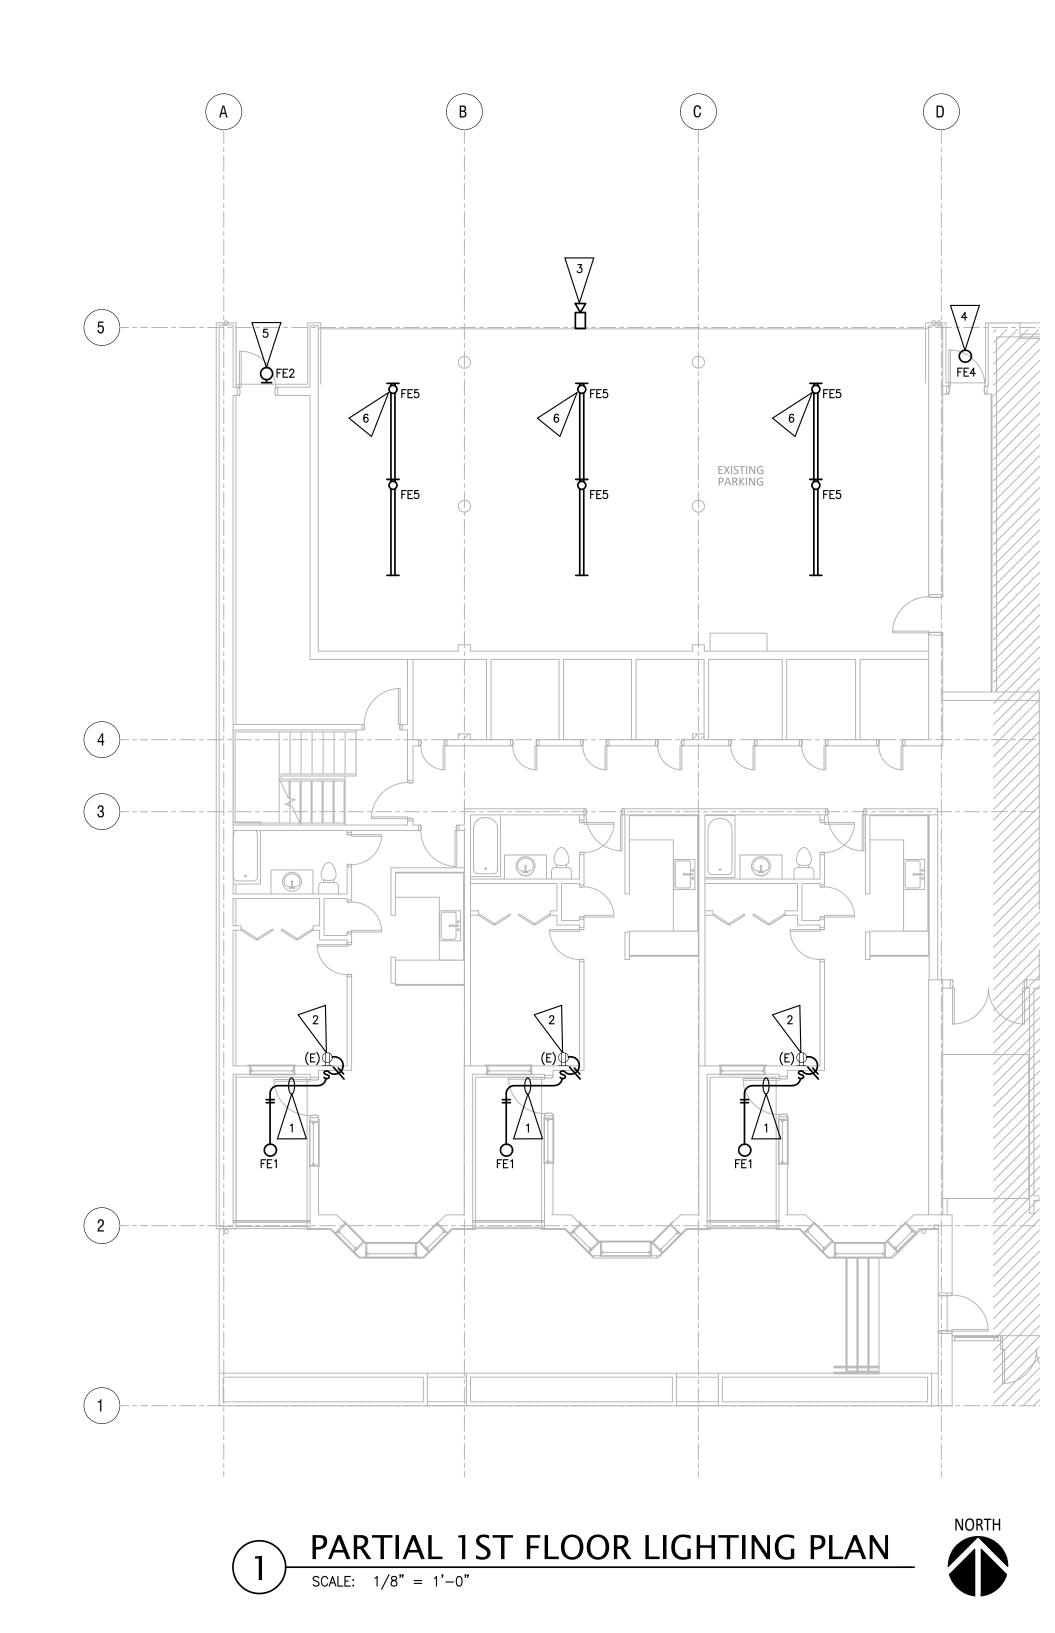
	ELECTRICAL LEGEND
POWER D	EVICES AND EQUIPMENT
	UPLEX GFCI RECEPTACLE
-	OUBLE DUPLEX GFCI RECEPTACLE
	FCI WEATHER RESISTANT RECEPTACLE WITH /EATHERPROOF WHILE-IN-USE COVER
() J	UNCTION BOX WITH BLANK COVER
LIGHT FIX	TURES & CONTROLS
O s	URFACE CEILING MOUNTED DOWNLIGHT
Q s	INGLE POINT SOURCE WALL MOUNTED FIXTURE
S S	INGLE POLE LIGHT SWITCH
CONDUITS	AND CIRCUITING
	- WIRING CONCEALED IN CEILING OR WALL
	- WIRING CONCEALED UNDER FLOOR OR UNDERGROUND - CONDUIT HOME-RUN
	- CONDUCTORS IN CONDUIT
Iı.	GROUND CONDUCTOR
C	
	· · · · · · · · · · · · · · · · · · ·
\$	
	SYSTEM EQUIPMENT SECURITY CAMERA
NOTES AN	D MISCELLANEOUS SYMBOLS
3	FLAGNOTE - IDENTIFIES A SPECIFIC ITEM ON A DRAWING.
0	COORESPONDS TO A SCHEDULE IN THE ELECTRICAL SET THAT EXPLAINS DETAILS OR FEATURES OF THAT ITEM.
(3)	DETAIL NUMBER – APPEARS IN FRONT OF A TITLE ON DRAWINGS WITH MORE THAN ONE ILLUSTRATION.
	REVISION CLOUD & FLAG - CLOUD SURROUNDS INFORMATION THAT HAS BEEN REVISED. FLAG NOTES THE REVISION IN WHICH THE CHANGES WERE MADE.
ABBREVI	ATIONS
A (200A)	(AFTER A NUMBER) = AMPS
``) (AFTER A NUMBER) = FUSE SIZE IN AMPS
AHJ AL	AUTHORITY HAVING JURISDICTION ALUMINUM
BKR	BREAKER
С	CONDUIT
CKT CU	CIRCUIT COPPER
DISC	DISCONNECT
E.C.	ELECTRICAL CONTRACTOR
(E)	EXISTING (USED AS SYMBOL DESIGNATION)
EMT EXTG	ELECTRICAL METALLIC TUBING EXISTING (USED AS ABBREVIATION IN TEXT)
F.O.I.C.	FURNISHED BY OTHERS, INSTALLED
~-	BY ELECTRICAL CONTRACTOR
GFCI GND	GROUND FAULT CIRCUIT INTERRUPTER GROUND
kCMIL	GROUND THOUSANDS OF CIRCULAR MILS
KVA	1000 VOLT AMPERES
KW	1000 WATTS
MCB MLO	MAIN CIRCUIT BREAKER MAIN LUGS ONLY
NIC	NOT IN CONTRACT
NREC	NON-RESIDENTIAL ENERGY CODE
PNL	PANELBOARD
REC	RECEPTACLE(S)
SW TBD	SWITCH TO BE DETERMINED
TYP	TYPICAL
U.O.N.	UNLESS OTHERWISE NOTED
VA	VOLT AMPERES
WD	WATTS
WP XFMR	WEATHERPROOF TRANSFORMER

DRAWING INDEX

E1.1 LEGEND, ELECTRICAL SITE PLAN, LTG FIXTURE SCHEDULE E2.1 1ST & 2ND FLOOR LIGHTING PLANS E2.2 3RD THRU 5TH FLOOR TYPICAL LIGHTING PLAN

_ _ _	
_ _ _	
_ _ _	1050 N. 38th St. Seattle, WA 98103
_ _ _	РН: 206.675.9151 www.shksarchitects.com
_ _ _	
_ _ _	Consulting Electrical Engineers 19515 North Creek Parkway, Suite 302 Bothell, WA 98011 425-402-9400 office@caseeng.com 21030
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_ _ _	
	КСНА
_	GUSTAVES MANOR ENVELOPE UPGRADE
- - - -	BID SET 107 W MAIN ST AUBURN, WA 98002
_	Drawn by: CJP Checked: MSC Date: 5-28-2021
_	Scale: Noted Revisions: No. Date Remarks
	SYMBOL LEGEND, ELECTRICAL SITE PLAN AND
_ _ _ _	LIGHTING SCHED.







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Seattle, WA 98103

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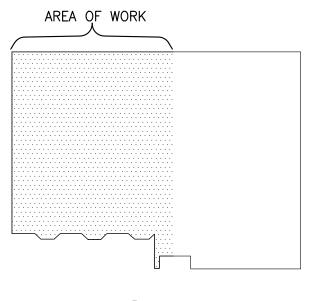
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BUILDING KEY PLAN

NTS

FLAG NOTES

1	SURFACE MOUNT CONDUIT TO CONCRETE DECK ABOVE. ROUTE CONDUIT PARALLEL TO BUILDING LINES.

CONNECT SWITCH AND LIGHTING FIXTURE TO THE 2 NEAREST EXISTING RECEPTACLE CIRCUIT.

3 REMOVE AND REINSTALL EXISTING SECURITY CAMERA. COORDINATE MOUNTING WITH SIDING VENDOR AND CONCEAL VERTICAL RACEWAY.

REPLACE EXISTING SURFACE MOUNTED LIGHTING FIXTURE WITH NEW FE4 FIXTURE INDICATED. CONNECT 4 NEW FIXTURE TO EXISTING CIRCUIT. NET DECREASE IN LOAD.

5 REPLACE EXISTING SURFACE MOUNTED LIGHTING WITH NEW FE2 FIXTURE INDICATED. CONNECT NEW FIXTURE TO EXISTING CIRCUIT. NET DECREASE IN LOAD.

REPLACE EXISTING SURFACE MOUNTED LIGHTING WITH 6 NEW FE5 FIXTURE INDICATED. CONNECT NEW FIXTURE TO EXISTING CIRCUIT. NET DECREASE IN LOAD.

— ph: 206.675.9151 www.shksarchitects.com _ Consulting Electrical Engineers 19515 North Creek Parkway, Suite 302 Bothell, WA 98011 425-402-9400 office@caseeng.com


21030



- GUSTAVES MANOR
- _ ENVELOPE
 _ UPGRADE

[–] BID SET

_ _ — 107 W MAIN ST — AUBURN, WA 98002 CJP MSC Drawn by Checked 5-28-2021 Date: Noted Scale: Revisions: Remarks <u>No.</u> <u>Date</u> _ 1ST & 2ND FLOOR - LIGHTING PLANS E2.1

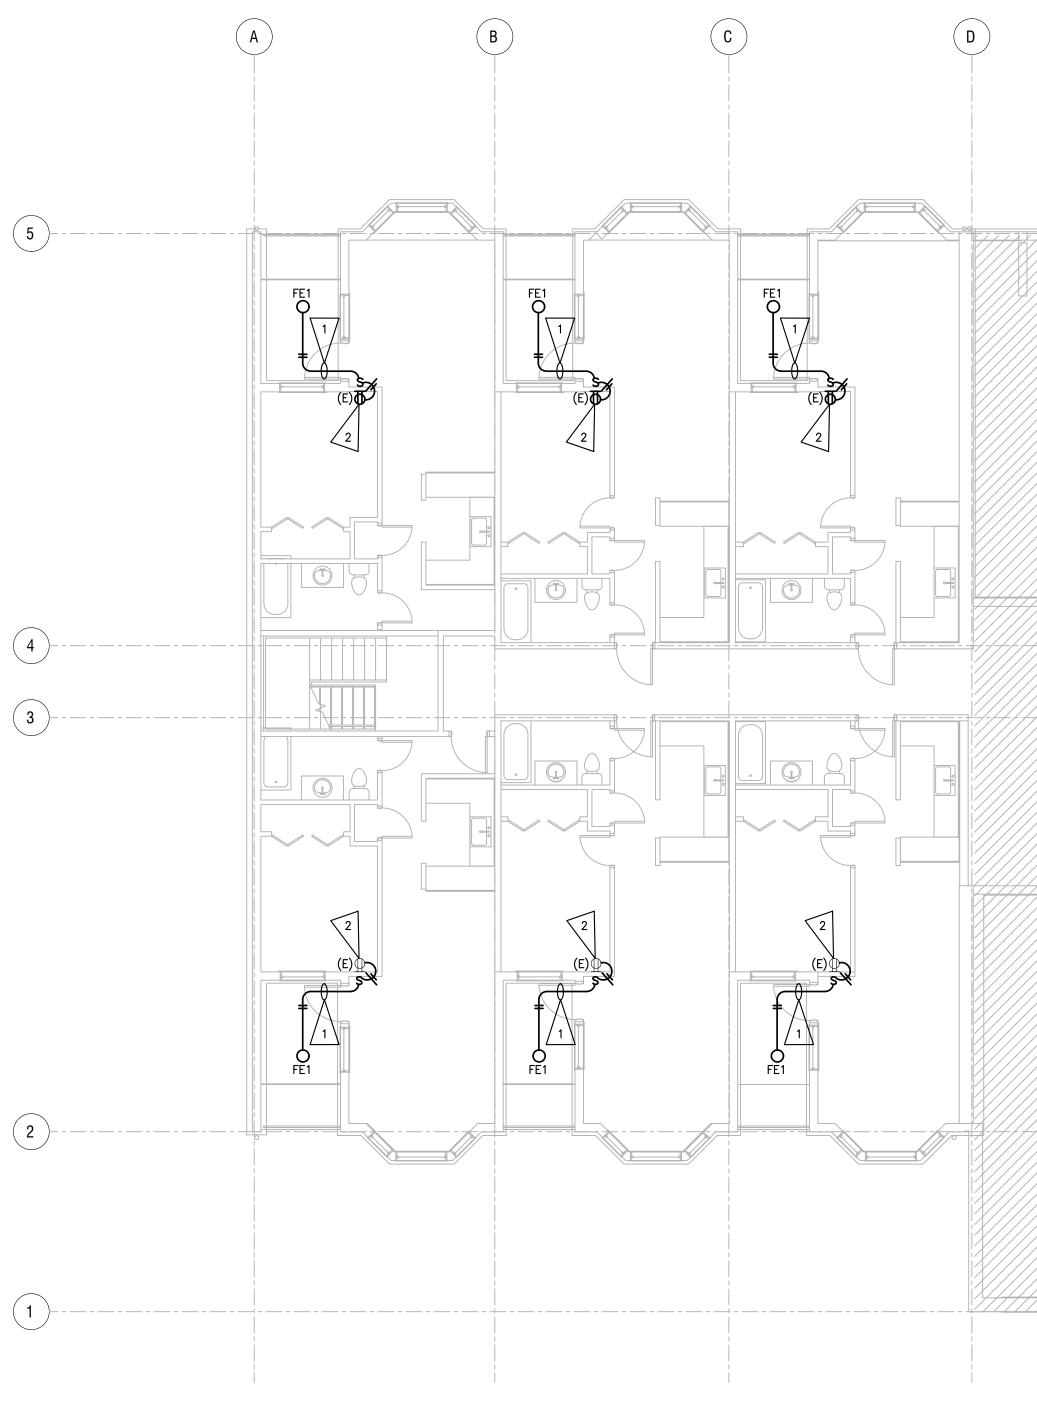

PARTIAL 3RD-5TH FLOOR (TYPICAL) LIGHTING PLAN SCALE: 1/8" = 1'-0"





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www.shksarchitects.com

Consulting Electrical Engineers 19515 North Creek Parkway, Suite 302 Bothell, WA 98011 425-402-9400 office@caseeng.com

21030

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_ KCHA

_ ENVELOPE _ UPGRADE

⁻ BID SET

107 W MAIN ST AUBURN, WA 98002

___ Drawn by:

___ Checked:

— Revisions:

<u>No.</u> Date

– THIRD-FIFTH FLOOR

LIGHTING PLAN

E2.2

___ Date: ____ Scale:

_

—


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– GUSTAVES MANOR

CJP MSC

5-28-2021 Noted

Remarks

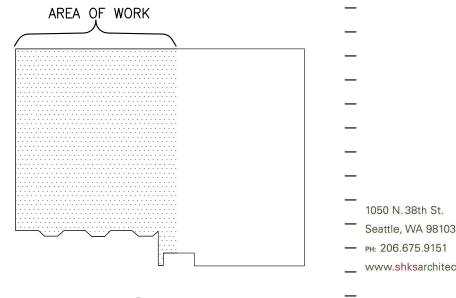

BUILDING KEY PLAN NTS

FLAG NOTES

SURFACE MOUNT CONDUIT TO CONCRETE DECK ABOVE. ROUTE CONDUIT PARALLEL TO BUILDING LINES. |1>

CONNECT SWITCH AND LIGHTING FIXTURE TO THE NEAREST EXISTING RECEPTACLE CIRCUIT. 2