KCHA CEDAR GROVE BUILDING A, B & C ROOF REPLACEMENT

ABBREVIATIONS

& L @ J # (E) ₽ A.B. ABV AC ACP ACU ADJ AFF ALT ALUM	AND ANGLE AT DIAMETER POUND OR NUMBER EXISTING CENTERLINE PROPERTY LINE ANCHOR BOLT ABOVE AIR CONDITIONING ACOUSTIC CEILING PANEL AIR CONDITION UNIT ADJUSTABLE ABOVE FINISHED FLOOR ALTERNATE ALUMINUM
APPROX ARCH BLDG BLW BM B.O. BRS	APPROXIMATELY ARCHITECT, ARCHITECTURAL BUILDING BELOW BEAM BOTTOM OF BACKER ROD & SEALANT
CB CBB CL CL CLG CLR CO COL CONC CONC CONT CPT CT CT CTR	CATCH BASIN CEMENT BACKER BOARD CEMENT CONTROL JOINT CENTERLINE CEILING CLEAR CLEAN OUT COLUMN CONCRETE CONDITION CONTINUOUS CARPET CERAMIC TILE CENTER
DBL DEMO DF DIA DIFF DIM DISP DN DR DR DS DTL DW	DOUBLE DEMOLISH DRINKING FOUNTAIN DIAMETER DIFFUSER DIMENSION DISPENSER DOWN DOOR DOWNSPOUT DETAIL DISHWASHER
E EA ECS EJ EL ELEC ELEV EMERG EQ EXP	EAST EACH EXTERIOR COMPOSITE SIDING EXHAUST FAN EXPANSION JOINT ELEVATION ELECTRICAL ELEVATOR EMERGENCY EQUAL EXPANSION
FBP FD FE FF FH FIN FLR F.O. FOIC FOIO FR FS FT	FIBER BOARD PANEL FLOOR DRAIN FIRE EXTINGUISHER FINISH FLOOR FIRE HYDRANT FINISH FLOOR FACE OF FURNISHED BY OWNER, INSTALL BY CONTRACTOR FURNISHED BY OWNER INSTALL BY OWNER FIRE RESISTANT FLOOR SINK FEET

GA	GAUGE
GALV	GALVANIZED
GB	GRAB BAR
GC	GENERAL CONTRACTOR
GL	GLASS
GLB	GLU-LAM BEAM
GND	GROUND
GR	GRADE
GRT'D	GROUTED
GWB	GYPSUM WALL BOARD
HB	HOSE BIBB
HC	Handicap
HCMU	Hollow Clay Masonry Unit
HDWD	Hardwood
HDWE	Hardware
HT	Height
HM	Hollow Metal
HR	Hour
HORIZ	Horizontal
I.D.	Inside diameter
Insul	Insulation
Int	Interior
JAN	Janitor
Jt	Joint
KIT	KITCHEN
LAB	LABORATORY
LAM	LAMINATE
LAV	LAVATORY
LKR	LOCKER
LOC	LOCATE
LT	LIGHT
LVL	LAMINATED VENEER LUMBER
M MATL MAX MC MECH MEMB MFR MIN MIR MIR MISC MH MISC MH MTD MTL MULL	MEN'S MATERIAL MAXIMUM MEDICINE CABINET MECHANICAL MEMBRANE MANUFACTURER MINIMUM MIRROR MISCELLANEOUS MANHOLE MASONRY OPENING MOUNTED METAL MULLION
N	NORTH
NA	NOT APPLICABLE
NIC	NOT IN CONTRACT
NOM	NOMINAL
NTS	NOT TO SCALE
NR	NOT RATED
OA	OVERALL
OBS	OBSCURE
O.C.	ON CENTER
O.D.	OUTSIDE DIAMETER
OFF	OFFICE
OPNG	OPENING
OPP	OPPOSITE
PC	PRECAST CONCRETE
PL	PLATE
PLAS	PLASTER
PLY	PLYWOOD
P.LAM	PLASTIC LAMINATE
PNT	PAINT
POC	POINT OF CONNECTION
PR	PAIR
PSL	PARALLEL STRAND LUMBER
PT	PRESSURE TREATED
PTN	PARTITION
QT	QUARRY TILE


or RAD FP FF FR INF LOC Q'D S M	RADIUS RESILIENT BASE REFLECTED CEILING PLAN ROOF DRAIN REFERENCE REFRIGERATOR REINFORCED RELOCATE REQUIRED RESILIENT ROOM ROUGH OPENING ROOF VENT RAIN WATER LEADER
HED CT T MEC S. A D L N OR RUCT SP M	SOUTH SMOKE ALARM SOLID CORE SCHEDULE SECTION SAFETY GLASS SHEET SIMILAR SPECIFICATION SQUARE STAINLESS STEEL STATION STANDARD STEEL STAIN STORAGE STRUCTURE SLAB ON GRADE SUSPENDED SYMMETRICAL
TMP G L R K D.	TEMPERED TONGUE & GROOVE TELEPHONE TERRAZZO THICK TOP OF TUBE STEEL TELEVISION TYPICAL
10 11	UNDERWRITERS' LABORAT UNLESS NOTED OTHERWIS UTILITY
T RT ST F R	VINYL COMPOSITION TILE Vertical Vestibule Verify in field Vent thru roof
/ C D F N O D M M P R S C T F	WEST WITH WATER CLOSET WOOD WIDE FLANGE WINDOW WITHOUT WALK OFF MAT WOMEN'S WATER RESISTANT WAINSCOT WEIGHT

	A101
	1 SIM
	A101
3	
	1 A101 1
	1
	1 (A101) 1
	1
	1 A101 SIM
	\bigcirc
	0
	ROOM NAME
	(1t)
Boratories Ierwise	R1
N TILE	C 1
	T.0. XXX
	Q
	XXX_XXX
	DESCRIPTION
	\
	\oplus

DRAFTING SYMBOLS 1 SIM WALL SECTION

1 A101	WALL SECTION
1 A101	BLDG SECTION
1 A101 1	EXTERIOR ELEVATION
1 A101 1	INTERIOR ELEVATION
1 A101	DETAIL
	NORTH ARROW
0	GRID HEAD
ROOM NAME	ROOM TAG
(1t)	WINDOW & STOREFRONT TAG
R1	FLOOR, WALL, OR ROOF TAG
C1>	CASEWORK TAG
	DOOR TAG
	KEY NOTE
	ELEVATION NOTE
XXX T.O. XXX	SPOT ELEVATION
	CENTERLINE
- <u>P</u> - <u>P</u> - <u>-</u>	PROPERTY LINE
	FLOOR TRANSITION
	REVISION
\	BREAKLINE
Φ	DIMENSION POINT
	ENLARGED DETAIL CALLOUT

MATERIAL SYMBOLS

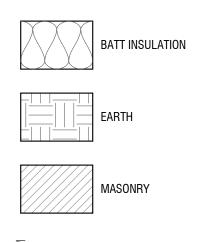

CONCRETE
GRAVEL
PLYWOOD

RIGID INSULATION





GENERAL NOTES

- WHERE CONFLICTS OCCUB. THE SCOPE OF WORK TAKES PRECEDENCE OVER SPECIFICATIONS. AND SPECIFICATIONS TAKE PRECEDENCE OVER DRAWINGS
- MATERIALS, ASSEMBLIES AND NOTED ITEMS ARE NEW UNLESS OTHERWISE NOTE
- 9. CONTRACTOR SHALL VERIFY CONDITIONS. NOTIFY THE ARCHITECT OF ANY CONDITIONS INCONSISTENT WITH THE INTENT OF THE DRAWINGS PRIOR TO STARTING OR CONTINUING WORK IN THE AREA CONCERNED
- 4. DO NOT DISCONNECT POWER, DATA OR CABLE DURING CONSTRUCTION, COORDINATE REQUIRED SHUTDOWNS WITH OWNE

- 1. ALL WORK SHALL CONFORM TO APPLICABLE CODES AND LOCAL BUILDING REQUIREMENTS, WHICH INCLUDE THE MOST CURRENT EDITIONS O THE INTERNATIONAL BUILDING CODE WITH LOCAL AMENDMENTS, INTERNATIONAL MECHANICAL CODE (IMC), NATIONAL ELECTRICAL CODE (NEC) INTERNATIONAL FIRE CODE (IFC), AND WASHINGTON STATE ENERGY CODE (WEC)
- 2. PER 602.1 LEVEL 1 ALTERATIONS INCLUDE REMOVAL AND REPLACEMENT OR THE COVERING OF EXISTING MATERIALS, ELEMENTS, EQUIPMENT OR FIXTURES UISNG NEW MATERIALS, ELEMENTS, EQUIPMENT OR FIXTURES THAT SERVE THE SAME PURPOSE.PER 701.2 AN EXISTING BUILDING OR
- PORTION THEREOF SHALL NOT BE ALTERED SUCH THAT BUILDING BECOMES LESS SAFE THAN ITS EXISTING CONDITION. 3. PER SEC R503.1.1 EXCEPTION 2, THE BUILDING ENVELOPE ALTERATION IS NOT REQUIRED TO MEET NEW CONSTRUCTION BECAUSE THE WALL AND ROOF CAVITIES EXPOSED DURING CONSTRUCTION SHALL BE FILLED WITH INSULATION.
- 4. EXISTING FIRE EXTINGUISHERS AND CABINETS ARE NOT SHOWN ON PLANS. PROTECT EXISTING FIRE EXTINGUISHERS AND CABINETS (RECESSED OR SURFACE MOUNTED) FROM DAMAGE. HA7MAT

1. THE CONTRACTOR WILL SUSPEND WORK IMMEDIATELY AND NOTIFY THE OWNER IF MATERIALS SUSPECTED OF BEING HAZARDOUS, AND NOT PREVIOUSLY IDENTIFIED, ARE ENCOUNTERED IN THE COURSE OF THE CONTRACTOR'S WORK.

DEMOLITION:

1. WHERE ITEMS ARE INDICATED ON PLANS TO BE DEMOLISHED, IT SHALL MEAN THE COMPLETE REMOVAL AND DISPOSAL OF THE ITEM INDICATED UNLESS OTHERWISE NOTED. "REMOVE" MEANS TO COMPLETELY AND PERMANENTLY REMOVE FROM THE PROJECT. 2. CONTRACTOR IS RESPONSIBLE FOR REVIEW OF THE ARCHITECTURAL DRAWINGS AND SPECIFICATIONS FOR CUTTING AND PATCHING WORK.

DIMENSIONS:

- 1. DO NOT SCALE DRAWINGS.
- 2. VERIFY DIMENSIONS SHOWN ON DRAWINGS. USE ONLY DIMENSIONS INDICATED. PRIOR TO STARTING OR CONTINUING WORK, NOTIFY ARCHITECT OF DISCREPANCIES OR CONDITIONS INCONSISTENT WITH THE INTENT OF THE CONSTRUCTION DOCUMENTS.
- 3. DIMENSIONS ARE TO FACE OF CONCRETE, FACE OF MASONRY, OR FACE OF STUD, UNLESS OTHERWISE NOTED. 4. FINISHED SURFACE OF INFILL OR EXTENSIONS OF EXISTING PARTITIONS SHALL ALIGN WITH ADJACENT EXISTING SURFACES UNLESS OTHERWISE
- NOTED. 5. VERTICAL DIMENSIONS ARE MEASURED FROM STRUCTURAL SLAB, TOP OF STEEL OR TOP OF SHEATHING, UNLESS NOTED OTHERWISE.

COORDINATION:

- 1. COORDINATE ALL OPERATIONS WITH OWNER, SUCH AS AREAS USED FOR MATERIAL STORAGE, ACCESS TO AND FROM THE SITE, TIMING OF WORK AND REQUIREMENTS OF NOISE ORDINANCE. INSTALL DUST AND NOISE BARRIERS AS REQUIRED TO PROTECT EXISTING ADJACENT BUILDINGS AND OCCUPANTS AND TO MAINTAIN AN ENVIRONMENT SUITABLE TO PERMIT CONTINUED OCCUPANCY OF SUBJECT AND ADJACENT BUILDINGS. 2. REVIEW DEMOLITION DRAWINGS. PATCH AND REPAIR ALL EXISTING SURFACES AFFECTED BY DEMOLITION WORK.
- 3. VERIFY LOCATIONS OF EXISTING UTILITIES. CAP, MARK AND PROTECT AS NECESSARY TO COMPLETE THE WORK.
- 4. PRIOR TO CONSTRUCTION, COORDINATE ALL WORK WITH WITH THE POWER, TELEPHONE AND CABLE TV UTILITY PROVIDERS TO THE BUILDING. CONFIRM THE SERVICE INTERRUPTION, SEQUENCE OF WORK AND CONDUCTOR CONCEALMENT IN BUILDING ENVELOPE PRIOR TO STARTING WORK. 5. REFER TO DIVISION ONE OF THE PROJECT DOCUMENTS FOR FURTHER REQUIREMENTS FOR THE ADVANCE NOTIFICATION TO THE BUILDING TENANTS BEFORE ANY SYSTEM SHUTDOWN. ALL SHUTDOWN AND CHANGE-OVER TIME SHALL BE KEPT TO A MINIMUM. THE CONTRACTOR SHALL
- SUBMIT A OUTAGE PROPOSAL TO KCHA FOR APPROVAL. NO BUILDING SYSTEM SHUTDOWNS WILL BE ALLOWED WITHOUT BEING SCHEDULED AND APPROVED BY OWNER. 6. PIPING, CONDUITS, DUCTS, ETC. SHALL BE CONCEALED IN WALLS, CHASES, ABOVE SUSPENDED CEILINGS, BELOW FLOORS OR BE FURRED-IN IN
- ROOMS WITH EXISTING CEILINGS, UNLESS OTHERWISE NOTED. DO NOT CONCEAL PIPING, CONDUITS, DUCTS, ETC. IN ELECTRICAL, MECHANICAL, AND COMMUNICATION ROOMS.
- 7. COORDINATE AND PROVIDE REQUIRED PENETRATIONS AND PATCHING TO SUIT NEW WORK.

SITE 2 622 JENNINGS S

VICINITY MAP

PROJECT INFORMATION

PROJECT OWNER KING COUNTY HOUSING AUTHORITY

PROJECT MANAGER CARL FRANKEL TEL: (206) 574-1249 EMAIL: carlf@kcha.org

PROJECT ADDRESS

SITE 1: BUILDING A: 804-814 BINGHAM PL, SEDRO-WOOLEY, WA 98284 BUILDING B: 816-822 BINGHAM PL, SEDRO-WOOLEY, WA 98284

BUILDING C: 622-630 JENNINGS ST, SEDRO-WOOLEY, WA 98284

SCOPE DESCRIPTION THE SCOPE IS LIMITED TO REPLACEMENT OF EXISTING ROOFING AND EXTENDING OUTRIGGERS TO CREATE CONTINUOUS EAVE OVERHANGS ALONG BUILDINGS.

ZONING ANALYSIS

PARCEL NUMBER SITE 1: P39505 SITE 2: P76215

LEGAL DESCRIPTION

SITE 1: (0.9600 ac) TAX 48B W 124FT OF S 340FT OF FOL TR PT N GOVERNMENT LOT 3, SECTION 19, TOWNSHIP 35 NORTH, RANGE 5 EAST, W.M., LY S OF GREENSTREETS 2ND ADD SW & WLY OF OTTO GREENSTREETS ADD TO SW & NLY OF STATE ST

SITE 2: TOWN OF SEDRO LOTS 14 TO 18 BLK 104 CURRENT USE

APARTMENT


YEAR BUILT 1971

(E) BLDG AREA SITE 1: 13,800 SF A: 7,150 SF B: 4,685 SF

SITE 2: 4,405 SF C: 4,406 SF

APPLICABLE CODES

- SEDRO-WOOLEY MUNICIPAL CODE
- 2021 INTERNATIONAL BUILDING CODE 2021 INTERNATIONAL EXISTING BUILDING CODE
- 2021 WASHINGTON STATE ENERGY CODE

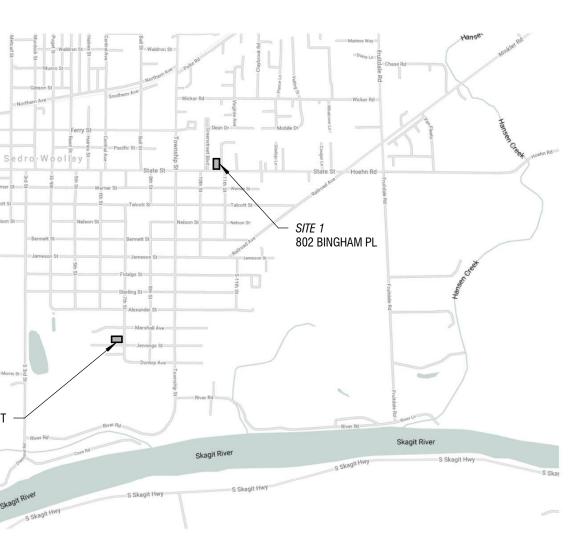



DESIGN TEAM

ARCHITECT: SHKS ARCHITECTS 1050 NORTH 38TH ST SEATTLE, WA 98103 TEL: 206.224.3317 CONTACT: LEVI JETTE EMAIL: levij@shksarchitects.com

SHEET INDEX

••••	/.
A0.0	COVER SHEET
A1.0	SITE PLAN
A2.3A	ROOF PLANS - BLDG A
A2.3B	ROOF PLANS - BLDG B
A2.3C	ROOF PLANS - BLDG C
A6.1	EXTERIOR DETAILS
A6.2	EXTERIOR DETAILS

shks ARCHITECTS

> Seattle HQ PH: 206.675.9151 info@shksarchitects.com 1050 N 38th Stree Seattle, WA 98103


KCHA	
CEDAR	
GROVE	
ROOF	
REPLACEMENT	

PERI	MIT SET
SITE 1: 804-822 BI SITE 2: 622-630 JE SEDRO-WOOLEY, V	NNINGS ST
Drawn by:	NA
Checked:	LJ
Date:	08/14/2024
Scale:	As indicated
Revisions: <u>No. Date</u>	Remarks


COVER SHEE


• ALL CODES ADOPTED AND AMENDED BY THE STATE BUILDING CODE COUNCIL IN CHAPTER 51 WA


COPYRIGHT © 2023 SHKS ARCHITECTS P.S., INC.

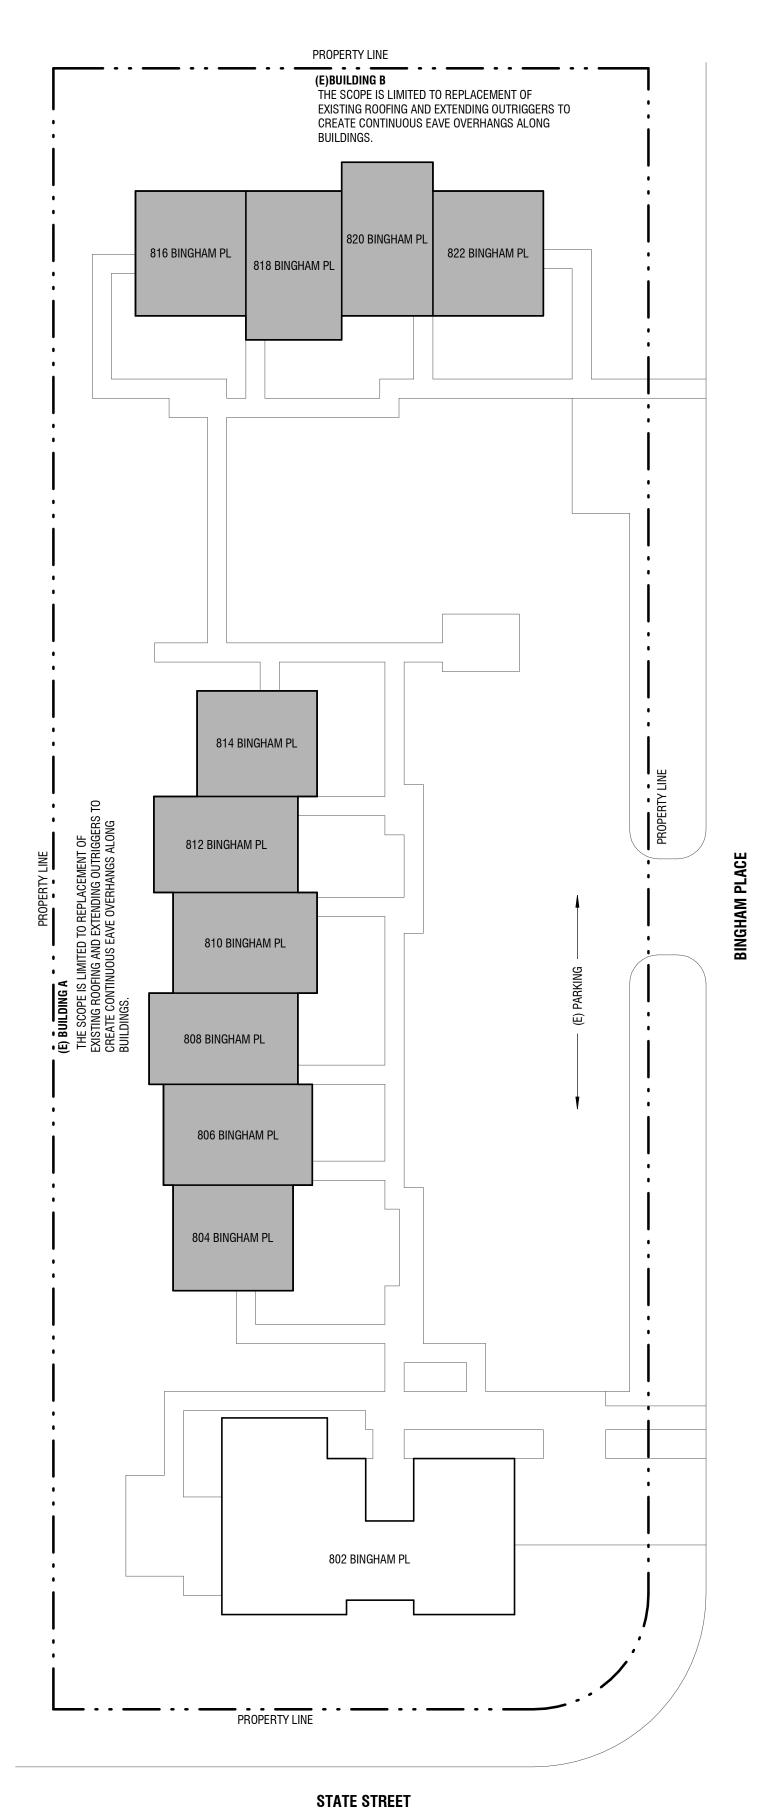

1 SITE PLAN - SITE 1 1" = 20'-0"

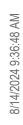

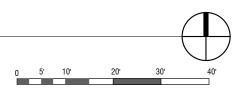

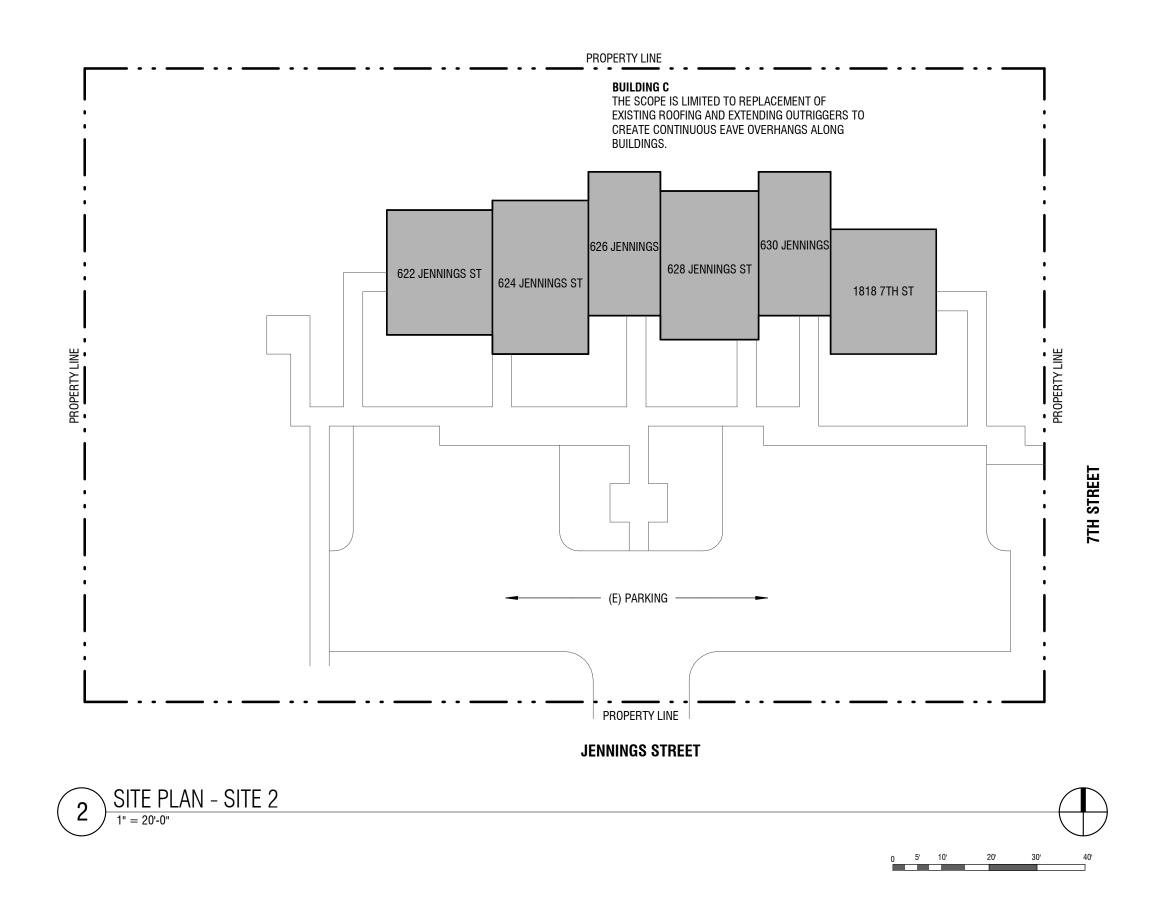



Seattle HQ

PH: 206.675.9151

Seattle, WA 98103

info@shksarchitects.com 1050 N 38th Street

KCHA CEDAR GROVE

ROOF REPLACEMENT

PERMIT SET

SITE 1: 804-822 BINGHAM PL — SITE 2: 622-630 JENNINGS ST SEDRO-WOOLEY, WA 98284 Drawn by: NA _____ Checked: LJ _____ Date: 08/14/2024 1" = 20'-0" Scale: Revisions: Remarks ___<u>No._</u>Date____


SITE PLAN

<u>General Notes</u> 1. It is the sole responsibility of the contractor to independently verify the accuracy of ALL UTILITY LOCATIONS TO AVOID DAMAGE AND/OR DISTURBANCE TO SUCH UTILITIES, AND TO FURTHER DISCOVER AND AVOID ANY OTHER UTILITIES WHICH MAY BE AFFECTED BY THE IMPLEMENTATION OF THIS PLAN.

TREE PROTECTION & VEGETATION REMOVAL

- 1. THE CONTRACTOR SHALL PRESERVE ONSITE VEGETATION TO THE MAXIMUM EXTENT POSSIBLE. 2. NOT ALL MINOR LANDSCAPING AND HEDGES ARE SHOWN ON THE PLANS. CONTRACTOR SHALL BE RESPONSIBLE FOR VERIFYING EXISTING CONDITIONS PRIOR TO BIDDING AND MUST PROTECT THOSE CONDITIONS DURING CONSTRUCTION.
- 3. ALL LANDSCAPE / UNIMPROVED AREAS TO BE DISTURBED SHALL BE RESTORED TO THEIR EXISTING CONDITIONS. 4. OWNER WILL PROVIDE TREE PRUNING AS NECESSARY.

- TEMPORARY EROSION AND SEDIMENT CONTROL 1. THE CONTRACTOR SHALL CONDUCT WORK AND TAKE PREVENTATIVE MEASURES SUCH THAT DUST OR OTHER PARTICULATE MATTER IN THE PROJECT AREA SHALL NOT BECOME OBJECTIONABLE TO THE OWNER AND THAT THE CONSTRUCTION SITE MEETS THE REQUIREMENTS OF REGULATIONS 1 AND 2 OF THE PUGET SOUND AIR POLLUTION CONTROL AUTHORITY.
- 2. PROPER EROSION AND SEDIMENT CONTROL PRACTICES MUST BE USED ON THE CONSTRUCTION SITE AND ADJACENT AREAS TO PREVENT UPLAND SEDIMENTS FROM ENTERING THE NATURAL STORM WATER DRAINAGE SYSTEM. EROSION CONTROL MEASURES MUST BE IN PLACE PRIOR TO ANY CONSTRUCTION
- 3. CONTRACTOR SHALL RESTORE ALL DISTURBED AREAS BEYOND THE SCOPE OF WORK TO THEIR EXISTING CONDITION OR BETTER. HYDROSEED ALL GRASS AREAS DISTURBED.

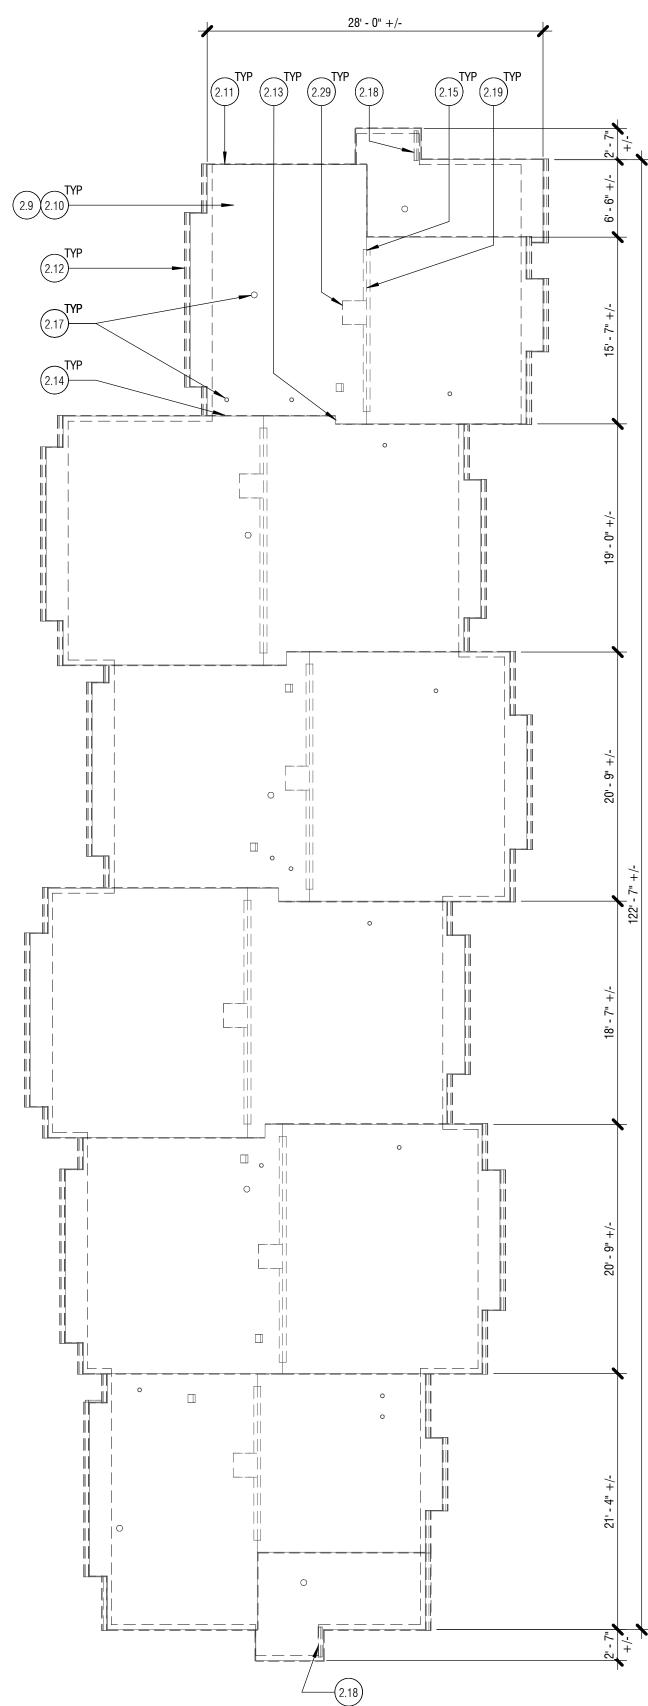

<u>DEMO LEGEND:</u>

— — — DEMOLISH _____ (E) WALL

GENERAL NOTES: 1. IF WATER DAMAGE IS OBSERVED IN THE COURSE OF THE PROJECT, NOTIFY OWNER IMMEDIATELY.

2. ALL DIMENSIONS ARE APPROXIMATE. VERIFY IN FIELD.



 TYP
 TYP</th (7.8) TYP (7.11) TYP (6.5) TYP 6.7 TYP 7" / 12" 6.4 7.7 TYP (7.14)**TYP** 7" / 12" 7" / 12" (7.12)**TYP** 7" / 12" 7" / 12" 0 7" / 12" 7" / 12" 0 7" / 12" 7" / 12" 7" / 12" 7" / 12" 7" / 12" 7" / 12" 0 7" / 12"

IBC 1203.2- ROOF VENTILATION:

ROOF AREA = 3,703 SF = 533,232 SQ. IN. 1/150 X 533,232 SQ. IN. = 3,555 SQ. IN. NFVA

REQUIRED RIDGE VENT AREA = 50% X 3,555 Sq. in. = 1,778 Sq. in. NFVA PROPOSED RIDGE VENT: COR-A-VENT V-600 = 20 Sq. in. NFVA PER LF 1,778 SQ. IN. NFVA / 20 SQ. IN. NFVA PER LF = 89 LF NEEDED (~123 LF PROVIDED)

REQUIRED INTAKE VENT AREA @ EAVE = 1,778 SQ. IN. NFVA PROPOSED EAVE VENT: COR-A-VENT S400 = 10 SQ. IN. NFVA PER LF 1,778 SQ. IN. NFVA / 10 SQ. IN. NFVA PER LF = **178 LF NEEDED (245 LF PROVIDED)**


<u>Plan Legend:</u>

— — — — (E) WALL BELOW

INSTALL OUTRIGGER TO CREATE CONTINUOUS ROOF OVERHANG ALONG LENGTH OF (E) BUILDING, ALIGN WITH (E) EAVE OVERHANG

GENERAL NOTES: 1. PATCH, REPAIR, AND PAINT INTERIOR GWB DAMAGED DURING CONSTRUCTION.



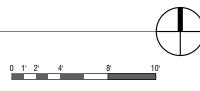



Seattle HQ

1050 N 38th Street Seattle, WA 98103

PH: 206.675.9151 info@shksarchitects.com

KCHA CEDAR GROVE ROOF

REPLACEMENT


PERMIT SET

Drawn by:	
Checked:	
Date:	08/14/2
Scale:	As indica
Revisions: No. Date	
	Remark
	Remark
	Remark
	Remark
<u>IIU.</u>	Remark
<u>IIU.</u>	Remark
<u>IU.</u>	Remark
IIU. Dale	Remark
IU. Dale	Remark

ROOF PLANS -BLDG A A2.3A

KEYNOTE LEGEND

MARK	KEYNOTE TEXT
2.9	REMOVE (E) COMPOSITE ROOFING, UNDERLAYMENT, AND ASSOCIATED FLASHINGS
2.10	REVIEW EXTENT OF DAMAGED SHEATHING W/ OWNER PRIOR TO REPLACING (E)
	DAMAGED ROOF SHEATHING
2.11	REMOVE (E) FASCIA AND BARGE BOARD AND SOFFIT
2.12	REMOVE (E) GUTTERS AND DOWNSPOUT
2.13	REMOVE (E) METAL VALLEY FLASHING
2.14	REMOVE (E) STEP FLASHING
2.15	REMOVE (E) RIDGE VENT
2.17	REMOVE (E) PIPE BOOT AND FLASHING
2.18	REMOVE (E) RAIN DIVERTER
2.19	REMOVE (E) FALL PROTECTION SYSTEM
2.29	REMOVE (E) ROOF RIDGE VENT STRUCTURE, FLUSH WITH SLOPE OF ADJACENT ROOF
6.4	REPLACE (E) DAMAGED ROOF SHEATHING, ASSUME (10) 4'x8' SHEETS TO BE REPLACED AT EACH BUILDING
6.5	INFILL W/ SHEATHING AT ABANDONED PENETRATION OPENING
6.7	INSTALL OUTRIGGER TO CREATE CONTINUOUS ROOF OVERHANG ALONG LENGTH OF (E) BUILDING, ALIGN WITH (E) EAVE OVERHANG, REF 2 / A6.1
7.7	FIBERGLASS REINFORCED ASPHALT SHINGLES ON (2) LAYERS OF SYNTHETIC UNDERLAYMENT, REF ROOF ASSEMBLY A6.1
7.8	FIBER CEMENT FASCIA AND BARGE BOARD AND SOFFIT, REF 2 / A6.1
7.11	FULLY-SOLDERED STAINLESS STEEL VALLEY FLASHING, EXTEND PAST TRANSITION POINT, RETURN DOWN BOTH ENDS WITH FLANGES INTEGRATED IN SHINGLE FASHION, REF 6 / A6.2
7.12	STEP FLASHING AT WALL TO ROOF TRANSITION, REF 4 / A6.1
7.13	RIDGE VENT AT (E) OPENING, REF 3 / A6.2
7.14	PIPE FLASHING AT (E) VENT PENETRATION, REF 7 / A6.2
7.15	ROOF VENT CAP AT EXISTING PENETRATION, REF 4 / A6.2
7.17	ROOF MOUNTED STAINLESS STEEL OR COATED ALUMINIUM METAL RAIN DIVERTER, 36" W/ EXPOSED HEMMED EDGE, MOUNT ON SECOND TO BOTTOM ROW OF SHINGLES, ROOFING CEMENT AT EACH NAIL AND BETWEEN SHINGLES AND DIVERTER
7.23	INSTALL GUTTER AND DOWNSPOUT
11.1	FALL PROTECTION SYSTEM REF 3 / A6.2

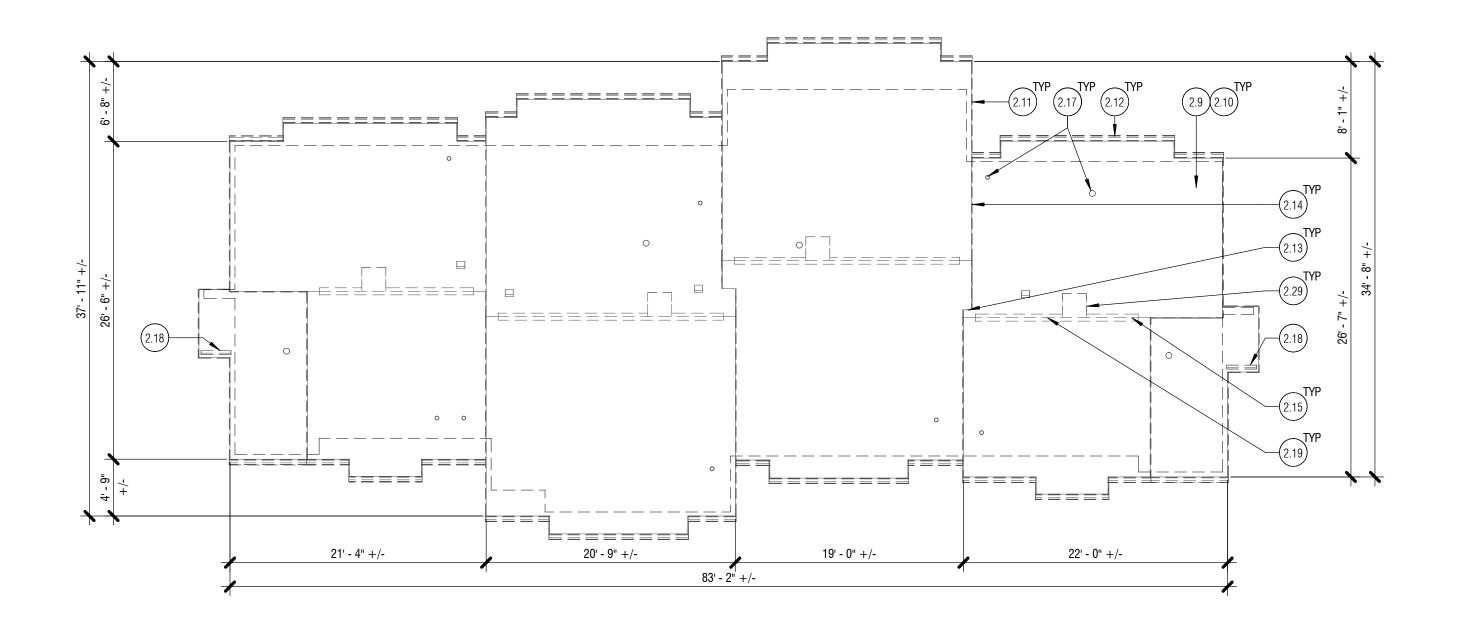

DEMO LEGEND:

——— Demolish

_____ (E) WALL

<u>GENERAL NOTES:</u>
1. IF WATER DAMAGE IS OBSERVED IN THE COURSE OF THE PROJECT, NOTIFY OWNER IMMEDIATELY.
2. ALL DIMENSIONS ARE APPROXIMATE. VERIFY IN FIELD.



IBC 1203.2- ROOF VENTILATION:

ROOF

AREA = 2,419 SF = 348,336 SQ. IN. 1/150 X 348,336 SQ. IN.= 2,322 SQ. IN. NFVA

REQUIRED RIDGE VENT AREA = 50% X 2,322 SQ. IN. = 1,161 SQ. IN. NFVA PROPOSED RIDGE VENT: COR-A-VENT V-600 = 20 SQ. IN. NFVA PER LF 1,161 SQ. IN. NFVA / 20 SQ. IN. NFVA PER LF = **58 LF NEEDED (~64 LF PROVIDED)**

REQUIRED INTAKE VENT AREA @ EAVE = 1,161 SQ. IN. NFVA


PROPOSED EAVE VENT: COR-A-VENT RS400 = 10 SQ. IN. NFVA PER LF 1,161 SQ. IN. NFVA / 10 SQ. IN. NFVA PER LF = **116 LF NEEDED (~166 LF PROVIDED)**

PLAN LEGEND:

— — — — (E) WALL BELOW

INSTALL OUTRIGGER TO CREATE CONTINUOUS ROOF OVERHANG ALONG LENGTH OF (E) BUILDING, ALIGN WITH (E) EAVE OVERHANG

GENERAL NOTES: 1. PATCH, REPAIR, AND PAINT INTERIOR GWB DAMAGED DURING CONSTRUCTION.

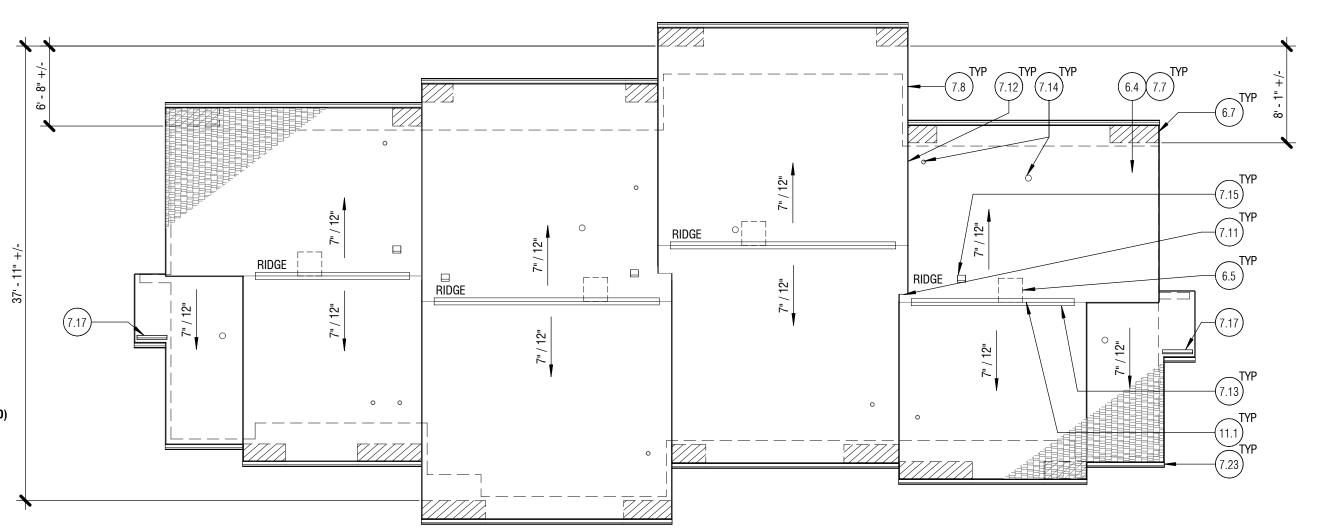

2 ROOF PLAN - BLDG B

0 1' 2' 4' 8' 10'



Seattle HQ PH: 206.675.9151 info@shksarchitects.com

1050 N 38th Street Seattle, WA 98103

KCHA CEDAR GROVE ROOF

REPLACEMENT


PERMIT SET

_	SITE 1: 804-822 BINGHAM PL SITE 2: 622-630 JENNINGS ST		
_	SEDRO-WOOLEY, WA 98284		
—			
—	D		
_	Drawn by:	NA	
_	Checked:	LJ	
	Date:	08/14/2024	
_	Scale:	As indicated	
—	Revisions:	Demeric	
_	<u>No.</u> <u>Date</u> _	Remarks	
_			
—			
—			
_			
_			
—			
—			
—			
_			
—			
_			
_			
_			
—	ROOF	PLANS -	
—		BLDG B	
_			

A2.3B

KEYNOTE LEGEND

MARK	KEYNOTE TEXT
2.9	REMOVE (E) COMPOSITE ROOFING, UNDERLAYMENT, AND ASSOCIATED FLASHINGS
2.10	REVIEW EXTENT OF DAMAGED SHEATHING W/ OWNER PRIOR TO REPLACING (E)
	DAMAGED ROOF SHEATHING
2.11	REMOVE (E) FASCIA AND BARGE BOARD AND SOFFIT
2.12	REMOVE (E) GUTTERS AND DOWNSPOUT
2.13	REMOVE (E) METAL VALLEY FLASHING
2.14	REMOVE (E) STEP FLASHING
2.15	REMOVE (E) RIDGE VENT
2.17	REMOVE (E) PIPE BOOT AND FLASHING
2.18	REMOVE (E) RAIN DIVERTER
2.19	REMOVE (E) FALL PROTECTION SYSTEM
2.29	REMOVE (E) ROOF RIDGE VENT STRUCTURE, FLUSH WITH SLOPE OF ADJACENT ROOF
6.4	REPLACE (E) DAMAGED ROOF SHEATHING, ASSUME (10) 4'x8' SHEETS TO BE REPLACED AT EACH BUILDING
6.5	INFILL W/ SHEATHING AT ABANDONED PENETRATION OPENING
6.7	INSTALL OUTRIGGER TO CREATE CONTINUOUS ROOF OVERHANG ALONG LENGTH OF (E) BUILDING, ALIGN WITH (E) EAVE OVERHANG, REF 2 / A6.1
7.7	FIBERGLASS REINFORCED ASPHALT SHINGLES ON (2) LAYERS OF SYNTHETIC UNDERLAYMENT, REF ROOF ASSEMBLY A6.1
7.8	FIBER CEMENT FASCIA AND BARGE BOARD AND SOFFIT, REF 2 / A6.1
7.11	FULLY-SOLDERED STAINLESS STEEL VALLEY FLASHING, EXTEND PAST TRANSITION POINT, RETURN DOWN BOTH ENDS WITH FLANGES INTEGRATED IN SHINGLE FASHION, REF 6 / A6.2
7.12	STEP FLASHING AT WALL TO ROOF TRANSITION, REF 4 / A6.1
7.13	RIDGE VENT AT (E) OPENING, REF 3 / A6.2
7.14	PIPE FLASHING AT (E) VENT PENETRATION, REF 7 / A6.2
7.15	ROOF VENT CAP AT EXISTING PENETRATION, REF 4 / A6.2
7.17	ROOF MOUNTED STAINLESS STEEL OR COATED ALUMINIUM METAL RAIN DIVERTER,
	36" W/ EXPOSED HEMMED EDGE, MOUNT ON SECOND TO BOTTOM ROW OF SHINGLES,
7.00	ROOFING CEMENT AT EACH NAIL AND BETWEEN SHINGLES AND DIVERTER
7.23	INSTALL GUTTER AND DOWNSPOUT
11.1	FALL PROTECTION SYSTEM REF 3 / A6.2

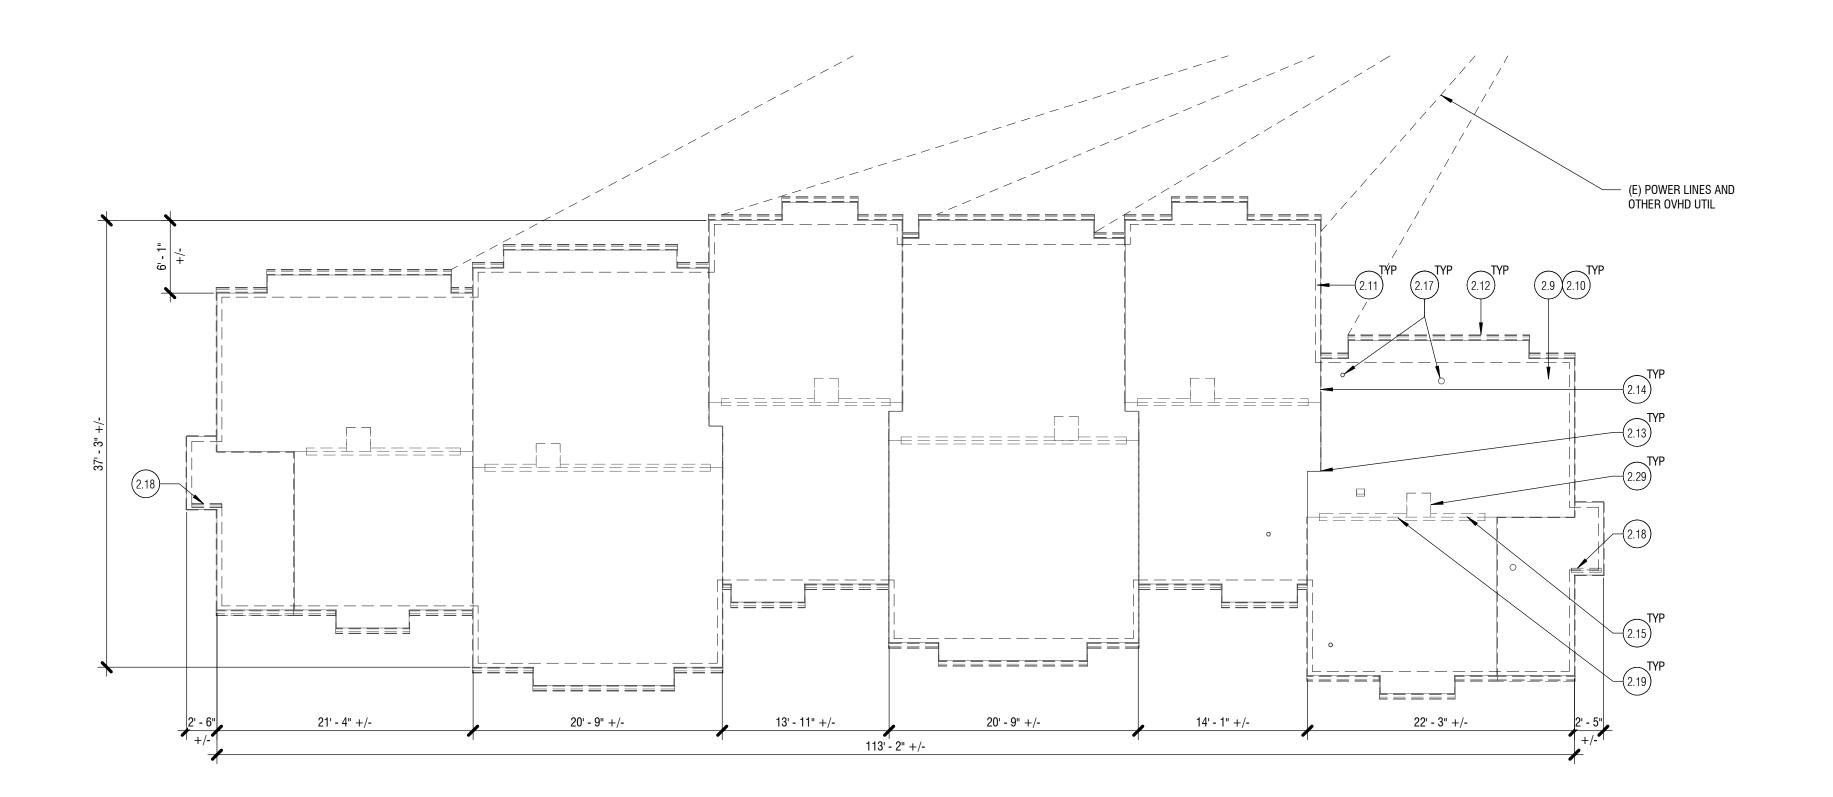

DEMO LEGEND:

- — Demolish
- _____ (E) WALL
- GENERAL NOTES: 1. IF WATER DAMAGE IS OBSERVED IN THE COURSE OF THE PROJECT, NOTIFY OWNER IMMEDIATELY.
- 2. ALL DIMENSIONS ARE APPROXIMATE. VERIFY IN FIELD.



IBC 1203.2- ROOF VENTILATION: ROOF

AREA = 3,317 SF = 477,648 SQ. IN. 1/150 X 477,648 SQ. IN. = 3,184 SQ. IN. NFVA


REQUIRED RIDGE VENT AREA = 50% X 3,184 SQ. IN. = 1,592 SQ. IN. NFVA PROPOSED RIDGE VENT: COR-A-VENT V-600 = 20 SQ. IN. NFVA PER LF 1,592 SQ. IN. NFVA / 20 SQ. IN. NFVA PER LF = 80 LF NEEDED (~92 LF PROVIDED)

REQUIRED INTAKE VENT AREA @ EAVE = 1,592 SQ. IN. NFVA PROPOSED EAVE VENT: COR-A-VENT RS400 = 10 SQ. IN. NFVA PER LF 1,592 SQ. IN. NFVA / 10 SQ. IN. NFVA PER LF = 159 LF NEEDED (~226 LF PROVIDED)

<u>Plan Legend:</u>

- — — (E) WALL BELOW
- INSTALL OUTRIGGER TO CREATE CONTINUOUS ROOF OVERHANG ALONG LENGTH OF (E) BUILDING, ALIGN WITH (E) EAVE OVERHANG

<u>General Notes:</u> 1. Patch, Repair, and paint interior gwb damaged DURING CONSTRUCTION.

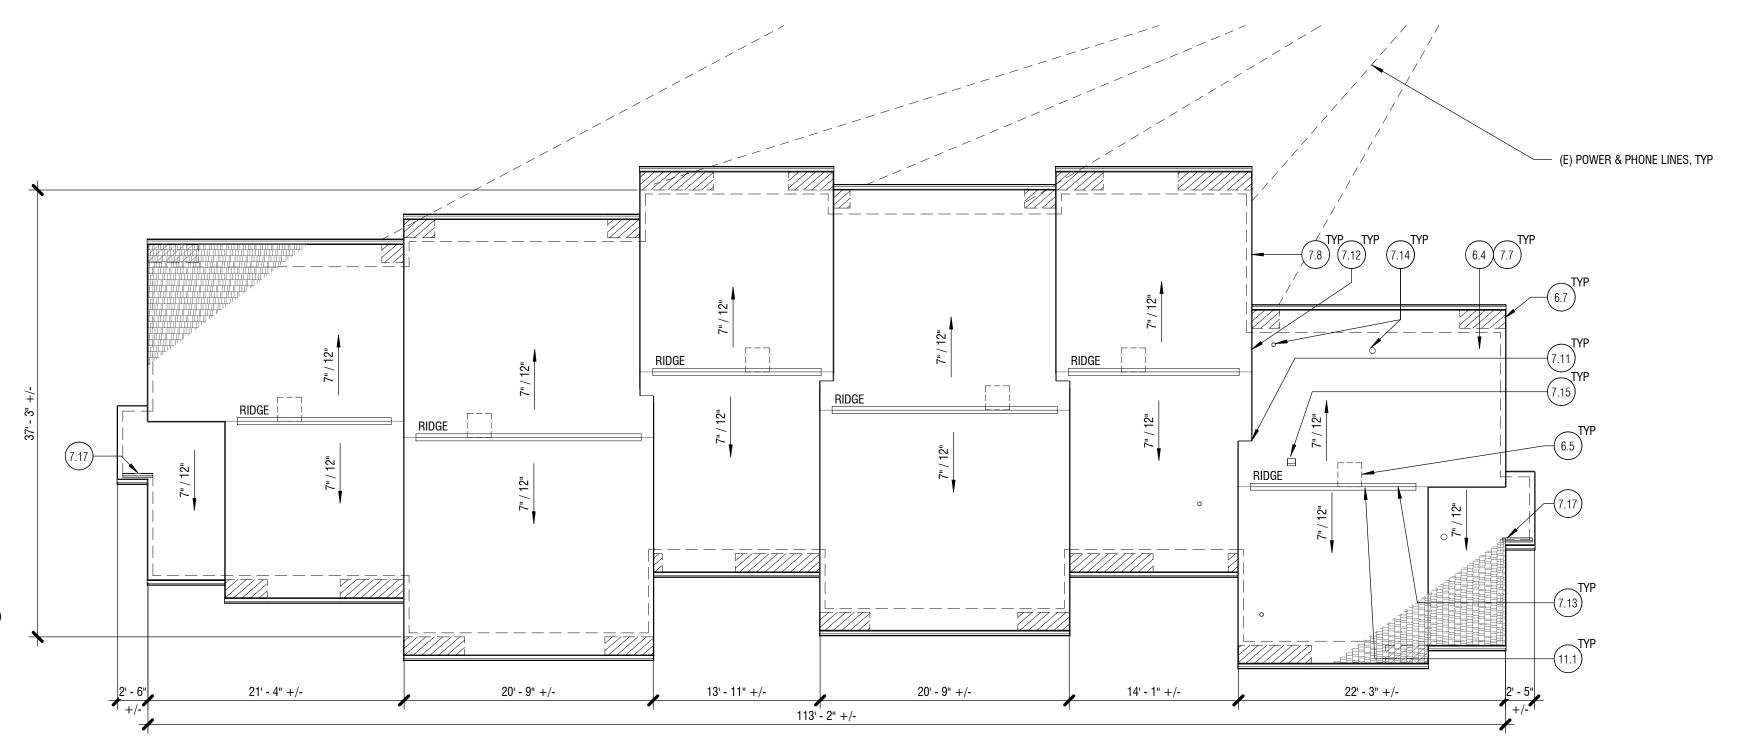

2 ROOF PLAN - BLDG C

0 1' 2' 4' 8' 10



Seattle HQ PH: 206.675.9151 info@shksarchitects.com 1050 N 38th Street Seattle, WA 98103


KEYNOTE LEGEND

MARK	KEYNOTE TEXT		
2.9	REMOVE (E) COMPOSITE ROOFING, UNDERLAYMENT, AND ASSOCIATED FLASHINGS		
2.10	REVIEW EXTENT OF DAMAGED SHEATHING W/ OWNER PRIOR TO REPLACING (E)		
	DAMAGED ROOF SHEATHING		
2.11	REMOVE (E) FASCIA AND BARGE BOARD AND SOFFIT		
2.12	REMOVE (E) GUTTERS AND DOWNSPOUT		
2.13	REMOVE (E) METAL VALLEY FLASHING		
2.14	REMOVE (E) STEP FLASHING		
2.15	REMOVE (E) RIDGE VENT		
2.17	REMOVE (E) PIPE BOOT AND FLASHING		
2.18	REMOVE (E) RAIN DIVERTER		
2.19	REMOVE (E) FALL PROTECTION SYSTEM		
2.29	REMOVE (E) ROOF RIDGE VENT STRUCTURE, FLUSH WITH SLOPE OF ADJACENT ROOF		
6.4	REPLACE (E) DAMAGED ROOF SHEATHING, ASSUME (10) 4'x8' SHEETS TO BE REPLACED AT EACH BUILDING		
6.5	INFILL W/ SHEATHING AT ABANDONED PENETRATION OPENING		
6.7	INSTALL OUTRIGGER TO CREATE CONTINUOUS ROOF OVERHANG ALONG LENGTH OF (E) BUILDING, ALIGN WITH (E) EAVE OVERHANG, REF 2 / A6.1		
7.7	FIBERGLASS REINFORCED ASPHALT SHINGLES ON (2) LAYERS OF SYNTHETIC UNDERLAYMENT, REF ROOF ASSEMBLY A6.1		
7.8	FIBER CEMENT FASCIA AND BARGE BOARD AND SOFFIT, REF 2 / A6.1		
7.11	FULLY-SOLDERED STAINLESS STEEL VALLEY FLASHING, EXTEND PAST TRANSITION POINT, RETURN DOWN BOTH ENDS WITH FLANGES INTEGRATED IN SHINGLE FASHION, REF 6 / A6.2		
7.12	STEP FLASHING AT WALL TO ROOF TRANSITION, REF 4 / A6.1		
7.13	RIDGE VENT AT (E) OPENING, REF 3 / A6.2		
7.14	PIPE FLASHING AT (E) VENT PENETRATION, REF 7 / A6.2		
7.15	ROOF VENT CAP AT EXISTING PENETRATION, REF 4 / A6.2		
7.17	ROOF MOUNTED STAINLESS STEEL OR COATED ALUMINIUM METAL RAIN DIVERTER, 36" W/ EXPOSED HEMMED EDGE, MOUNT ON SECOND TO BOTTOM ROW OF SHINGLES, ROOFING CEMENT AT EACH NAIL AND BETWEEN SHINGLES AND DIVERTER		
11.1	FALL PROTECTION SYSTEM REF 3 / A6.2		

KCHA
CEDAR
GROVE
ROOF
REPLACEMENT

PEF	RMIT SET
SITE 1: 804-822 E SITE 2: 622-630 JI SEDRO-WOOLEY	ENNINGS ST
Drawn by:	NA
Checked:	LJ
Date:	08/14/2024
Scale:	As indicated
Revisions: <u>No.</u> Date	Remarks




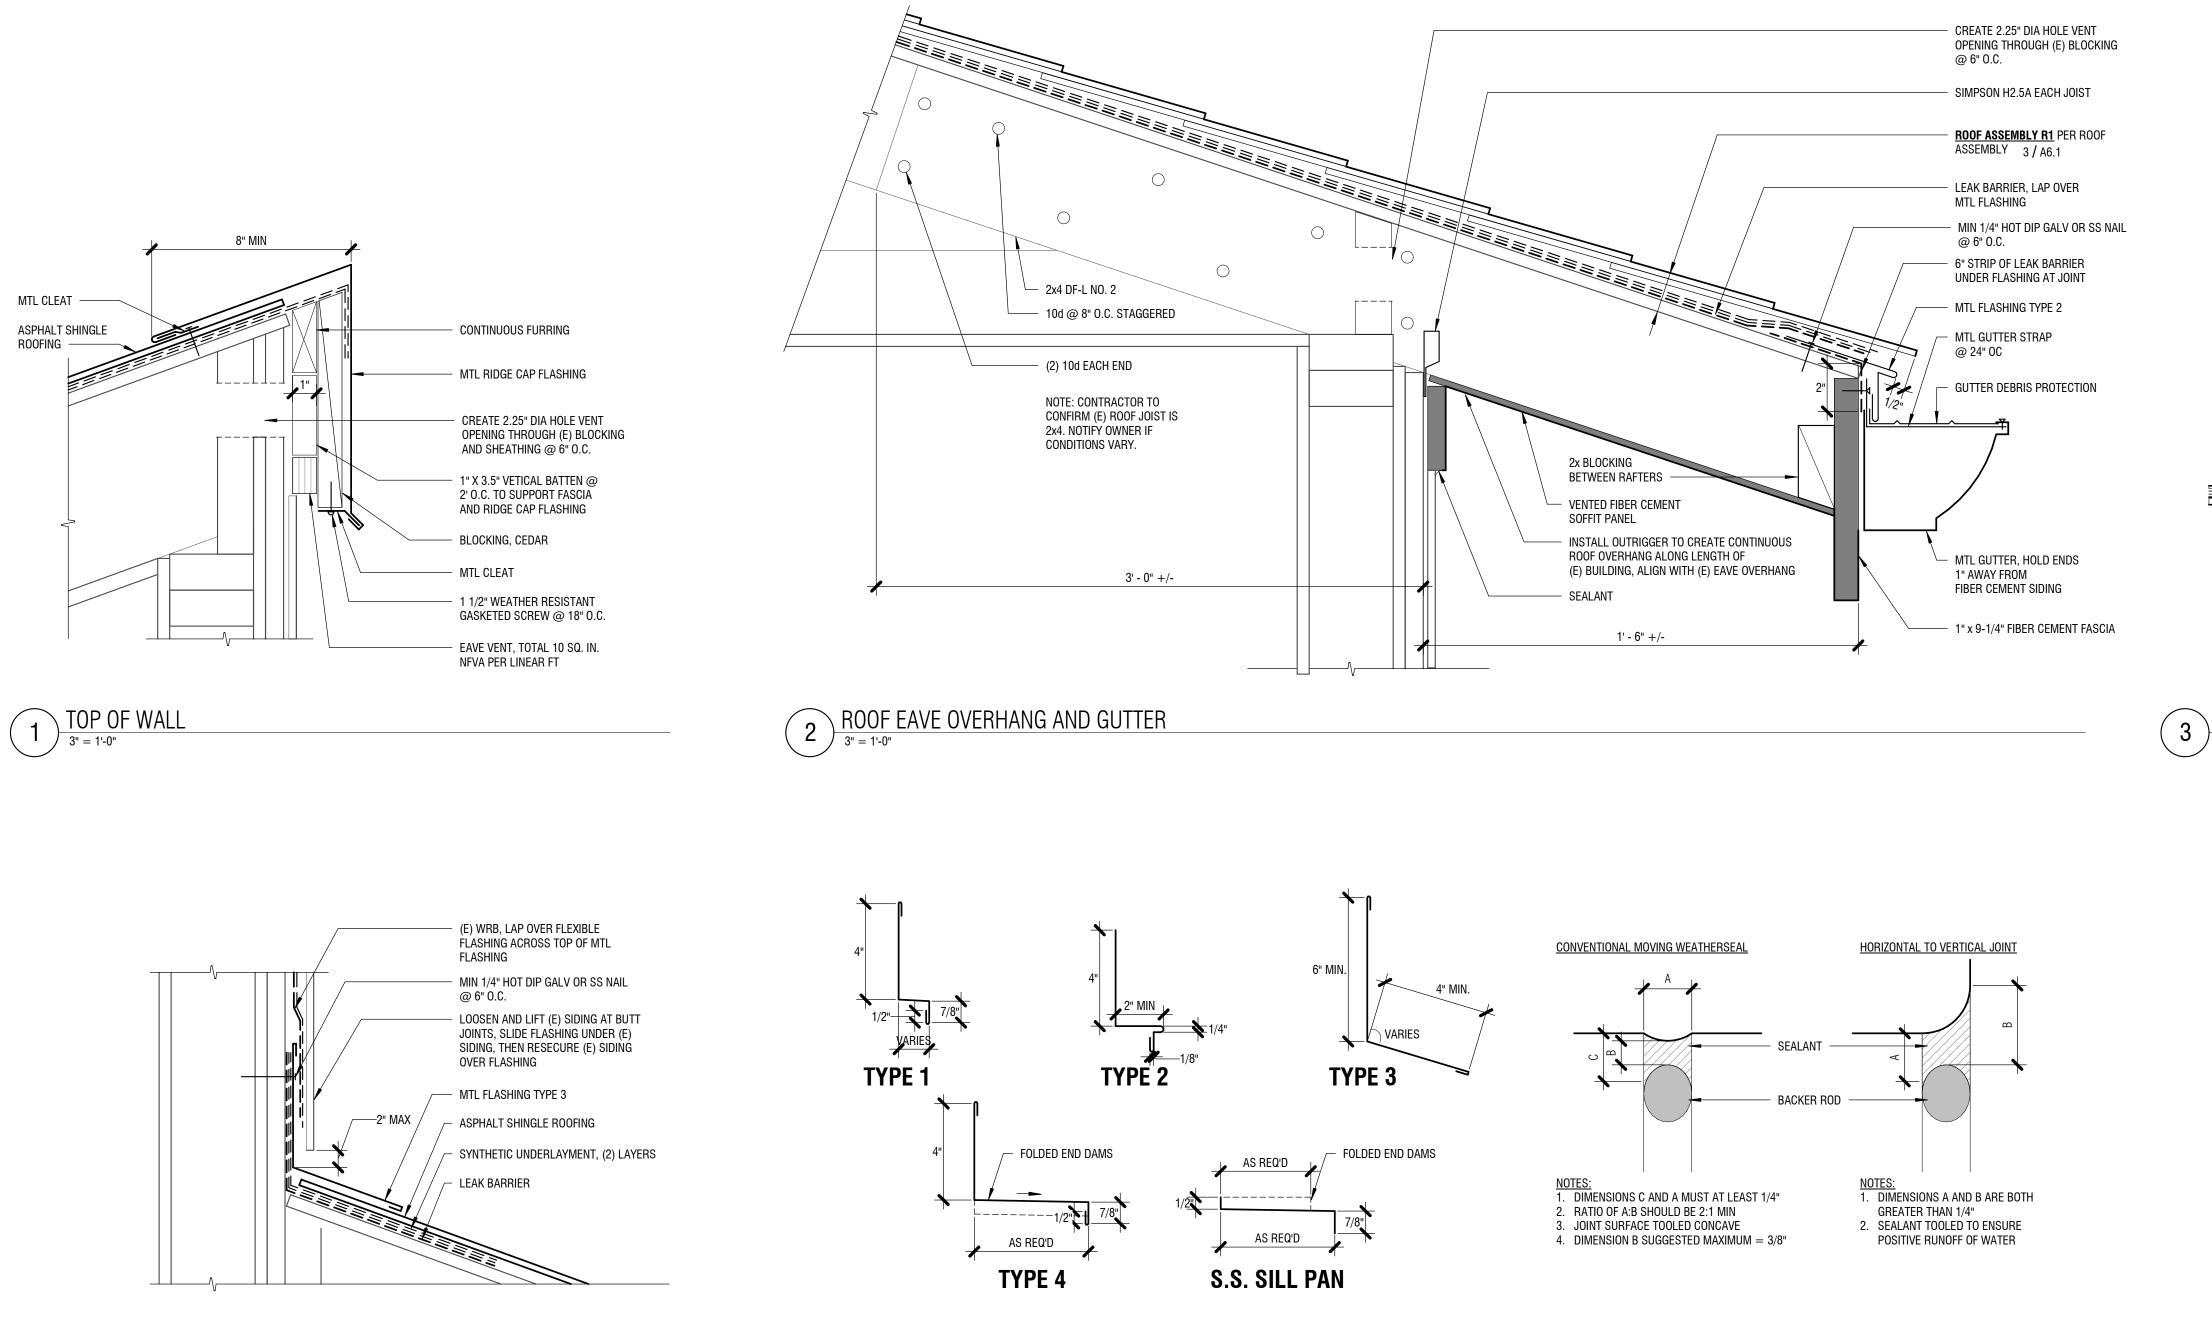



5 FLASHING TYPES 3" = 1'-0"

6 SEALANT JOINT & BACKER ROD

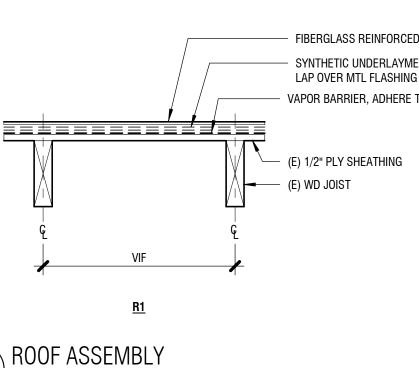

1 1/2" = 1'-0"

FIBERGLASS REINFORCED ASPHALT SHINGLES - SYNTHETIC UNDERLAYMENT, (2) LAYERS, LAP OVER MTL FLASHING VAPOR BARRIER, ADHERE TO PLY

ks

ARCHITECTS

- s h

Seattle HQ PH: 206.675.9151

1050 N 38th Street

Seattle, WA 98103

info@shksarchitects.com


KCHA
CEDAR
GROVE
ROOF
REPLACEMENT

PERMIT SET

SITE 1: 804-822 BINGHAM PL SITE 2: 622-630 JENNINGS ST SEDRO-WOOLEY, WA 98284 Drawn by: _____NA _____LJ Checked: Date: 08/14/2024 As indicated Scale: Revisions: Remarks No. Date ____



COPYRIGHT © 2023 SHKS ARCHITECTS P.S., INC.

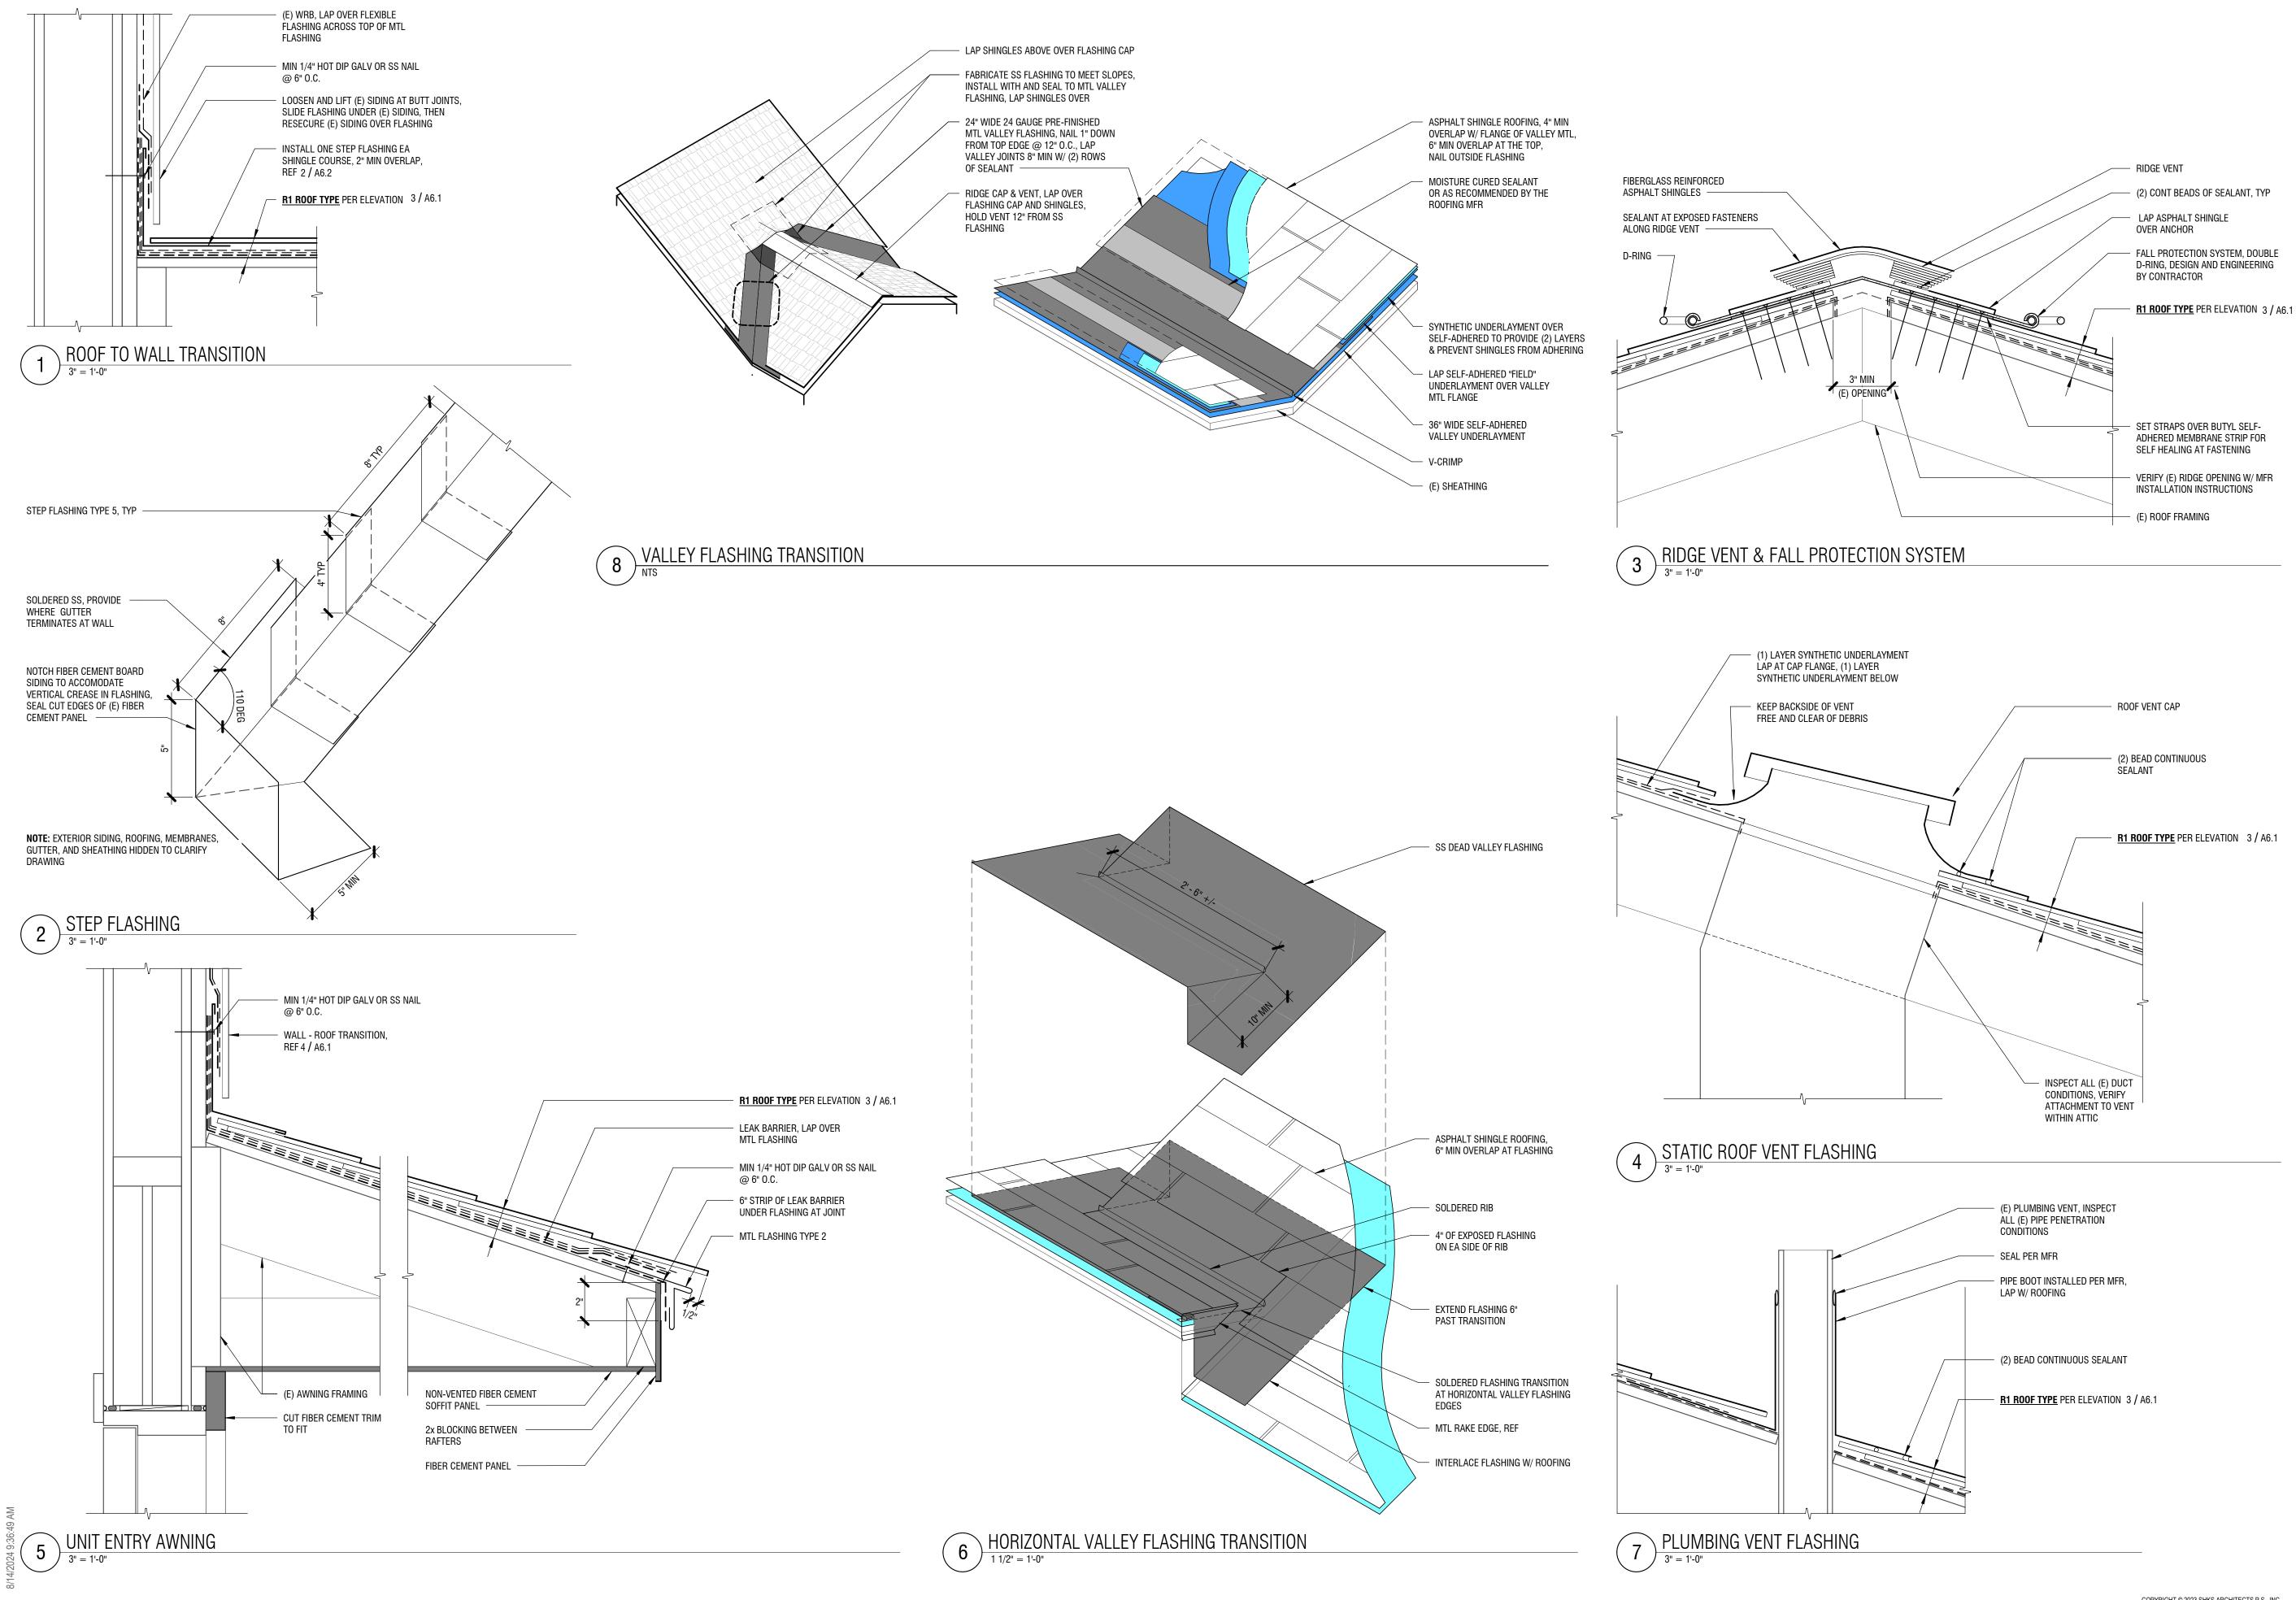

ks ARCHITECTS Seattle HQ

PH: 206.675.9151

1050 N 38th Street

Seattle, WA 98103

info@shksarchitects.com

KCHA CEDAR GROVE
ROOF REPLACEMENT
PERMIT SET

PERIVITI SET SITE 1: 804-822 BINGHAM PL SITE 2: 622-630 JENNINGS ST SEDRO-WOOLEY, WA 98284 Drawn by: NA -Checked: LJ _____ Date: 08/14/2024 Scale: As indicated Revisions: Remarks No. Date

EXTERIOR DETAILS A6.2