

CONNECTIONS OCCUR PRIOR TO TRENCHING OR

CONSTRUCTION.

EXCAVATION FOR ANY PIPE OR STRUCTURES, TO DETERMINE ACTUAL LOCATIONS, SIZE AND MATERIAL. THE CONTRACTOR

SHALL MAKE THE APPROPRIATE PROVISION FOR PROTECTION

CONCRETE CURB

RETAINING WALL

OF SAID FACILITIES. THE CONTRACTOR SHALL NOTIFY

ONE-CALL AT 8-1-1 (WASHINGTON811.COM) AND ARRANGE

FOR FIELD LOCATION OF EXISTING FACILITIES PRIOR TO

Principal In Charge: DEMOLITION PLAN

Project Number:

600 1ST AVE, SEATTLE, WA 98104 206.556.1615

THE TRAILHEAD

1550 Newport Way NW

APARTMENTS LLLP

600 Andover Park W

Principal In Charge: STORMWATER PLAN

Project Number:

600 1ST AVE, SEATTLE, WA 98104

THE TRAILHEAD


1550 Newport Way NW

APARTMENTS LLLP

Seattle, WA 98188

Project Manager: Principal In Charge: UTILITY PLAN

Project Number:

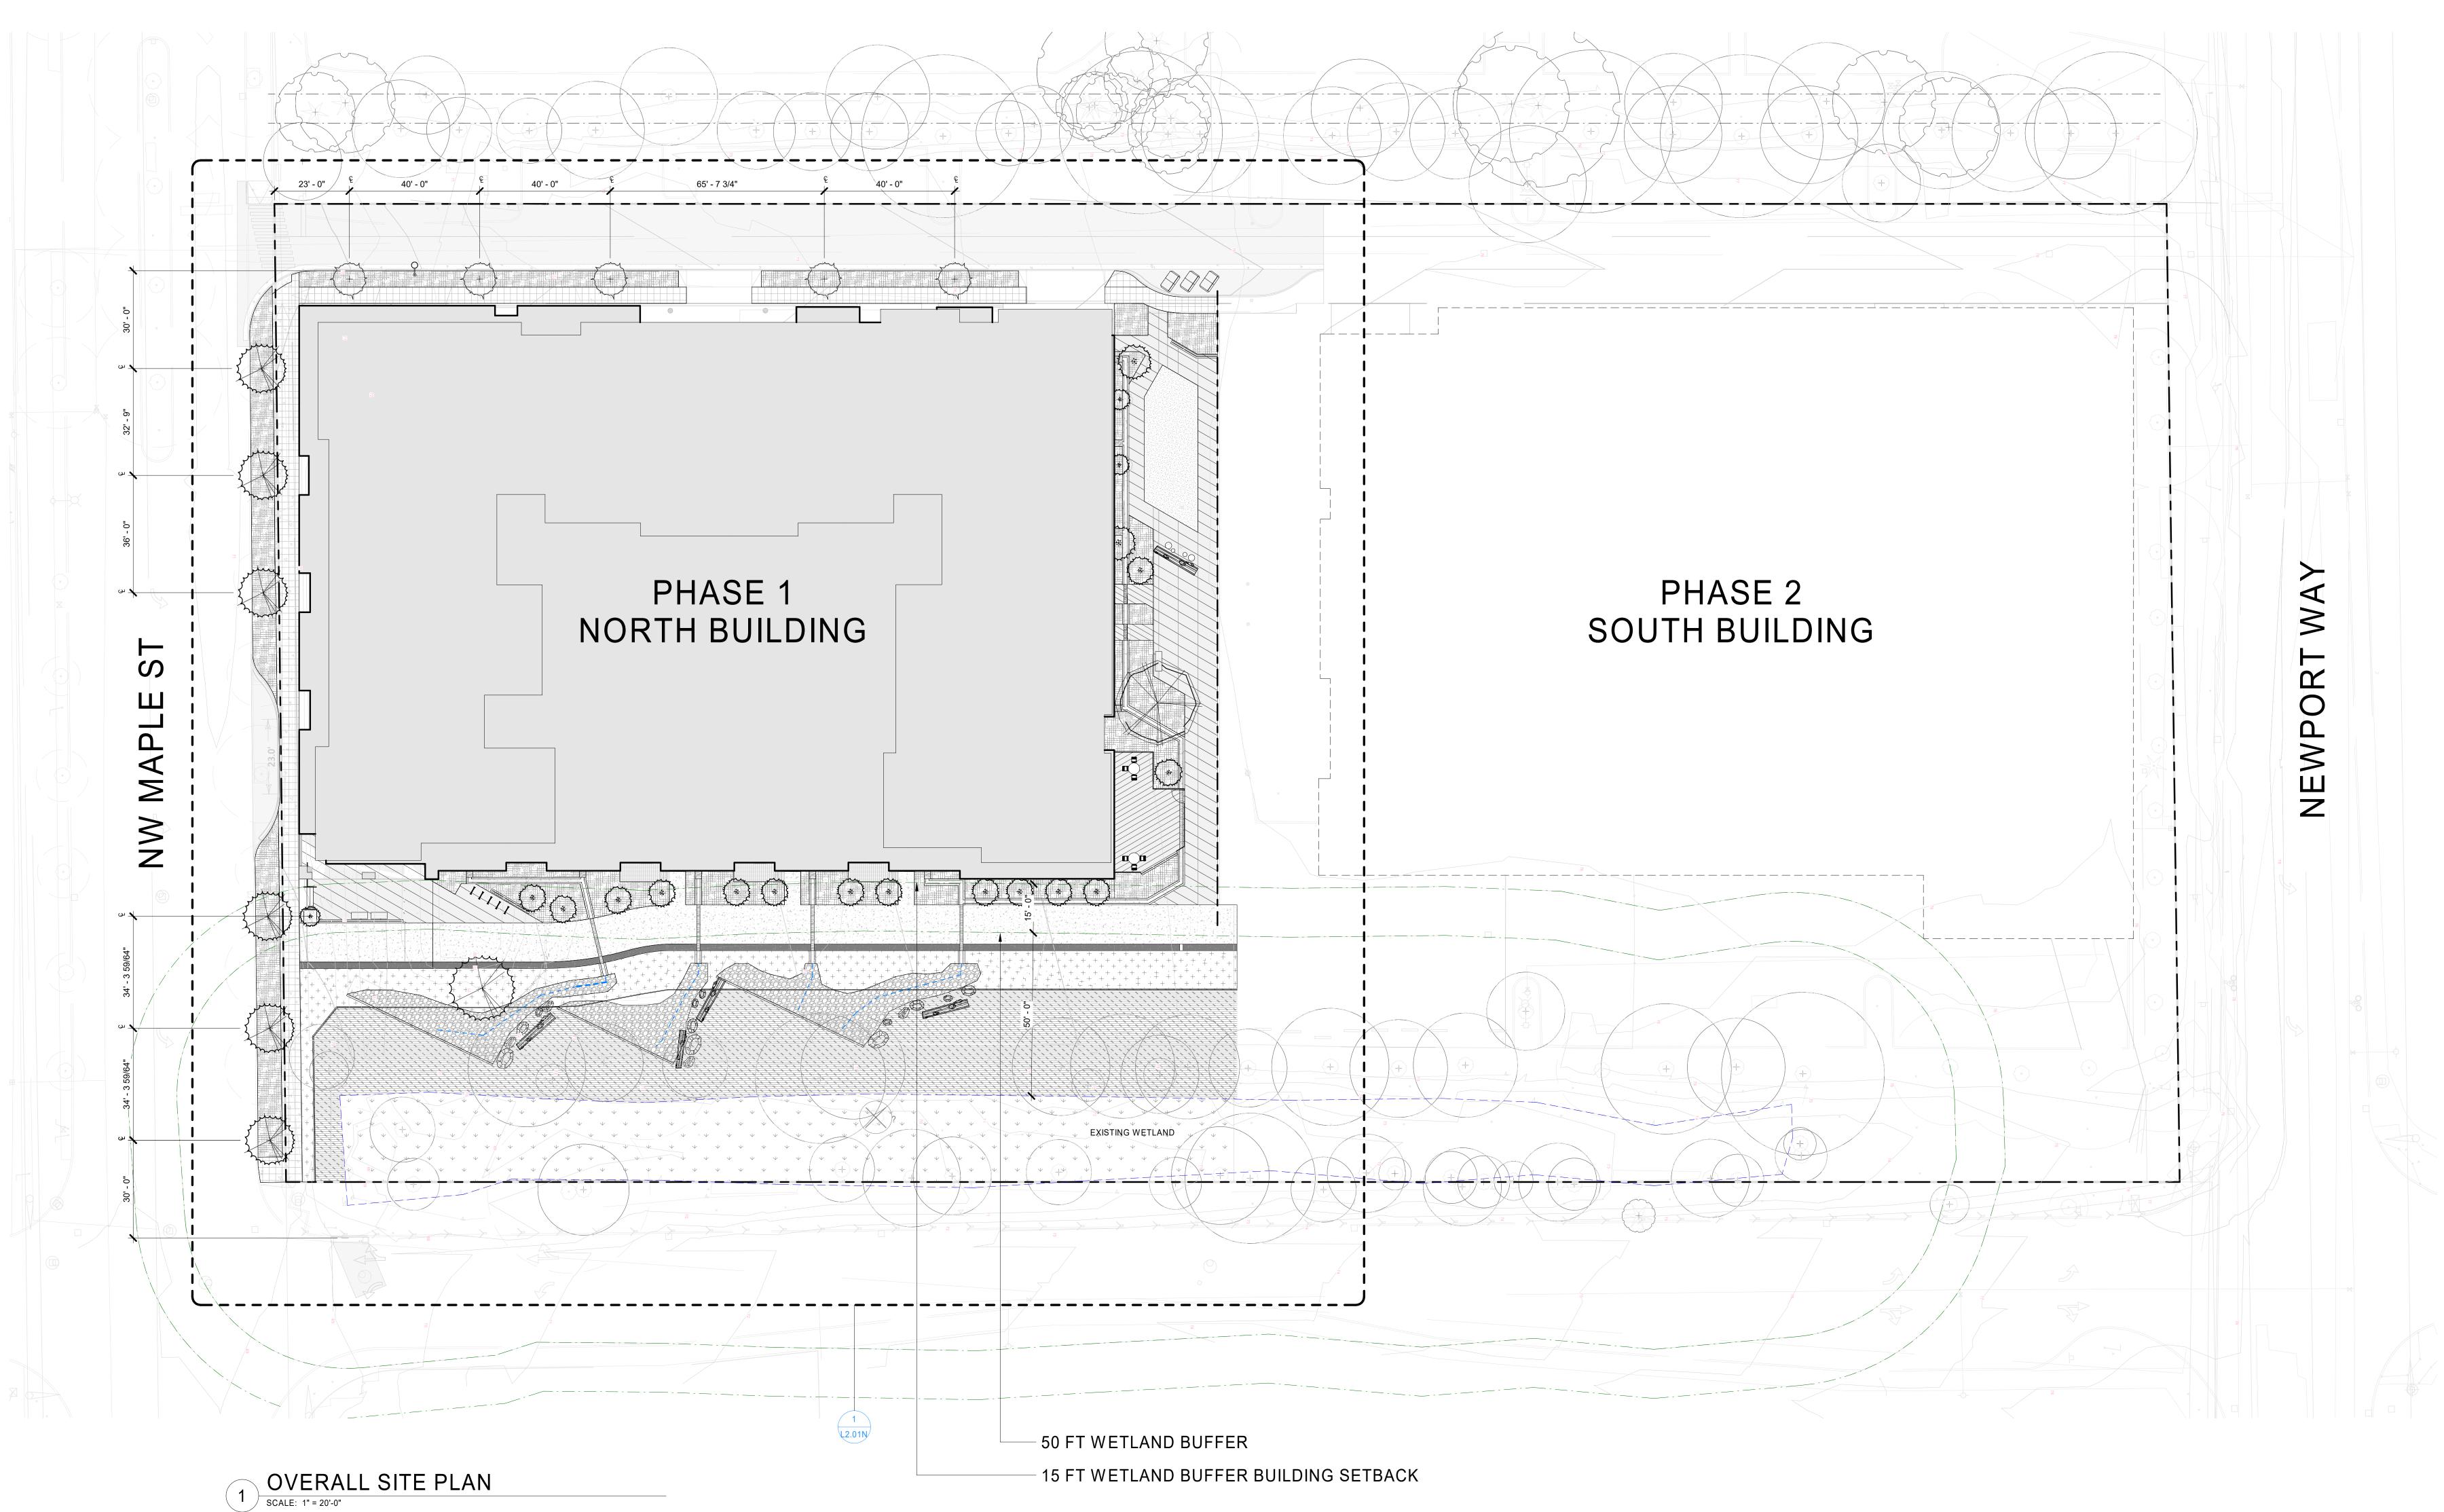

LANDSCAPE LEGEND - SITE

WEBER

Seattle, WA 98103

THOMPSON

900 N 34th Street, Suite 200

THE TRAILHEAD

1550 Newport Way NW Issaquah, WA 98027

KING COUNTY HOUSING AUTHORITY

600 Andover Park W Seattle, WA 98188

SYMBOL		ITEM
	(A1)	2' x 2' C.I.P. CONCRETE PAVING
	(A2)	C.I.P. CONCRETE PAVING, DIAGONAL 1'-6" WIDE BOARDWALK PATTERN
	(A3)	C.I.P. CONCRETE PAVING, DIAGONAL 3' WIDE BOARDWALK PATTERN
	(A4)	12' WIDE CIP CONCRETE MULTIMODAL TRAIL WITH 24" GRAVEL DISPERSION STRIP
	(A5)	24" x 24" CONCRETE PAVERS ON PEDESTAL, MUTUAL MATERIALS ARCHITECTURAL SLABS IN GREY, CHARCOAL AND LATTE
	(A6)	C.I.P. CONCRETE PAVING, DIAGONAL 1''' WIDE BOARDWALK PATTERN
	B 1	PLAZA VILLAGE BENCH, SURFACE MOUNTED B.O.D.: TOURNESOL.COM
	B2	WOOD LOG, 18-24" DIA NATURAL LOG, 8'-12' LENGTHS
\bigcirc	B3	LOG SEAT, 12"-36" DIA NATURAL STUMPS, 12"-24" LENGTHS
	B4	IRON AGE DESIGN CAST IRON TRENCH DRAIN COVER, RAIN PATTERN. RUNNEL RUNS BELOW
3	(B5)	SPORTWORKS, SURFACE MOUNTED TOFINO BIKE RACK, STAINLESS STEEL
4	C1	OPEN RUNNEL TO CONVEY STORMWATER
	<u>C2</u>	WOOD CHIPS
	C3X)	PREFABRICATED STEEL PLANTERS, SIZES VARY, 24" HT, TYPICAL. STANDARD POWDER COAT COLOR: TBE B.O.D.: TOURNESOL.COM
	C4	SOFTSCAPE AREA
	C 5	ASTRO TURF
	(D1)	30" ALUMINUM PICKET RAILING, SURFACE MOUNTED, BLACK POWDER COAT FINISH
	(D2)	48" WIDE x 5' TALL WATER JET ALUMINUM SCREEN PANELS, ORNAMENTAL PATTERN TBD. MOUNTED TO LOW CONCRETE STEMWALL @ STREET LEVEL PLAZA
	(D4)	36" CEDAR TWO-RAIL SPLIT RAIL FENCE, 6" DIAMETER POSTS, SPACED 8-FEET ON CENTER. EMBED POSTS IN 18" DIAMETER CONCRETE FOOTING, TYPICAL.
	P1	FOUNDATION PLANT MIX SEE PLANT SCHEDULE L3.01 IRRIGATION: EFFICIENT DRIP IRRIGATION SYSTEM
+ + + + + + + + + + + + + + + + + + +	P2	UPLAND BUFFER PLANT MIX UNDERSTORY SHRUB AND PERENNIAL MIX, SEE PLANT SCHEDULE L3.01 IRRIGATION: EFFICIENT DRIP IRRIGATION SYSTEM
\ \ \ \ \ \ \ \ \ \ \ \ \ \ \ \ \ \ \	(P3)	SIDE SLOPE PLANT MIX INVASIVE PLANT REMOVAL, SELECTIVE NATIVE INFILL PLANTING WHERE NEEDED, SEE PLANT SCHEDULE L3.01 IRRIGATION: EFFICIENT POP UP ROTORS POSITIONED AT BUFFER EDGE EVERY 12', SECURED TO STAKE
\(\psi \)	(P4)	WETLAND PLANT MIX INVASIVE PLANT REMOVAL, SELECTIVE NATIVE INFILL PLANTING WHERE NEEDED, SEE PLANT SCHEDULE L3.01 IRRIGATION: NO IRRIGATION IN WETLAND

NOTES:
 SEE CIVIL FOR ALL CURBS, CURB CUTS, VEHICULAR PAVING, AND UTILITIES.
 ALL AREAS TO BE IRRIGATED WITH EFFICIENT IRRIGATION SYSTEM AND CONTROLLER.
 ALL PLANTING TO BE OF NATIVE OR ADAPTED, DROUGHT TOLERANT SPECIES.

Phase: Approval: Ass

Schematics
Design Dev.
Permit Doc.
Bid Doc.
Const.Doc.

Drawn By:
Project Manager:
Principal In Charge:

SITE PLAN

Acceptance of the electronic file version of this drawing acknowledges the receipt and consent to the terms of the Weber Thompson Electronic Media Receipt Agreement

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0' 10' 20' 40'

1" = 20' - 0"